

LOCATION MAP

SCALE: $1" = 1,000'\pm$

SITE DATA:

Zone: C−3 Total Acreage 3 AC. ± Tax Map No.: 37.14−2−52

OWNER:

CHARLES DeMILO L.P. 6 CURTIS STREET MARBLEHEAD, MA 01945

APPLICANT:

PCSB BANK 2651 STRANG BLVD. P.O. BOX 712 YORKTOWN HEIGHTS, NY 10598

GENERAL NOTES:

- Property lines and existing conditions mapping is based on data from "Survey of Property prepared for CVS Plaza".
- Orthoimagery shown hereon taken from the Westchester County GIS database dated 2016.

<u>C-3 ZONE REQU</u>	REMENTS		
	<u>REQUIRED</u>	<u>EXISTING</u>	<u>PROPOSED</u>
Minimum Lot Area:	10,000 S.F.	127,478 S.F.	NO CHANGE
Minimum Lot Width:	100'	216 ' ±	NO CHANGE
Minimum Lot Depth:	NONE	609 ' ±	NO CHANGE
Minimum Setbacks:			
Principal Bldg: Front Yard:	30' WITHOUT PARKING	N/A	NO CHANGE
Front Yard:	75' WITH PARKING	44'±	NO CHANGE
Front Yard (Accessory Bldg):	50'	N/A	NO CHANGE
Side Yard:	NONE*	4'±	NO CHANGE
Rear Yard:	30'	98'±	NO CHANGE
Rear Yard (Accessory Bldg):	30'	N/A	NO CHANGE
Maximum Building Height (Main Bldg):	35'	LESS THAN 35'	NO CHANGE
Maximum Building Height (Accessory Bldg):	20'	LESS THAN 20'	NO CHANGE
Maximum Building Coverage:	30%	17.4%	NO CHANGE

* None, but if provided will be 10 feet; if used as one—way vehicular access, shall be 17 feet; two—way vehicular access, 25 feet; if adjoins an R District shall be 50

NO. DATE REVISION 3 Garrett Place Carmel, NY 10512 (845) 225–9690 (845) 225–9717 fax ENGINEERING, SURVEYING & LANDSCAPE ARCHITECTURE, P.C. `www.insite-eng.com

PROJECT:

SCALE

<u> PCSB — YORKTOWN BRANCH</u>

1990 COMMERCE STREET, TOWN OF YORKTOWN, WESTCHESTER CO., NY DRAWING:


OVERALL SITE PLAN


				FESSION A	1
PROJECT NUMBER	17225.100	PROJECT MANAGER	J. J. C.	DRAWING NO.	
DATE	4-25-18	DRAWN BY	M.E.U.	OP-1	
SCALE	1" = 30'	CHECKED	D.L.M.		

GRAPHIC SCALE (IN FEET) 1 inch = 30 ft.

ALTERATION OF THIS DOCUMENT, UNLESS UNDER THE DIRECTION

OF A LICENSED PROFESSIONAL ENGINEER, IS A VIOLATION OF SECTION 7209 OF ARTICLE 145 OF THE EDUCATION LAW.

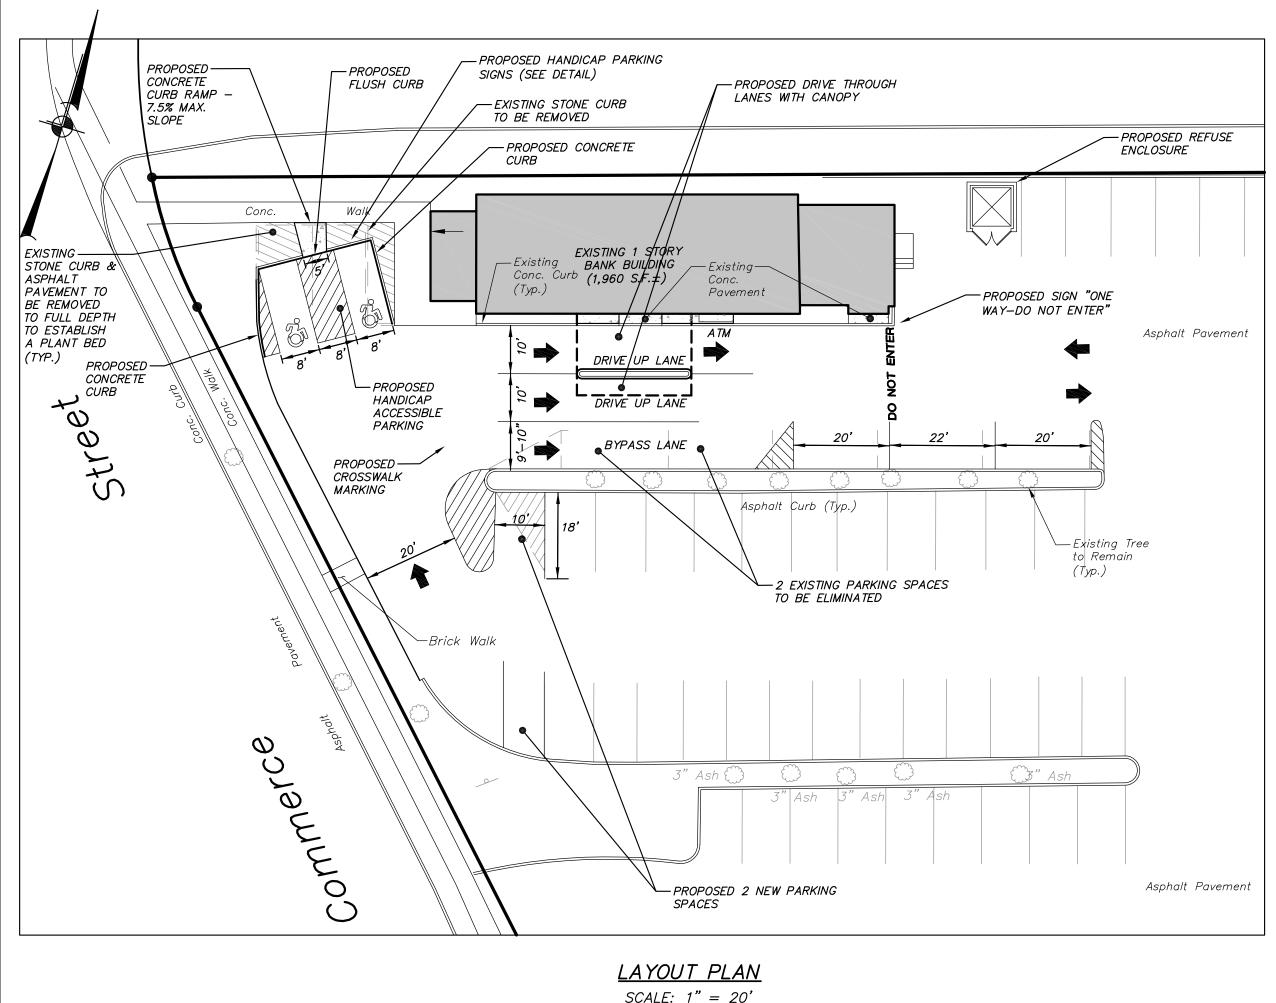

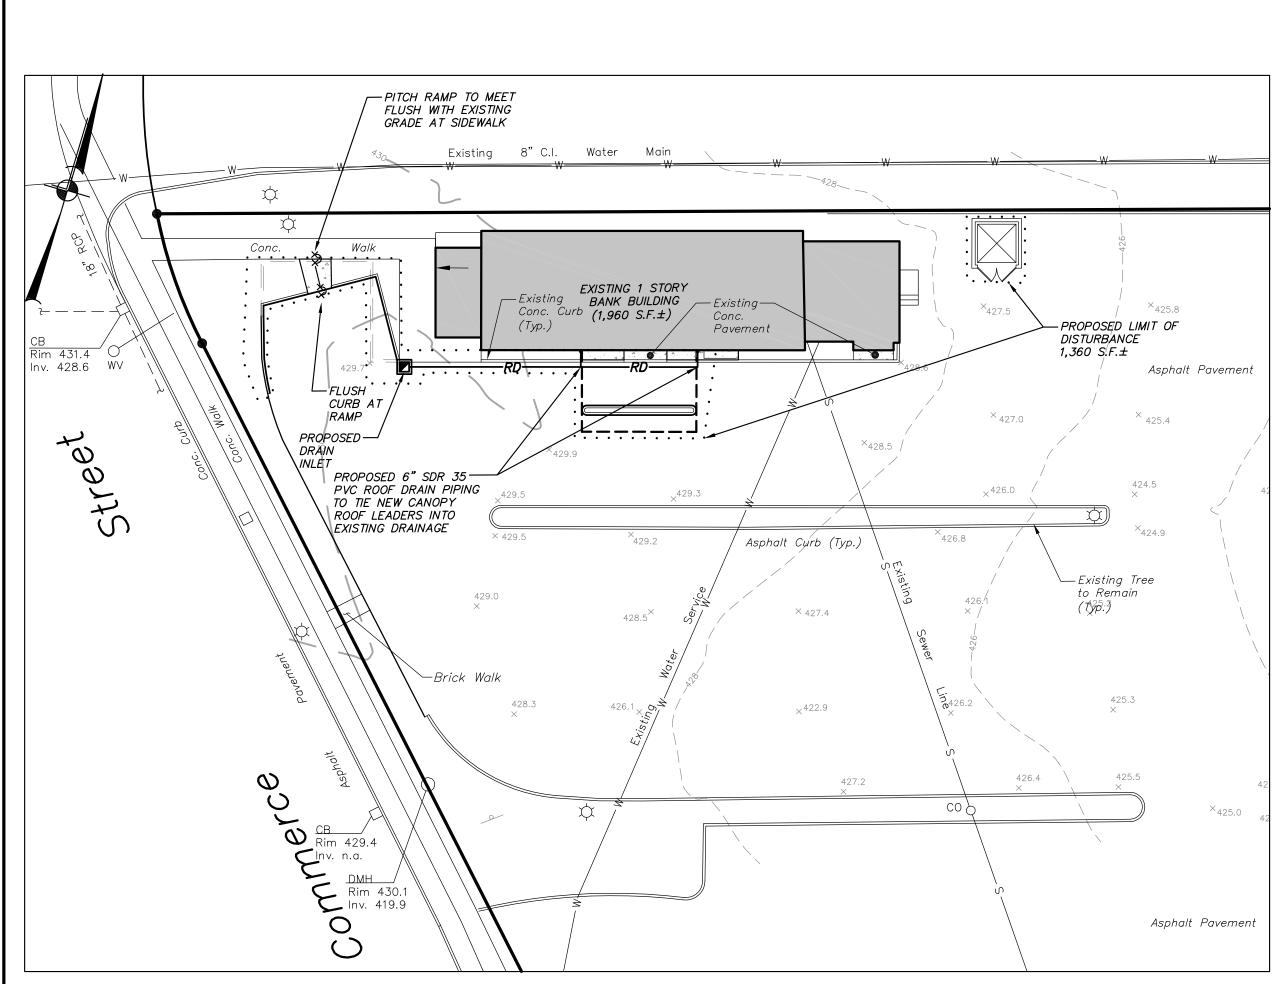



HUBBELL DECORATIVE FLOOD **SPECIFICATIONS** PRODUCT IMAGE(S) Intended Use: Ultra compact flood with wide beam NEMA 6 x 6 Traditional ½" x 14 NPS threaded distribution for lighting applications such as safety/ adjustable knuckle mounting security, facade, area, or signs; operating tempera-Listings:
• Meets DesignLights Consortium (DLC) qualifications Rugged die-cast aluminum housing with Lighting Facts dark bronze finish . IP66, Listed to UL1598 for use in wet locations · High impact UV stabilized acrylic outer lens protects LEDs and allows for cleaning/debris LED For more information visit: Vented housing isolates LED module from driver http://www.hubbelloutdoor.com/resources/warrar maximizing product life and performance DIMENSIONS Visor and vandal shield available · 7 high powered LEDs deliver 2040 lumens 5100K CCT, 67 CRI Optical/Electrical · Wide flood NEMA 6 x 6 distribution for general purpose flood and facade lighting . 120-277V operation, 50/60Hz (PC version 120V only) 26.5w, 1050mA, 78 LPW 7.5" 4.0" 1.15" 3.5" 6 lbs. · IP66 and RoHS compliant driver 114 mm 190 mm 102 mm 29 mm 89 mm 2.7 kg • 0-10V dimming driver CERTIFICATIONS/LISTINGS FSL-7 (Master carton 2 pcs.) 5.31 16.54" 10.04" 7.68"

PROPOSED LIGHT 'B' - GROUND-MOUNTED LED FLOOD LIGHT

N. T. S.

DESCRIPTION

The LRC LED Recessed Canopy Luminaire is specifically designed for recessed applications in single or double skin canopies. Three specialized optics are optimized for efficiency and uniformity, delivering high light levels on task. Typical applications include retail gas stations, convenience stores, banks and pharmacy drive thru canopies. UL/cUL listed for wet locations. SPECIFICATION FEATURES

Heavy-duty cast aluminum housing 4000K (+/- 275K) CCT and nominal with aluminum mounting frame. Wet location driver enclosure is elevated to prevent water ingress. nominal 80 CRI. 1/2" knockouts provided for wiring connections. IP66 Rated.

Dedicated optical cavities for the array of 16 individual LEDs to maximize the efficiency and control of the distribution out of each module. To enhance visual comfort, a glare-reducing optical system is utilized to maximize delivered lumens while minimizing glare. Scalable in 1, 2 or 4 Light Square LED modules to optimize 40°C ambient operations. cost and lumen output. Each reflector is precision manufactured Mounting

via injection molding and coated

coating via vacuum metallization.

Two symmetric optics and one

asymmetric optic are specifically

· 6000 6000° 6.0.0.0.0.0.0

with a highly reflective optical

designed for efficiency and

Cooper Lighting

LED driver is enclosed in a wet location box, designed to manage thermals for longevity, 120-277V 50/60 Hz, 347V 60Hz or 480V 60Hz operation. Optional proprietary circuit module designed to withstand 10kV of transient line surge, 90% lumen maintenance expected at 60,000 hours. The LRC Five-year warranty. LED Recessed Canopy Luminaire is suitable for operation in -40°C to

uniformity. Offered standard in

70 CRI, Optional 6000K CCT with

nominal 70 CRI, and 3000K with

Designed to recess in single or double skin canopies. Luminaire can be installed from above or below canopy, through 14" square cutout in the canopy.

Housing and lens frame are finished in Super TGIC polyester powder cost paint, 2.5 mil nominal thickness for superior protection against fade and wear. Standard nousing and lens frame trim finished in true white color. Optional lens frame trim colors include white, grey, black, bronze, dark platinum, and graphite metallic. RAL and color matches



M79 / LM80 Compliant DesignLights Consortium® Qualified* ENERGY DATA 0.9 Power Factor 20% Total Harmonic Distortio 0-277V/50 & 60Hz, 347V/60Hz, 10°C Minimum Temperature 10°C Maximum Ambient Temperature SHIPPING DATA Approximate Net Weight: 20-29 lbs. (9.07-13.15 kgs.)

ADH120942

McGraw-Edison

ISC/ISS/IST/ISW

WALL MOUNT LUMINAIRE

ERTIFICATION DATA

signLights Consortium® Qualified®

% Total Harmonic Distortion

20-277V/50 & 60Hz, 347V/60Hz,

-40°C Minimum Temperature

179 / LM80 Compliant

ENERGY DATA

Power Factor

SHIPPING DATA

pproximate Net Weight:


1 LightSquare

Solid State LED

IMPACT ELITE LED

PROPOSED LIGHT 'A' — LED UNDER CANOPY LIGHT N. T. S.

DESCRIPTION The Impact Elite family of wall luminaires is the ideal complement to site design. Incorporating modular LightSquares technology, the Impact Elite luminaire provides outstanding uniformity and energy-conscious illumination. Combined with a rugged construction, the Impact Elite luminaire is the ideal facade and security luminaire for zones surrounding schools, office complexes, apartments and recreational facilities. UL/cUL listed for wet locations.

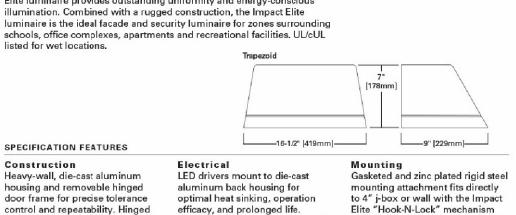


Construction Heavy-wall, die-cast aluminum housing and removable hinged door frame for precise tolerance control and repeatability. Hinged door inset for clean mating with housing surface and secured via two captive fasteners. Optional tamper-resistant Torx™ head fasteners offer vandal resistant

access to the electrical chamber. Choice of 10 patented, highefficiency AccuLED Optics™ distributions. Optics are precisely designed to shape the light output, maximizing efficiency and application spacing, AccuLED Optics technology creates consistent distributions with the scalability to meet customized application requirements. Offered sensor available. Standard in 4000K (+/- 275K) CCT and minimum 70 CRI. Optional 3000K, 5000K and 5700K CCT.

efficacy, and prolonged life. Standard drivers feature electronic for quick installation. Secured with universal voltage (120-277V two captive corrosion resistant 50/60Hz), 347V 60Hz or 480V 60Hz black oxide coated allen head set operation, greater than 0.9 power screws concealed but accessible factor, less than 20% harmonic distortion, and are suitable for operation in -40°C to 40°C ambient Finish environments. All fixtures are shipped standard with 10kV/10kA common - and differential - mode surge protection. LightSquares feature an IP66 enclosure rating and maintain greater than 90% per IESNA TM-21. Emergency egress options for -20°C ambient environments and occupancy

from bottom of fixture. Cast components finished in a five-stage super TGIC polyester powder coat paint, 2.5 mil nominal against fade and wear. Standard colors include black, bronze, grey, lumen maintenance at 60,000 hours white, dark platinum and graphite metallic. RAL and custom color matches available. Consult the McGraw-Edison Architectural Colors brochure for the complete

PROPOSED LIGHT 'C' — BUILDING— MOUNTED LED AREA LIGHT N. T. S.

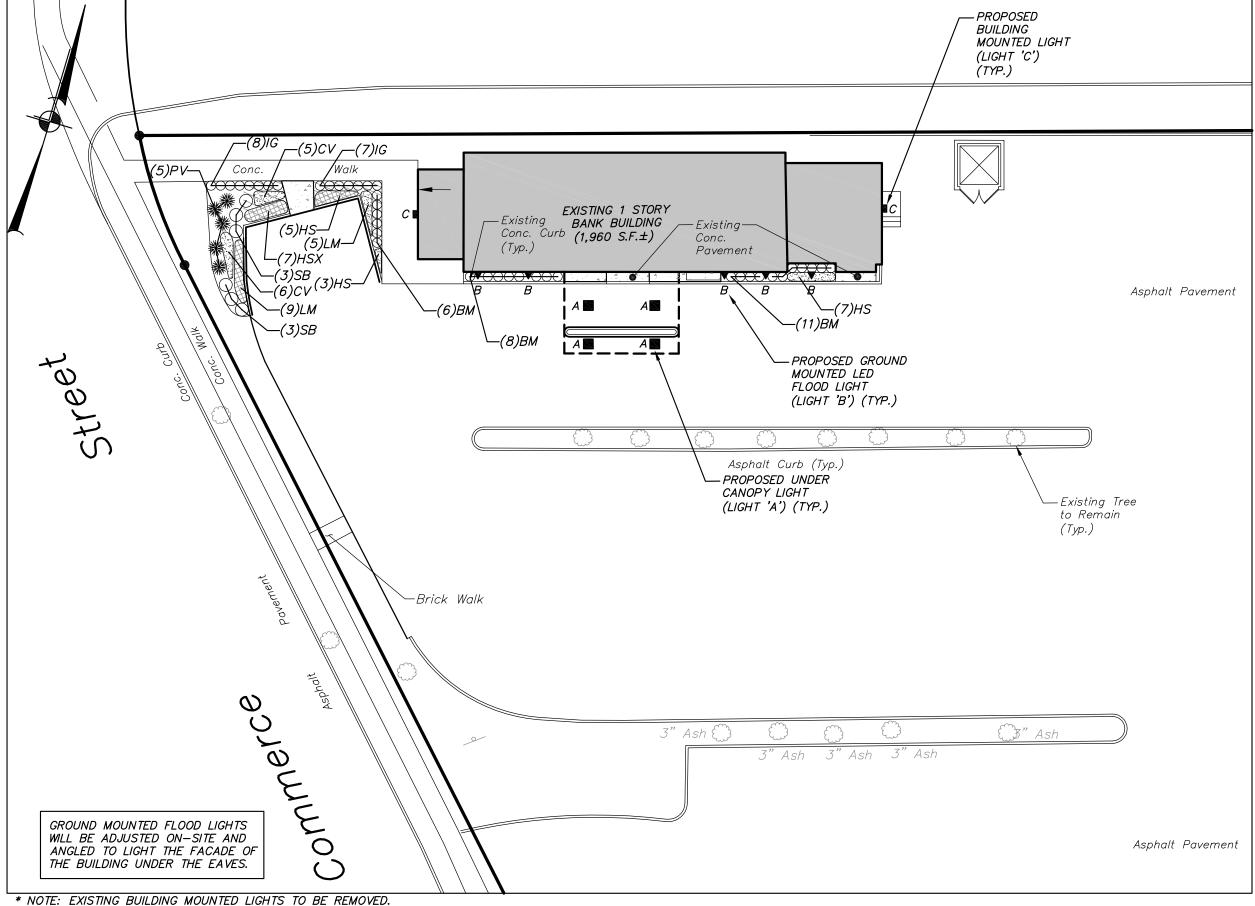

LANDSCAPING & LIGHTING PLAN SCALE: 1" = 20'


	SCHEMATIC PLANT LIST		
KEY	BOTANICAL/COMMON NAME	SIZE	ROOT
	SHRUBS & PERENNIALS		
ВМ	Buxus microphylla 'Green Gem' / Green Gem Boxwood	#1 CONT.	15" O.C.
CV	Coreopsis vert. 'Moonbeam' / Moonbeam Coreopsis	#2 CONT.	18" O.C.
HS	Hemerocallis 'Stella D'Oro' / Daylily	#2 CONT.	18" O.C.
IG	llex glabra 'Shamrock' / Compact Inkberry	18"-24" HT.	#3 CONT.
LM	Liriope muscari / Lilyturf	15"-18" SPR.	#3 CONT.
PV	Panicum virg. 'Shenandoah' / Shenandoah Switchgrass	#2 CONT.	CONT.
SB	Spirea bumalda 'Gold Mound' / Gold Mound Spirea	15"-18" SPR.	#3 CONT.

GENERAL PLANTING NOTES:

- 1. All proposed planting beds to receive a 12" min. depth of topsoil. Soil amendments and fertilizer application rates shall be determined based on specific testing of topsoil material.
- 2. Any new soils added will be amended as required by results of soil testing and placed using a method that will not cause compaction.
- 3. All plant material to be nursery grown.
- 4. Plants shall conform with ANSI Z60.1 American Standard for Nursery Stock in all ways including dimensions.
- 5. Plant material shall be taken from healthy nursery stock.
- 6. All plants shall be grown under climate conditions similar to those in the locality of the project.
- 7. Plants shall be planted in all locations designed on the plan or as staked in the field by the Landscape Architect.
- 8. The location and layout of landscape plants shown on the site plan shall take precedence in any discrepancies between the quantities of plants shown on the plans and the quantity of plants in the Plant List.
- 9. Provide a 3" layer of shredded bark mulch (or as specified) over entire watering saucer at all tree pits or over entire planting bed. Do not place mulch within 3" of tree or shrub trunks.
- 10. All landscape plantings shall be maintained in a healthy condition at all times. Any dead or diseased plants shall immediately be replaced "in kind" by the contractor (during warranty period) or project owner.

NO. DATE

NUMBER

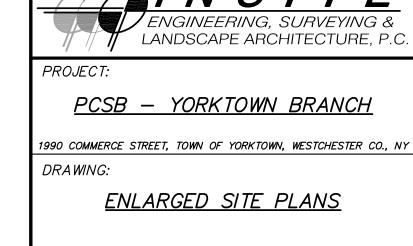

MANAGER DRAWN

CHECKED

PROJECT *17225.100*

4-25-18

1" = 20'

SHEET DRAWING NO.

3 Garrett Place

Carmel, NY 10512

(845) 225-9690

(845) 225-9717 fax

www.insite-eng.com


REVISION

M.E.U.

D.L.M.

GRAPHIC SCALE (IN FEET) 1 inch = 20 ft

ALTERATION OF THIS DOCUMENT, UNLESS UNDER THE DIRECTION OF A LICENSED PROFESSIONAL ENGINEER, IS A VIOLATION OF SECTION 7209 OF ARTICLE 145 OF THE EDUCATION LAW.

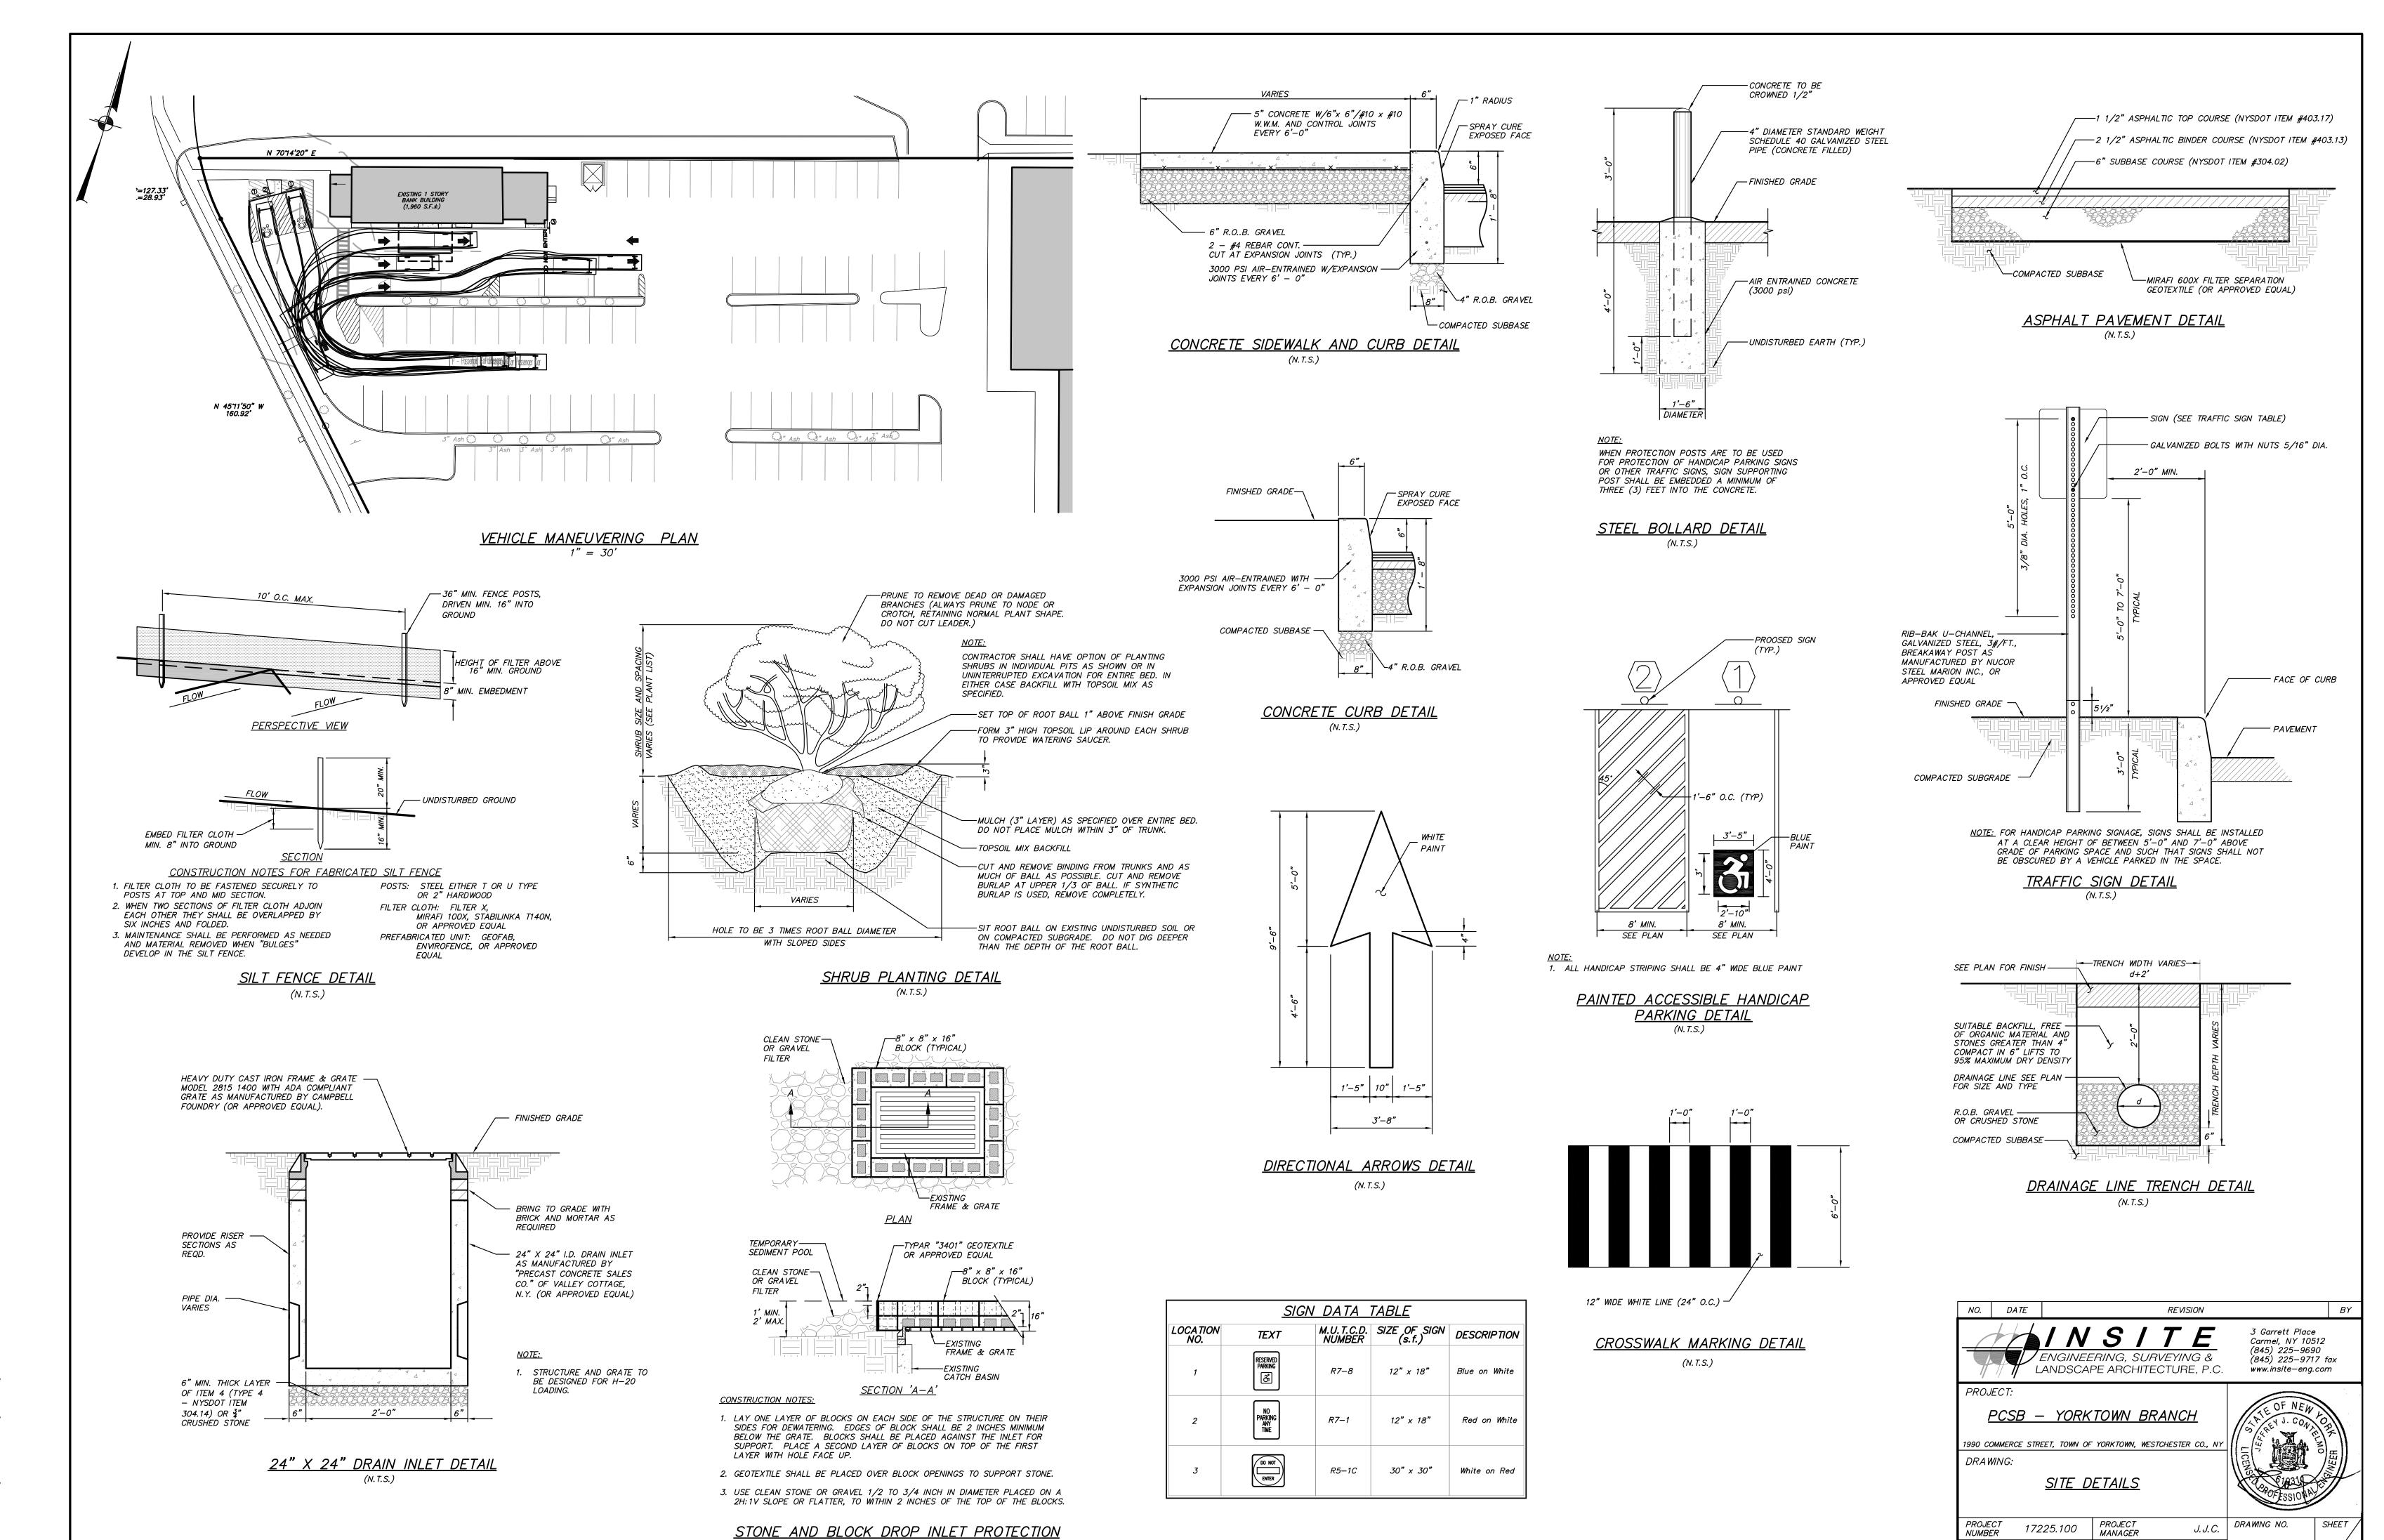

4–25–18

AS SHOWN

CHECKED

M.E.U.

D.L.M.

AT EXISTING DRAIN INLET DETAIL

(N.T.S.)

ALTERATION OF THIS DOCUMENT, UNLESS UNDER THE DIRECTION OF A LICENSED PROFESSIONAL ENGINEER, IS A VIOLATION OF

SECTION 7209 OF ARTICLE 145 OF THE EDUCATION LAW.