SITE PLAN APPROVAL DRAWINGS

TACO BELL REDEVELOPMENT

TAX MAP SECTION 36.05 | BLOCK 1 | LOT 16 3605 CROMPOND ROAD

TOWN OF YORKTOWN, NY



Site Planner, Civil & Traffic Engineer, and Landscape Architect:

Applicant:

KAI CARMEL LLC **25 ROUTE 59**

NYACK, NY 10960 (201) 863-3670


Owner:

3605 PROPERTIES LLC 45 KNOLLWOOD ROAD, SUITE 101 ELMSFORD NY, 10523

Surveyor:

BADEY & WATSON, SURVEYING & ENGINEERING, P.C. 3063 ROUTE 9

COLD SPRING, NY 10516 (845) 265-9217

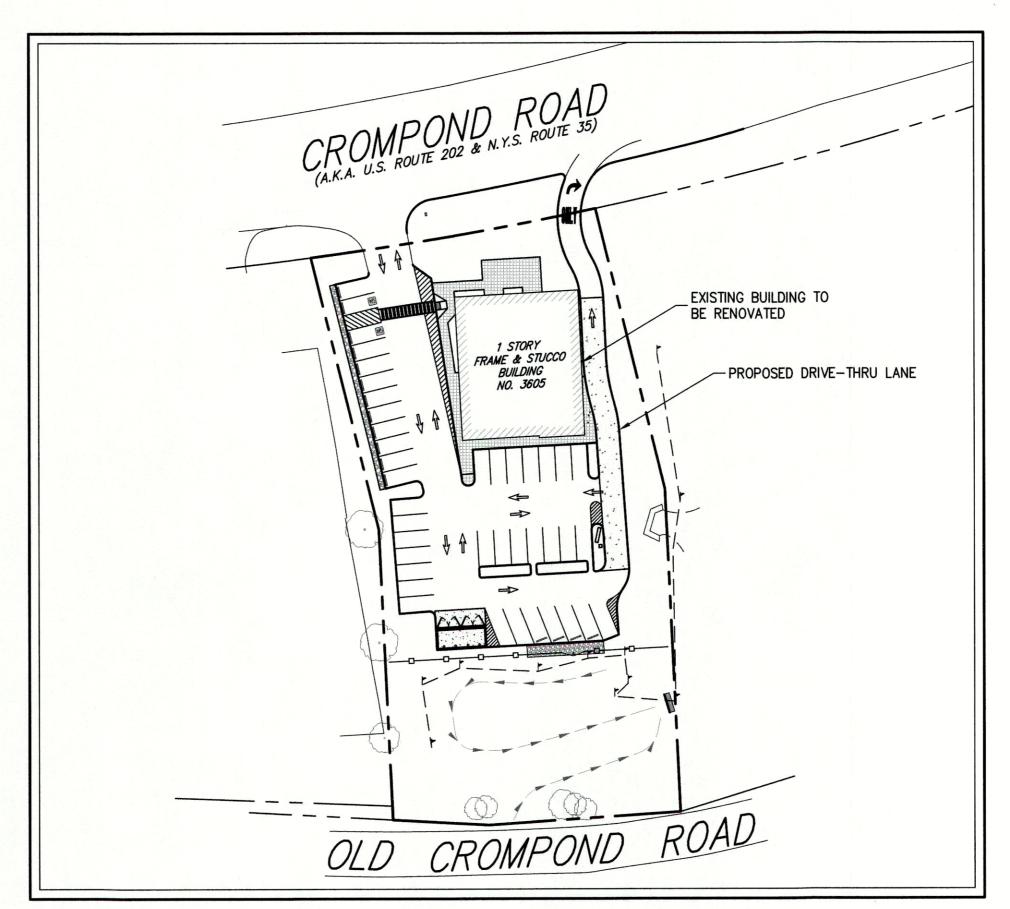



JMC Drawing List:

C-000 COVER SHEET

C-010 EXISTING CONDITIONS MAP

C-020 SITE DEMOLITION PLAN

C-100 SITE LAYOUT PLAN

C-110 TRUCK TURNING ANALYSES

PASSENGER VEHICLE TURNING ANALYSES

SITE GRADING AND UTILITIES PLAN

SITE EROSION AND SEDIMENT CONTROL PLAN

CONSTRUCTION DETAILS

C-901 CONSTRUCTION DETAILS

C-902 CONSTRUCTION DETAILS C-903 CONSTRUCTION DETAILS

C-904 CONSTRUCTION DETAILS

CONSTRUCTION DETAILS

L-100 LANDSCAPING / WETLAND MITIGATION PLAN

	E OF L	AND USE		
SECTION 36.05, BLOCK 1, LOT 16 ZONE "C-4" - "COMMERCIAL GEN PROPOSED USE: FAST-FOOD REST		RETAIL		
DESCRIPTION		REQUIRED	EXISTING	PROPOSED
LOT AREA	(ACRES)	N/A	1.06	1.06
LOT WIDTH AT FRONT LINE OF MAIN BUILDING	(FEET)	25	150	150
LOT DEPTH	(FEET)	100	308	308
BUILDING HEIGHT	(FEET)	35	<35	20.5
LOT COVERAGE BY BUILDING	(PERCENT)	30	10.4	10.4
YARDS				
FRONT BUILDING SETBACK	(FEET)	15	31.4	31.4
REAR BUILDING SETBACK	(FEET)	30	198.7	198.7
SIDE BUILDING SETBACK	(FEET)	17 / 25 ⁽¹⁾	19.0 / 53.4	19.0 / 53.4
PARKING SUMMARY				
STANDARD SPACES	(SPACES)	40	43	31
ACCESSIBLE SPACES	(SPACES)	2	4	2
DEFERRED PARKING SPACES	(SPACES)	N/A	N/A	2 ⁽³⁾
EMPLOYEE PARKING SPACES	(SPACES)	N/A	N/A	7
TOTAL SPACES	(SPACES)	42 ⁽²⁾	47	42 ⁽³⁾

1. PER SECTION 300 ATTACHMENT 2 OF THE TOWN OF YORKTOWN CODE, THE SIDE YARD SETBACK SHALL BE 17 FEET IF USED AS A ONE-WAY VEHICULAR ACCESS, AND 25 FEET IF USED AS A TWO-WAY VEHICULAR ACCESS.

2. PER SECTION 300-182(A)(5) OF THE TOWN OF YORKTOWN ZONING CODE, FOR RESTAURANT USES, 1 PARKING SPACE IS REQUIRED FOR EACH 50 S.F. OF FLOOR AREA DEVOTED TO PATRON USE, PLUS 1 PARKING SPACE FOR EACH 100 SQUARE FEET OF FLOOR AREA DEVOTED TO FOOD PREPARATION

TACO-BELL RESTAURANT: 1,150 S.F. OF FLOOR AREA DEVOTED TO PATRON USE / 50 = 23 PARKING SPACES


1,120 S.F. OF FLOOR AREA DEVOTED TO FOOD PREPARATION OR ANCILLARY USE / 100 = 11.20 PARKING SPACES 420 S.F. OF REMAINING FLOOR AREA / 250 = 1.68 PARKING SPACES


FUTURE RETAIL TENANT: 1,720 S.F. / 250 = 6.88 PARKING SPACES

OR ANCILLARY USE. FOR RETAIL USES, 4 PARKING SPACES ARE REQUIRED FOR EACH 1,000 S.F. OF FLOOR AREA.

TOTAL: 42 PARKING SPACES REQUIRED

3. IN ACCORDANCE WITH THE TOWN OF YORKTOWN CODE SECTION 195-42, THE CONSTRUCTION OF TWO PARKING SPACES ARE PROPOSED TO BE

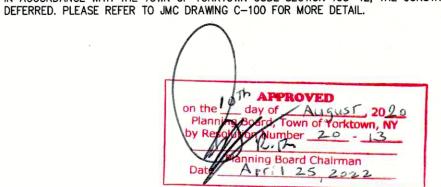

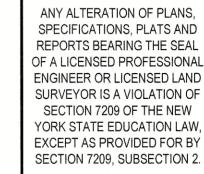




NOT TO SCALE 12/10/2019


John Meyer Consulting, Inc. 120 BEDFORD ROAD • ARMONK, NY 10504 voice 914.273.5225 • fax 914.273.2102 www.jmcpllc.com

Project No: 19101 19101-SITE-CD COVER COVER.s

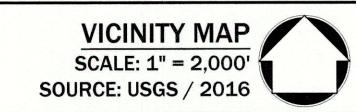

GENERAL CONSTRUCTION NOTES APPLY TO ALL WORK HEREIN:

- PRIOR TO CONSTRUCTION, THE CONTRACTOR SHALL CALL 811 "DIG SAFELY" (1-800-962-7962) TO HAVE UNDERGROUND UTILITIES LOCATED INCLUDING ARRANGING FOR A PRIVATE MARKOUT ON-SITE WHERE APPLICABLE. EXPLORATORY EXCAVATIONS SHALL COMPLY WITH CODE 753 REQUIREMENTS. NO WORK SHALL COMMENCE UNTIL ALL THE OPERATORS HAVE NOTIFIED THE CONTRACTOR THAT THEIR UTILITIES HAVE BEEN LOCATED. THE CONTRACTOR SHALL BE RESPONSIBLE FOR THE PRESERVATION OF ALL PUBLIC AND PRIVATE UNDERGROUND AND SURFACE UTILITIES AND STRUCTURES AT OR ADJACENT TO THE SITE OF CONSTRUCTION, INSOFAR AS THEY MAY BE ENDANGERED BY THE CONTRACTOR'S OPERATIONS. THIS SHALL HOLD TRUE WHETHER OR NOT THEY ARE SHOWN ON THE CONTRACT DRAWINGS. IF THEY ARE SHOWN ON THE DRAWINGS, THEIR LOCATIONS ARE NOT GUARANTEED EVEN THOUGH THE INFORMATION WAS OBTAINED FROM THE BEST AVAILABLE SOURCES, AND IN ANY EVENT, OTHER UTILITIES ON THESE PLANS MAY BE ENCOUNTERED IN THE FIELD. THE CONTRACTOR SHALL, AT HIS OWN EXPENSE, IMMEDIATELY REPAIR OR REPLACE ANY STRUCTURES OR UTILITIES THAT HE DAMAGES, AND SHALL CONSTANTLY PROCEED WITH CAUTION TO PREVENT UNDUE
- . CONTRACTOR SHALL HAND DIG TEST PITS TO VERIFY THE LOCATION OF ALL EXISTING UNDERGROUND UTILITIES PRIOR TO THE START OF CONSTRUCTION. CONTRACTOR SHALL VERIFY EXISTING UTILITIES DEPTHS AND ADVISE OF ANY CONFLICTS WITH PROPOSED UTILITIES. IF CONFLICTS ARE PRESENT. THE OWNER'S FIELD REPRESENTATIVE, JMC, PLLC AND THE APPLICABLE MUNICIPALITY OR AGENCY SHALL BE NOTIFIED IN WRITING. THE EXISTING/PROPOSED UTILITIES RELOCATION SHALL BE DESIGNED BY JMC, PLLC.
- 3. CONTRACTOR IS RESPONSIBLE FOR OBTAINING ANY AND ALL LOCAL PERMITS REQUIRED.
- 4. ALL WORK SHALL BE DONE IN STRICT COMPLIANCE WITH ALL APPLICABLE NATIONAL, STATE, AND LOCAL CODES, STANDARDS, ORDINANCES, RULES, AND REGULATIONS. ALL CONSTRUCTION WORK SHALL BE PERFORMED IN ACCORDANCE WITH ALL SAFETY CODES. APPLICABLE SAFETY CODES MEAN THE LATEST EDITION INCLUDING ANY AND ALL AMENDMENTS. REVISIONS. AND ADDITIONS THERETO, TO THE FEDERAL DEPARTMENT OF LABOR, OCCUPATIONAL SAFETY AND HEALTH ADMINISTRATION'S OCCUPATIONAL SAFETY AND HEALTH STANDARDS (OSHA); AND APPLICABLE SAFETY, HEALTH REGULATIONS AND BUILDING CODES FOR CONSTRUCTION IN THE STATE OF NEW YORK. THE CONTRACTOR SHALL BE RESPONSIBLE FOR GUARDING AND PROTECTING ALL OPEN EXCAVATIONS IN ACCORDANCE WITH THE PROVISION OF SECTION 107-05 (SAFETY AND HEALTH REQUIREMENTS) OF THE NYSDOT STANDARD SPECIFICATIONS. IF THE CONTRACTOR PERFORMS ANY HAZARDOUS CONSTRUCTION PRACTICES, ALL OPERATIONS IN THE AFFECTED AREA SHALL BE DISCONTINUED AND IMMEDIATE ACTION SHALL BE TAKEN TO CORRECT THE SITUATION TO THE SATISFACTION OF THE APPROVAL AUTHORITY HAVING JURISDICTION.
- 5. CONTRACTOR SHALL MAINTAIN ACCESS TO ALL PROPERTIES AFFECTED BY THE SCOPE OF WORK SHOWN HEREON AT ALL TIMES TO THE SATISFACTION OF THE OWNERS REPRESENTATIVE. RAMPING CONSTRUCTION TO PROVIDE ACCESS MAY BE CONSTRUCTED WITH SUBBASE MATERIAL EXCEPT THAT TEMPORARY ASPHALT CONCRETE SHALL BE PLACED AS DIRECTED BY THE ENGINEER. THE CONTRACTOR SHALL BE RESPONSIBLE FOR PROVIDING SAFE PEDESTRIAN ACCESS AT ALL TIMES.
- 6. CONTRACTOR SHALL MAINTAIN THE INTEGRITY OF EXISTING PAVEMENT TO REMAIN.

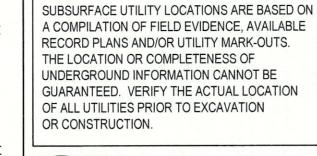





Revision	Date	Ву
REVISED PER TOWN COMMENTS	03/13/2020	PD
REVISED PER NYCDEP COMMENTS	06/12/2020	PD
REVISED PER TOWN COMMENTS	07/28/2020	PD
ISSUED FOR STAGE 2 NYSDOT REVIEW	11/11/2020	KRM
ISSUED CONSTRUCTION DRAWINGS	02/19/2021	PD
 Provious Editions Obsolate		


JMC Site Development Consultants, LLC

JMC Planning, Engineering, Landscape


Architecture & Land Surveying, PLLC

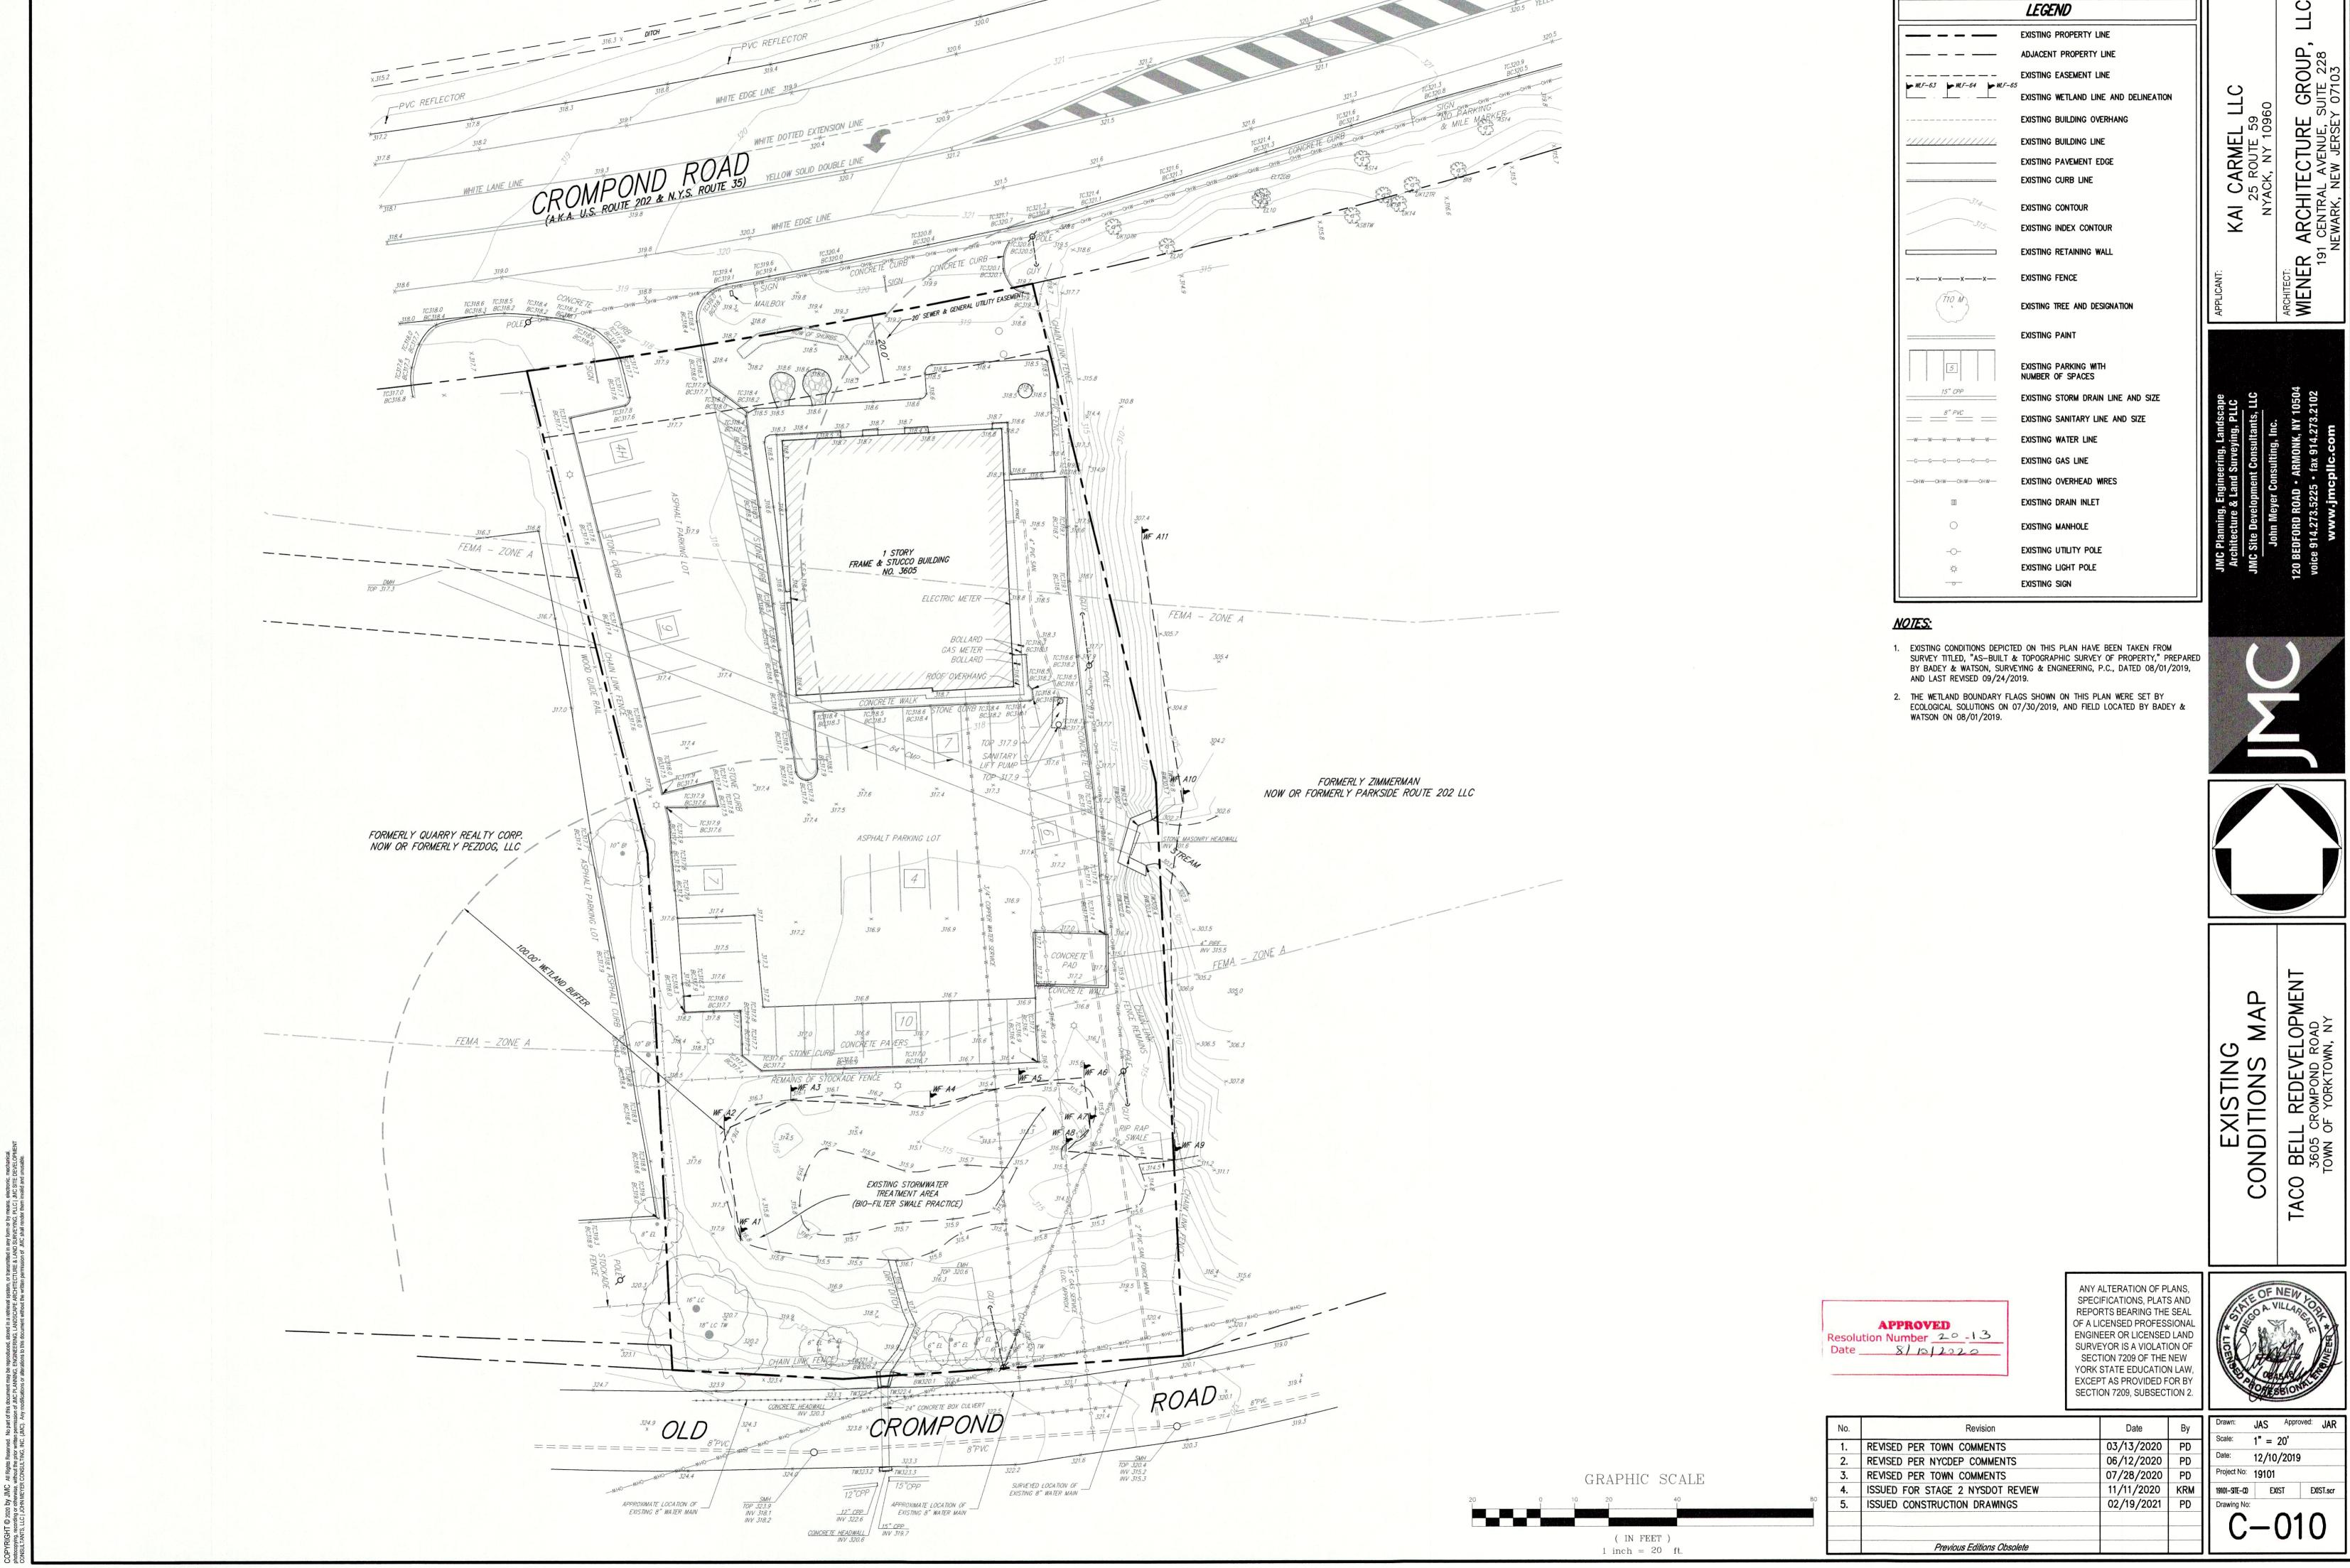

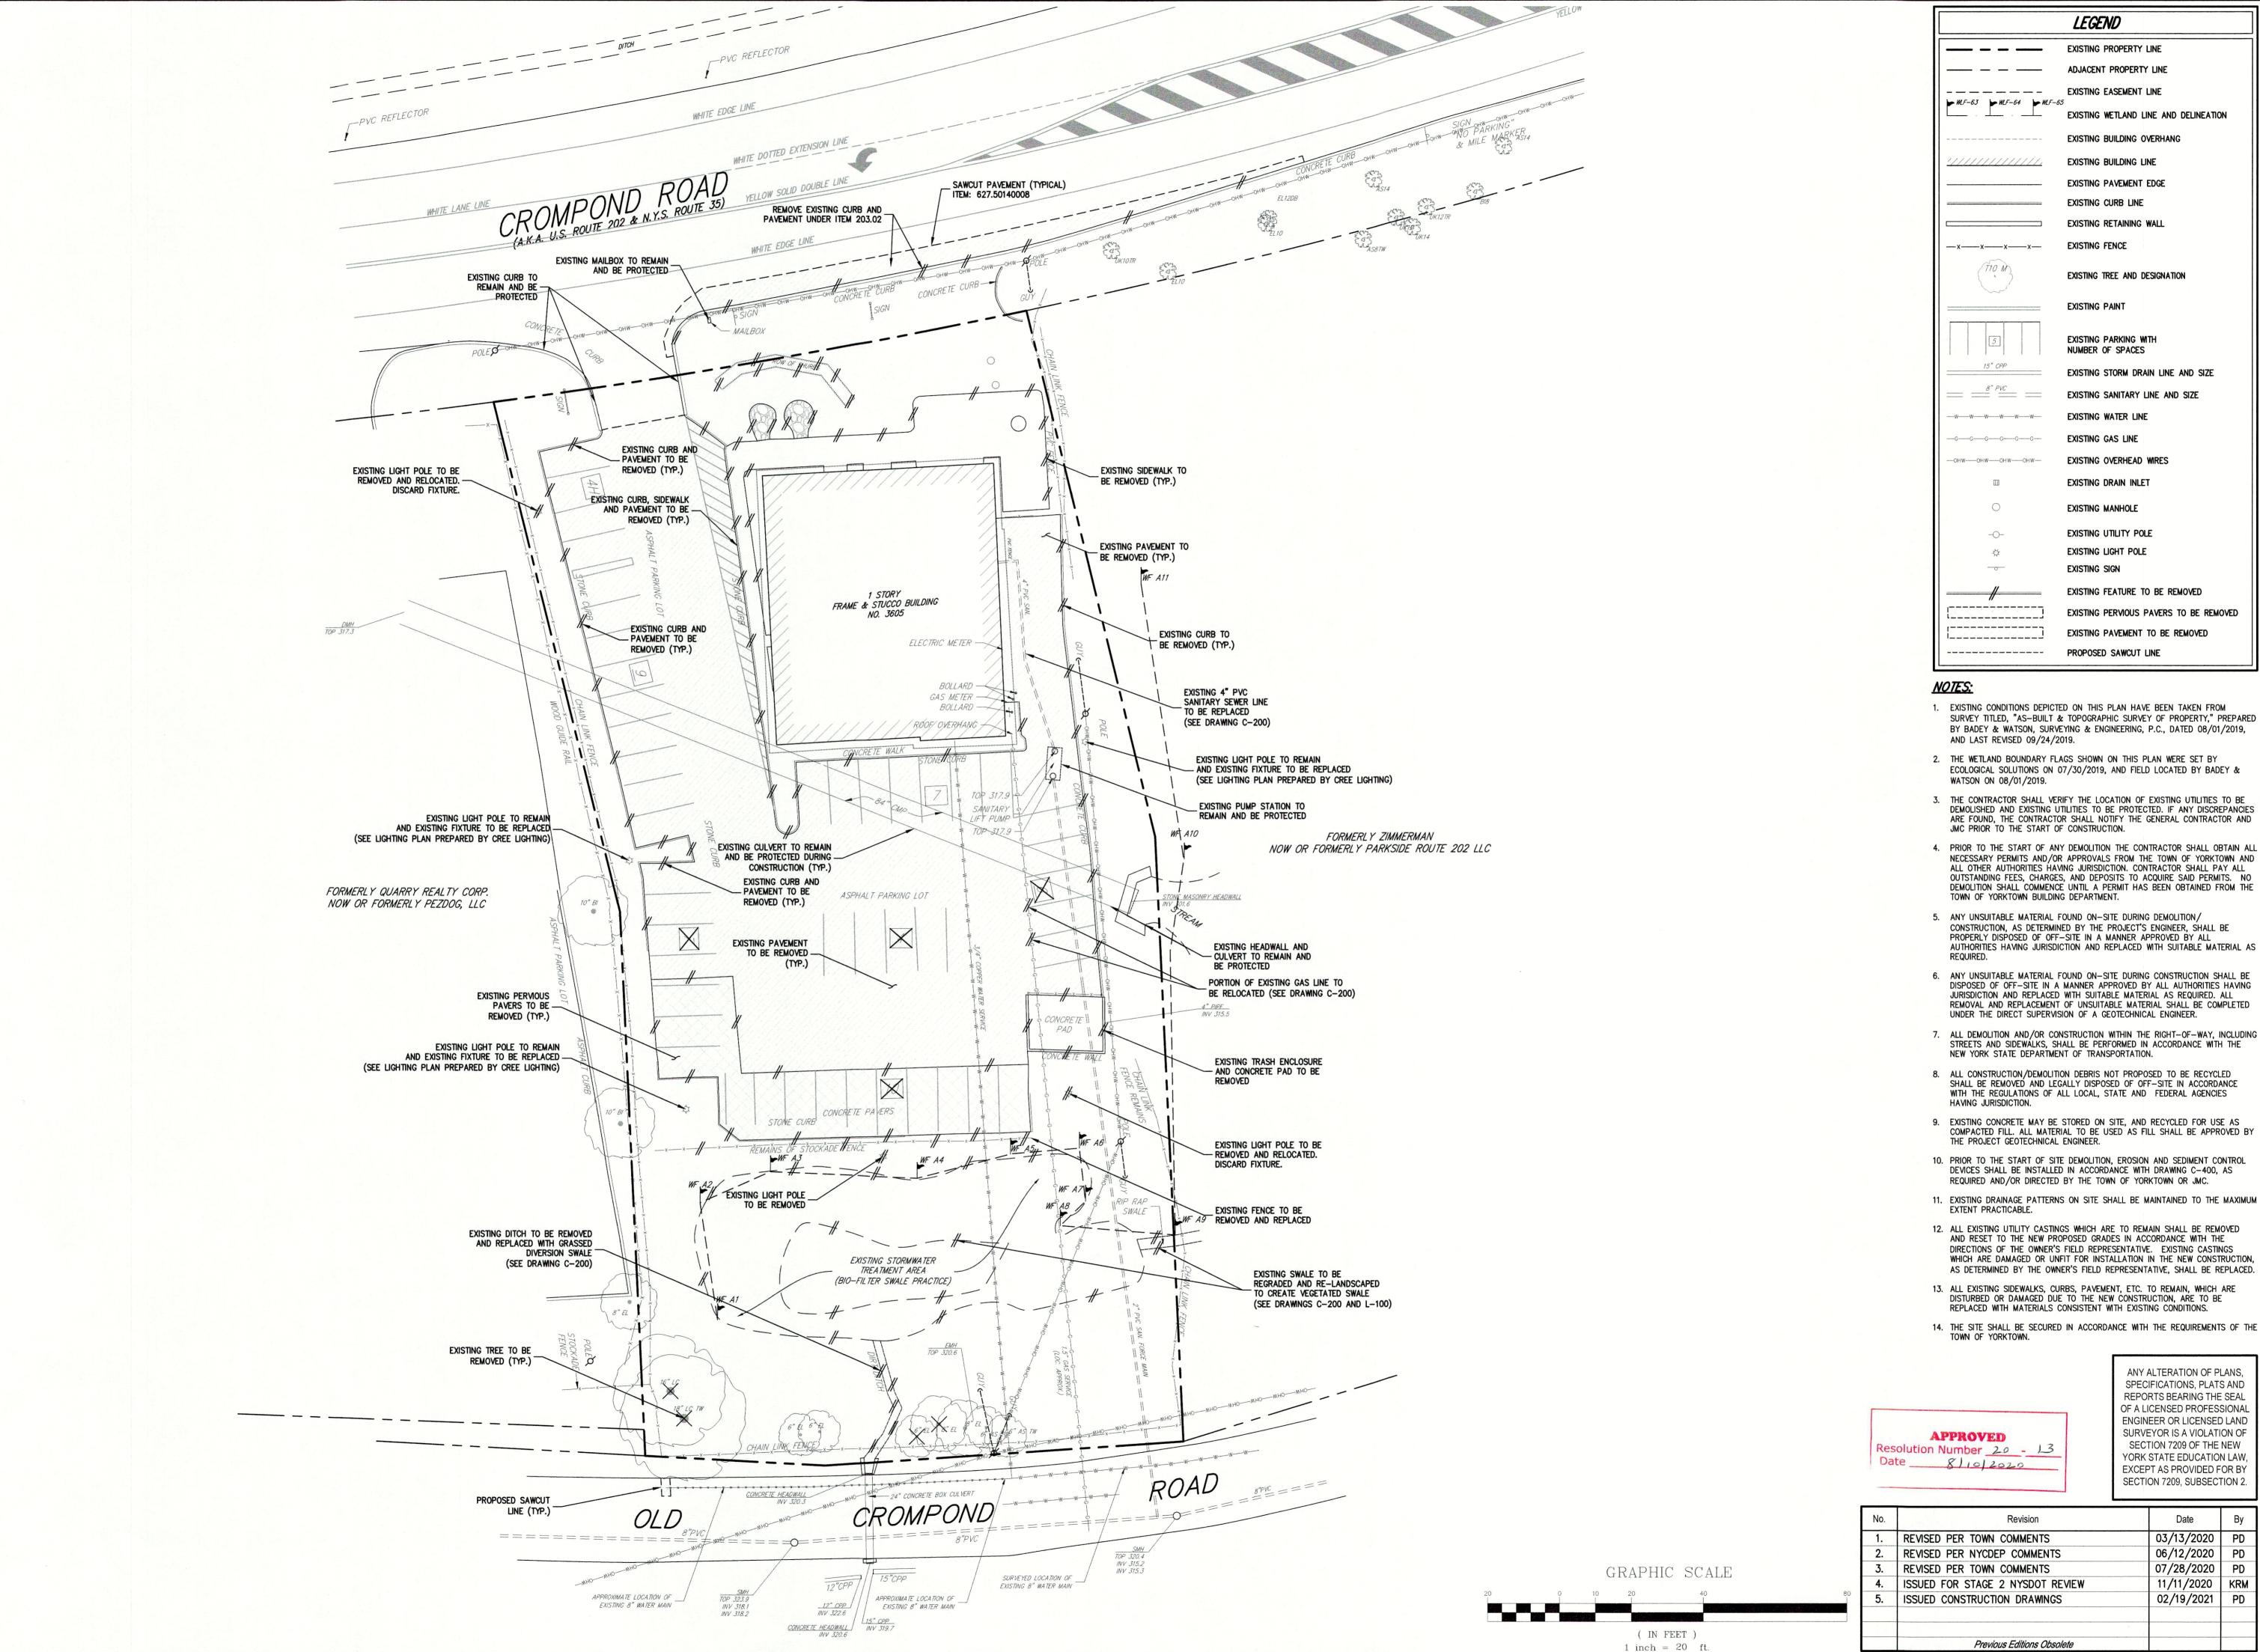

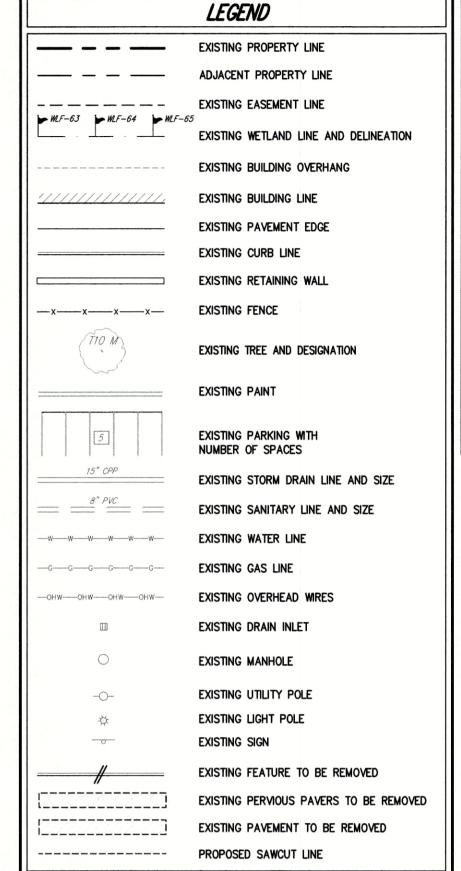

- 1. EXISTING CONDITIONS DEPICTED ON THIS PLAN HAVE BEEN TAKEN FROM SURVEY TITLED, "AS-BUILT & TOPOGRAPHIC SURVEY OF PROPERTY," PREPARED BY BADEY & WATSON, SURVEYING & ENGINEERING, P.C., DATED 08/01/2019, AND LAST REVISED 09/24/2019.
- 2. THE WETLAND BOUNDARY FLAGS SHOWN ON THIS PLAN WERE SET BY ECOLOGICAL SOLUTIONS ON 07/30/2019, AND FIELD LOCATED BY BADEY & WATSON ON 08/01/2019.
- ARE FOUND, THE CONTRACTOR SHALL NOTIFY THE GENERAL CONTRACTOR AND JMC PRIOR TO THE START OF CONSTRUCTION. 4. PRIOR TO THE START OF ANY DEMOLITION THE CONTRACTOR SHALL OBTAIN ALL
- ALL OTHER AUTHORITIES HAVING JURISDICTION. CONTRACTOR SHALL PAY ALL OUTSTANDING FEES, CHARGES, AND DEPOSITS TO ACQUIRE SAID PERMITS. NO DEMOLITION SHALL COMMENCE UNTIL A PERMIT HAS BEEN OBTAINED FROM THE TOWN OF YORKTOWN BUILDING DEPARTMENT. 5. ANY UNSUITABLE MATERIAL FOUND ON-SITE DURING DEMOLITION/ CONSTRUCTION, AS DETERMINED BY THE PROJECT'S ENGINEER, SHALL BE
- AUTHORITIES HAVING JURISDICTION AND REPLACED WITH SUITABLE MATERIAL AS 6. ANY UNSUITABLE MATERIAL FOUND ON-SITE DURING CONSTRUCTION SHALL BE DISPOSED OF OFF-SITE IN A MANNER APPROVED BY ALL AUTHORITIES HAVING JURISDICTION AND REPLACED WITH SUITABLE MATERIAL AS REQUIRED. ALL
- REMOVAL AND REPLACEMENT OF UNSUITABLE MATERIAL SHALL BE COMPLETED UNDER THE DIRECT SUPERVISION OF A GEOTECHNICAL ENGINEER.
- 7. ALL DEMOLITION AND/OR CONSTRUCTION WITHIN THE RIGHT-OF-WAY, INCLUDING STREETS AND SIDEWALKS, SHALL BE PERFORMED IN ACCORDANCE WITH THE NEW YORK STATE DEPARTMENT OF TRANSPORTATION.
- 8. ALL CONSTRUCTION/DEMOLITION DEBRIS NOT PROPOSED TO BE RECYCLED SHALL BE REMOVED AND LEGALLY DISPOSED OF OFF-SITE IN ACCORDANCE WITH THE REGULATIONS OF ALL LOCAL, STATE AND FEDERAL AGENCIES HAVING JURISDICTION.
- 9. EXISTING CONCRETE MAY BE STORED ON SITE, AND RECYCLED FOR USE AS COMPACTED FILL. ALL MATERIAL TO BE USED AS FILL SHALL BE APPROVED BY THE PROJECT GEOTECHNICAL ENGINEER.
- 10. PRIOR TO THE START OF SITE DEMOLITION, EROSION AND SEDIMENT CONTROL DEVICES SHALL BE INSTALLED IN ACCORDANCE WITH DRAWING C-400, AS REQUIRED AND/OR DIRECTED BY THE TOWN OF YORKTOWN OR JMC.
- 11. EXISTING DRAINAGE PATTERNS ON SITE SHALL BE MAINTAINED TO THE MAXIMUM EXTENT PRACTICABLE.
- 12. ALL EXISTING UTILITY CASTINGS WHICH ARE TO REMAIN SHALL BE REMOVED AND RESET TO THE NEW PROPOSED GRADES IN ACCORDANCE WITH THE DIRECTIONS OF THE OWNER'S FIELD REPRESENTATIVE. EXISTING CASTINGS WHICH ARE DAMAGED OR UNFIT FOR INSTALLATION IN THE NEW CONSTRUCTION, AS DETERMINED BY THE OWNER'S FIELD REPRESENTATIVE, SHALL BE REPLACED.
- 13. ALL EXISTING SIDEWALKS, CURBS, PAVEMENT, ETC. TO REMAIN, WHICH ARE DISTURBED OR DAMAGED DUE TO THE NEW CONSTRUCTION, ARE TO BE REPLACED WITH MATERIALS CONSISTENT WITH EXISTING CONDITIONS.
- 14. THE SITE SHALL BE SECURED IN ACCORDANCE WITH THE REQUIREMENTS OF THE

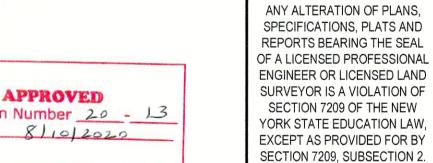

٥.	Revision	Date	Ву
	REVISED PER TOWN COMMENTS	03/13/2020	PD
	REVISED PER NYCDEP COMMENTS	06/12/2020	PD
	REVISED PER TOWN COMMENTS	07/28/2020	PD
	ISSUED FOR STAGE 2 NYSDOT REVIEW	11/11/2020	KRM
	ISSUED CONSTRUCTION DRAWINGS	02/19/2021	PD
	Previous Editions Obsolete	· .	
	Frevious Editions Obsolete		

,		-	
Drawn:	JAS	Approved:	JAR
Scale:	1" =	20'	
Date:	12/10	/2019	
Project No:	19101		
19101-SITE-CD	DEI	(O E)	(IST.scr
Drawing No:			_
C-	- ()2()
	Scale: Date: Project No: 19101-SITE-CD	Scale: 1" = 2 Date: 12/10, Project No: 19101 19101-SITE-CD DEN	Scale: 1" = 20' Date: 12/10/2019 Project No: 19101 19101-SITE-CD DEMO EX


REDEVELOPMENT
ROMPOND ROAD
PORKTOWN, NY

BELL 1 3605 CRO TOWN OF

8

 \circ

GROUP,

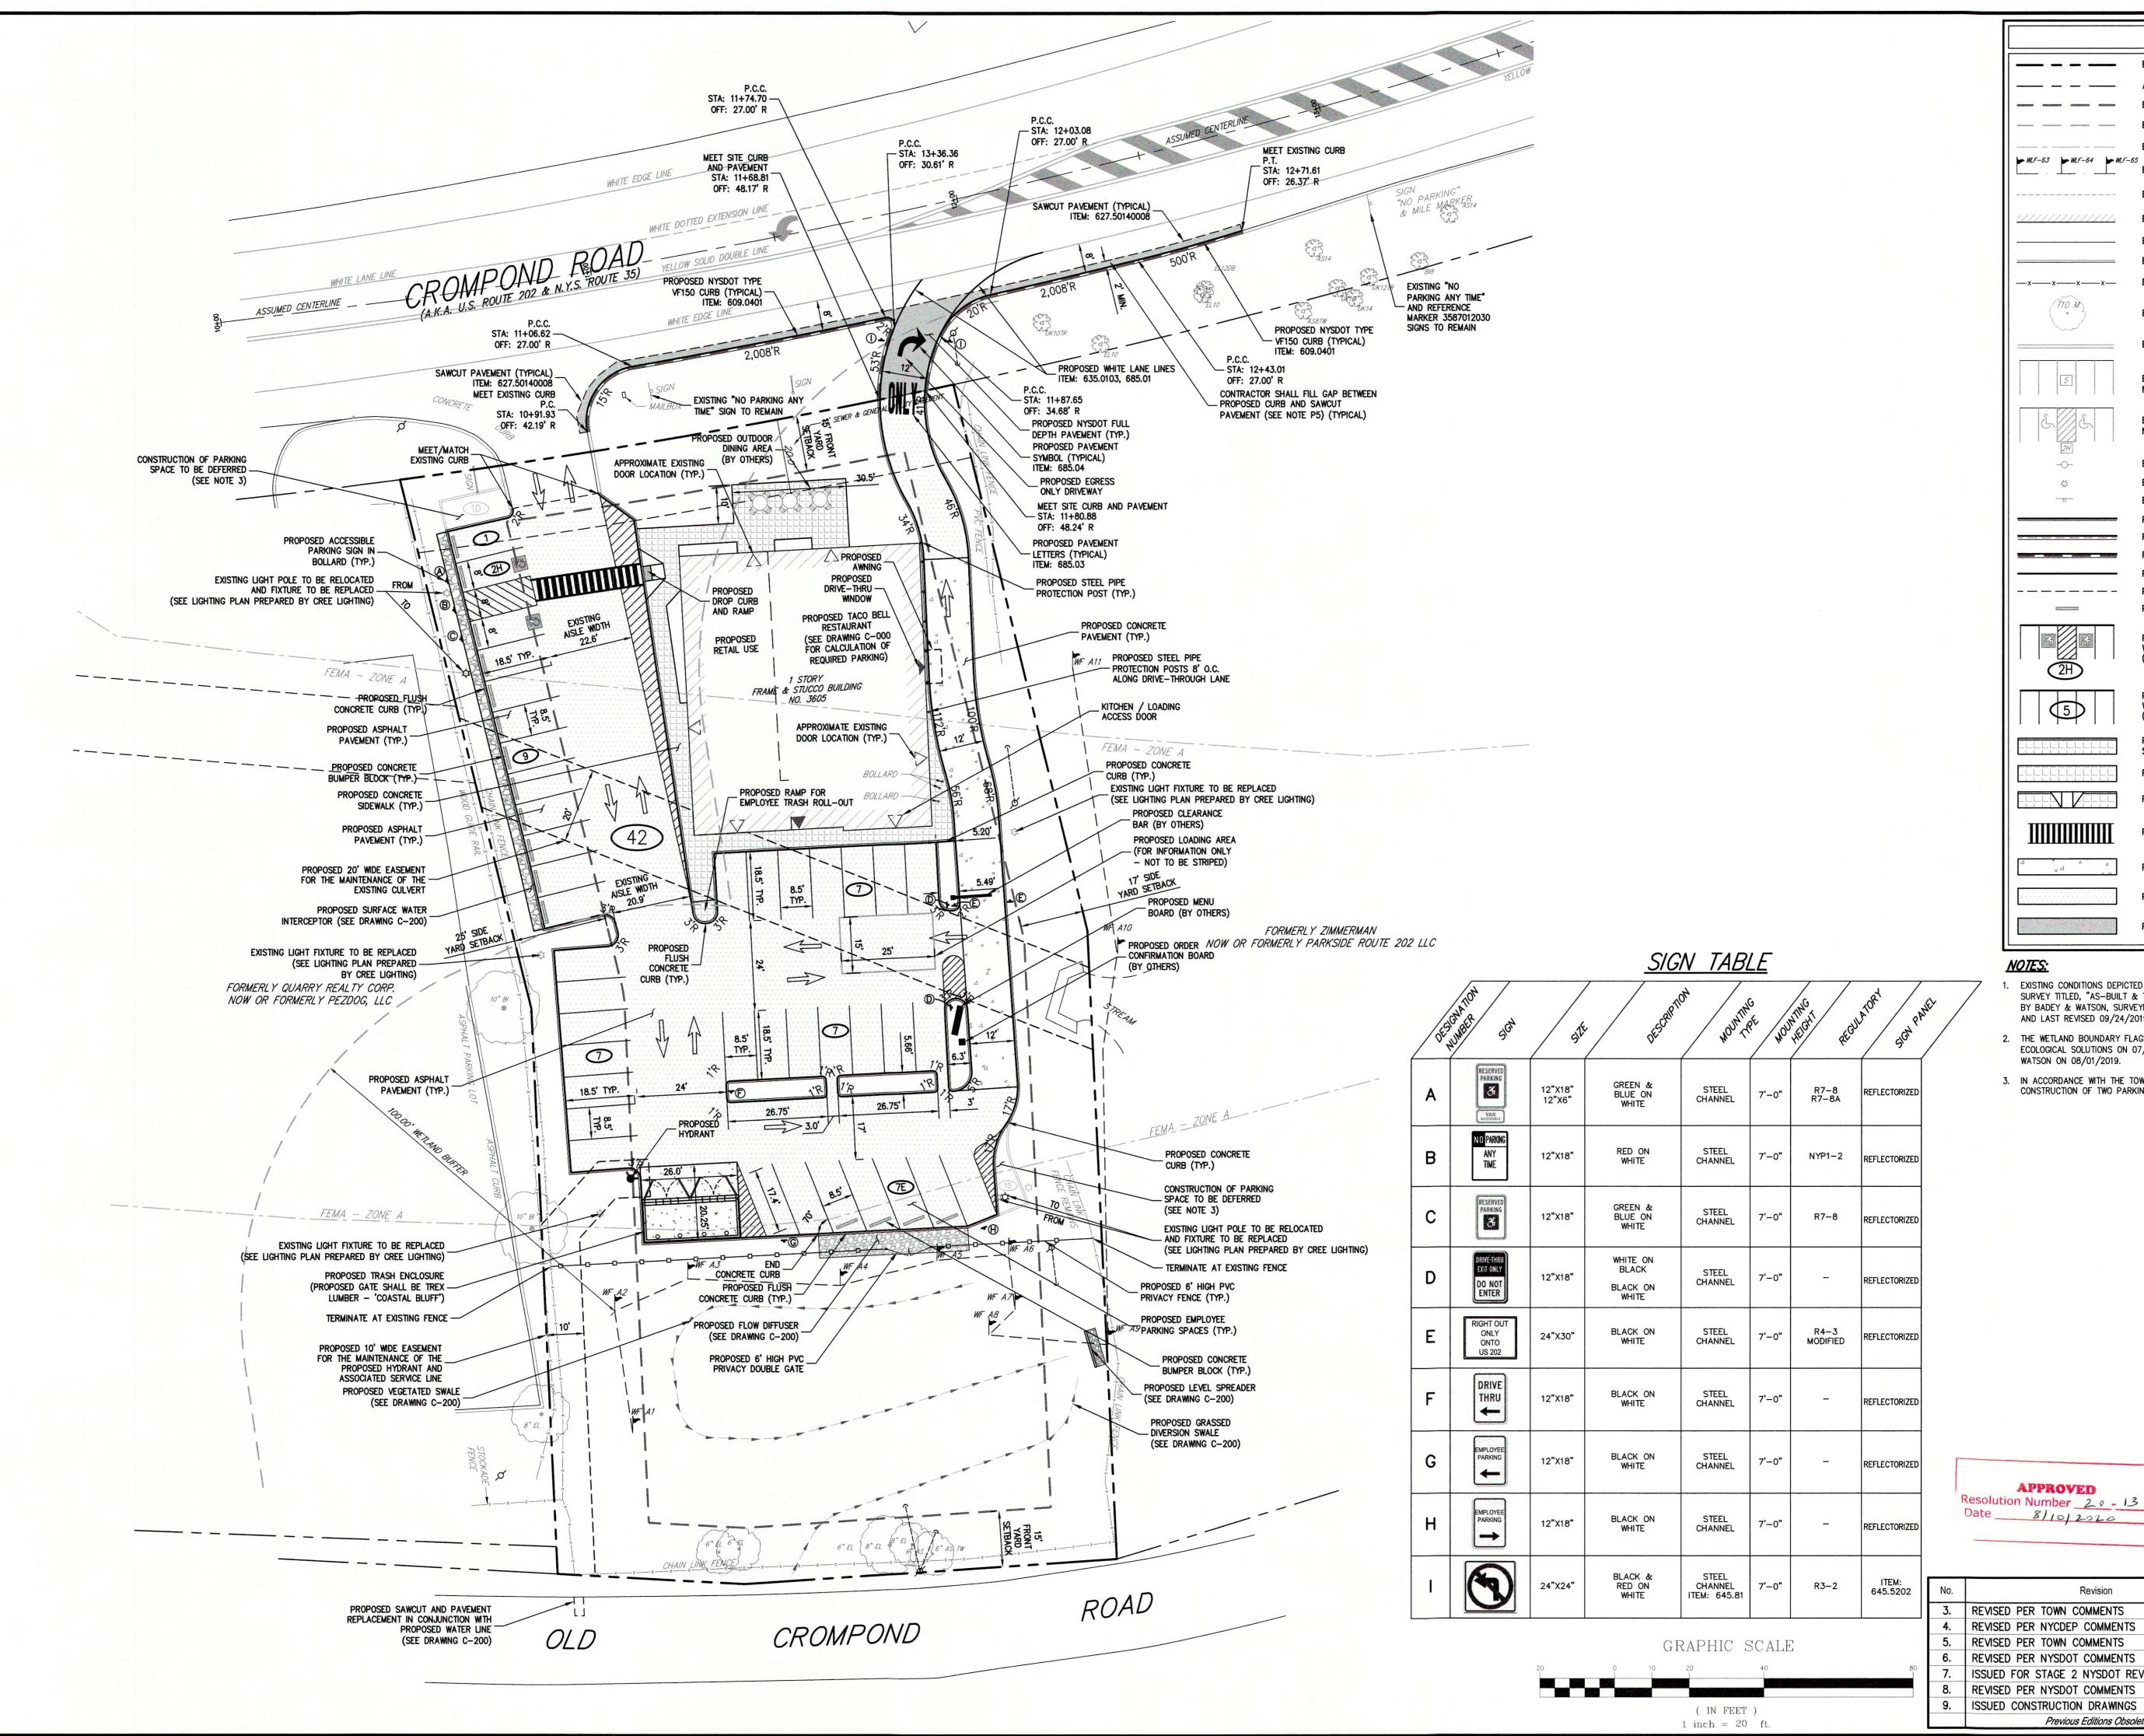

LEGEND EXISTING PROPERTY LINE ADJACENT PROPERTY LINE EXISTING SETBACK LINE EXISTING WETLAND BUFFER LINE EXISTING FLOODPLAIN LINE ₩F-63 ₩F-64 ₩F-65 EXISTING WETLAND LINE AND DELINEATION EXISTING BUILDING OVERHANG EXISTING BUILDING LINE EXISTING PAVEMENT EDGE EXISTING CURB LINE EXISTING FENCE EXISTING TREE AND DESIGNATION EXISTING PAINT EXISTING PARKING WITH NUMBER OF SPACES EXISTING ACCESSIBLE PARKING WITH NUMBER OF SPACES EXISTING UTILITY POLE EXISTING LIGHT POLE EXISTING SIGN PROPOSED SITE CONCRETE CURB PROPOSED FLUSH CONCRETE CURB PROPOSED NYSDOT CONCRETE CURB PROPOSED PAVEMENT EDGE PROPOSED SAWCUT LINE PROPOSED CONCRETE BUMPER BLOCK PROPOSED ACCESSIBLE PARKING SPACES WITH NUMBER OF SPACES INDICATED (REFER TO STRIPING DETAILS) PROPOSED PARKING SPACES WITH NUMBER OF SPACES INDICATED (REFER TO STRIPING DETAILS) PROPOSED MONOLITHIC CONCRETE SIDEWALK & CURB PROPOSED CONCRETE SIDEWALK PROPOSED DROP CURB AND RAMP PEDESTRIAN CROSSING PROPOSED CONCRETE PAVEMENT PROPOSED ASPHALT PAVEMENT PROPOSED NYSDOT FULL DEPTH PAVEMENT

- EXISTING CONDITIONS DEPICTED ON THIS PLAN HAVE BEEN TAKEN FROM SURVEY TITLED, "AS-BUILT & TOPOGRAPHIC SURVEY OF PROPERTY," PREPARED BY BADEY & WATSON, SURVEYING & ENGINEERING, P.C., DATED 08/01/2019, AND LAST REVISED 09/24/2019.
- THE WETLAND BOUNDARY FLAGS SHOWN ON THIS PLAN WERE SET BY ECOLOGICAL SOLUTIONS ON 07/30/2019, AND FIELD LOCATED BY BADEY & WATSON ON 08/01/2019.
- IN ACCORDANCE WITH THE TOWN OF YORKTOWN CODE SECTION 195-42, THE CONSTRUCTION OF TWO PARKING SPACES ARE PROPOSED TO BE DEFERRED.

AYOUT PI

TACO BELL REDEVEL(
3605 CROMPOND RO,
TOWN OF YORKTOWN,

OP OAC



	SECTIO	ON 7209, SUBSECT	ΓΙΟΝ 2.
Revision		Date	Ву
REVISED PER TOWN COMMENTS		05/26/2020	PD
REVISED PER NYCDEP COMMENTS		06/12/2020	PD
REVISED PER TOWN COMMENTS		07/28/2020	PD
REVISED PER NYSDOT COMMENTS		09/09/2020	MTP
ISSUED FOR STAGE 2 NYSDOT REVIEW		11/11/2020	KRM
REVISED PER NYSDOT COMMENTS		01/13/2021	PD
ISSUED CONSTRUCTION DRAWINGS		02/19/2021	PD
Previous Editions Obsolete			

ANY ALTERATION OF PLANS,

SPECIFICATIONS, PLATS AND

REPORTS BEARING THE SEAL

OF A LICENSED PROFESSIONAL

ENGINEER OR LICENSED LAND

SURVEYOR IS A VIOLATION OF

SECTION 7209 OF THE NEW

YORK STATE EDUCATION LAW,

EXCEPT AS PROVIDED FOR BY

Drawn: JAS Approved: JAR

Scale: 1" = 20'


Date: 12/10/2019


Project No: 19101


19101-STE-00 LAY LAY.scr

Drawing No:

C-100

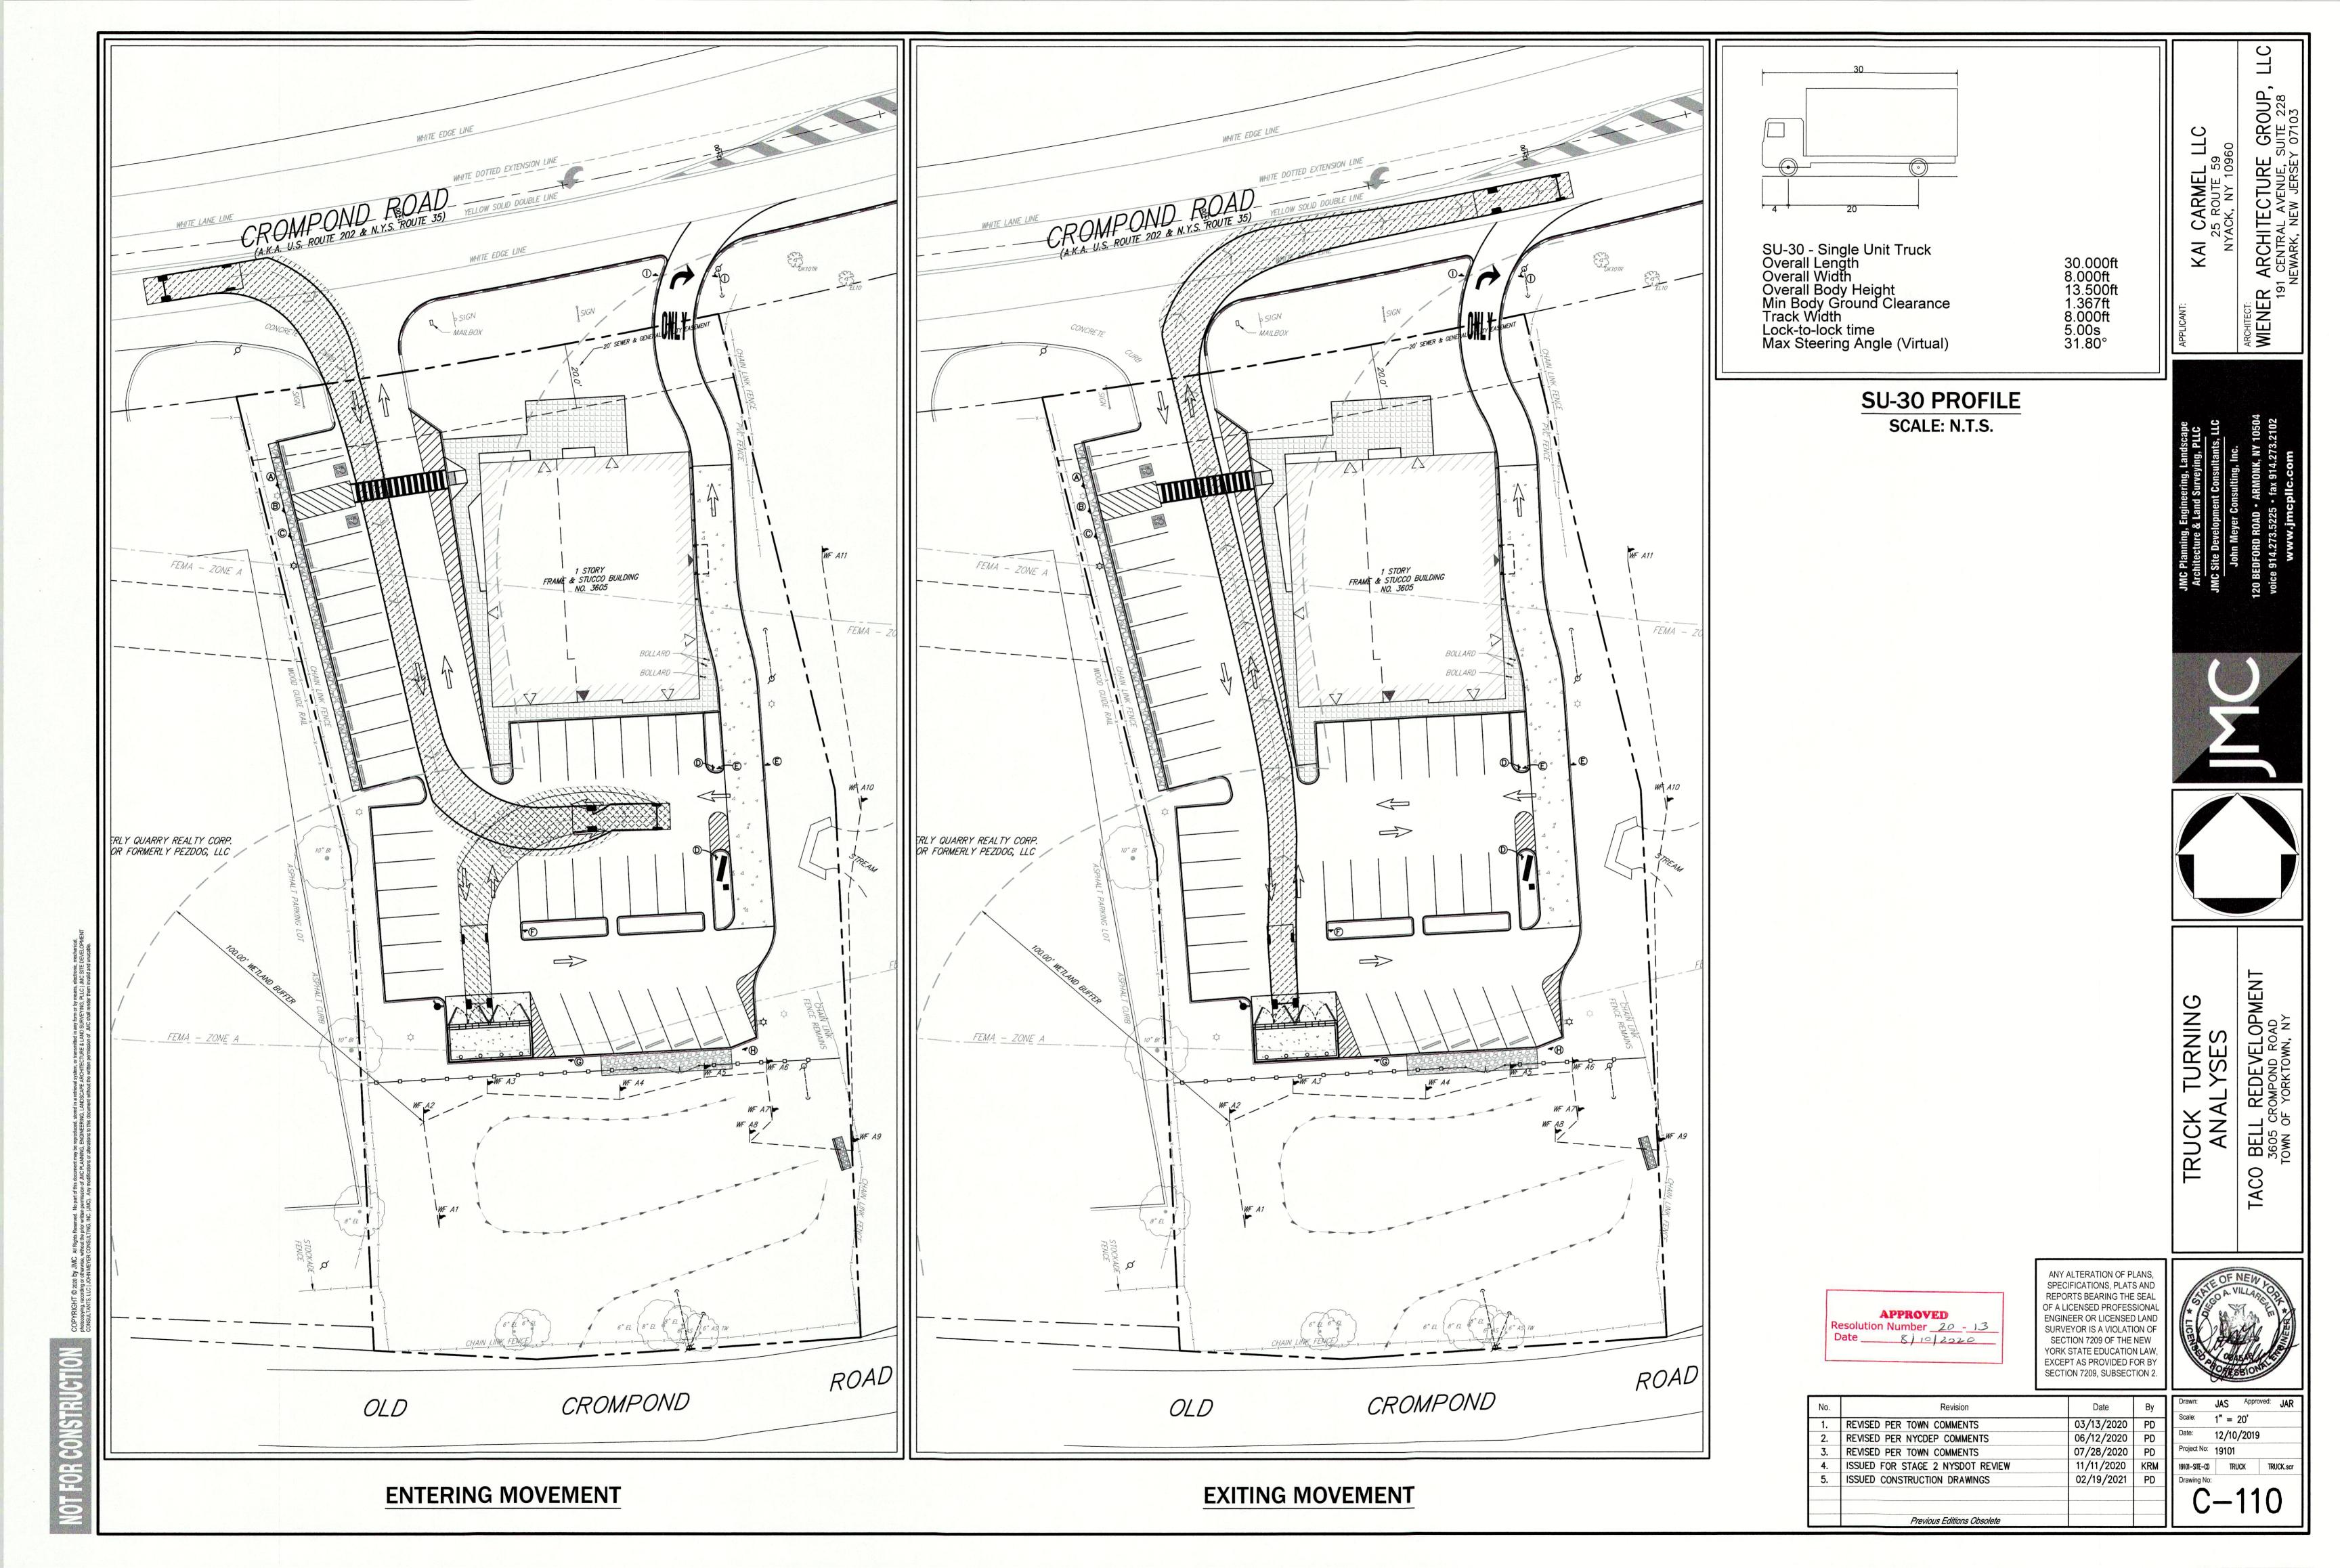

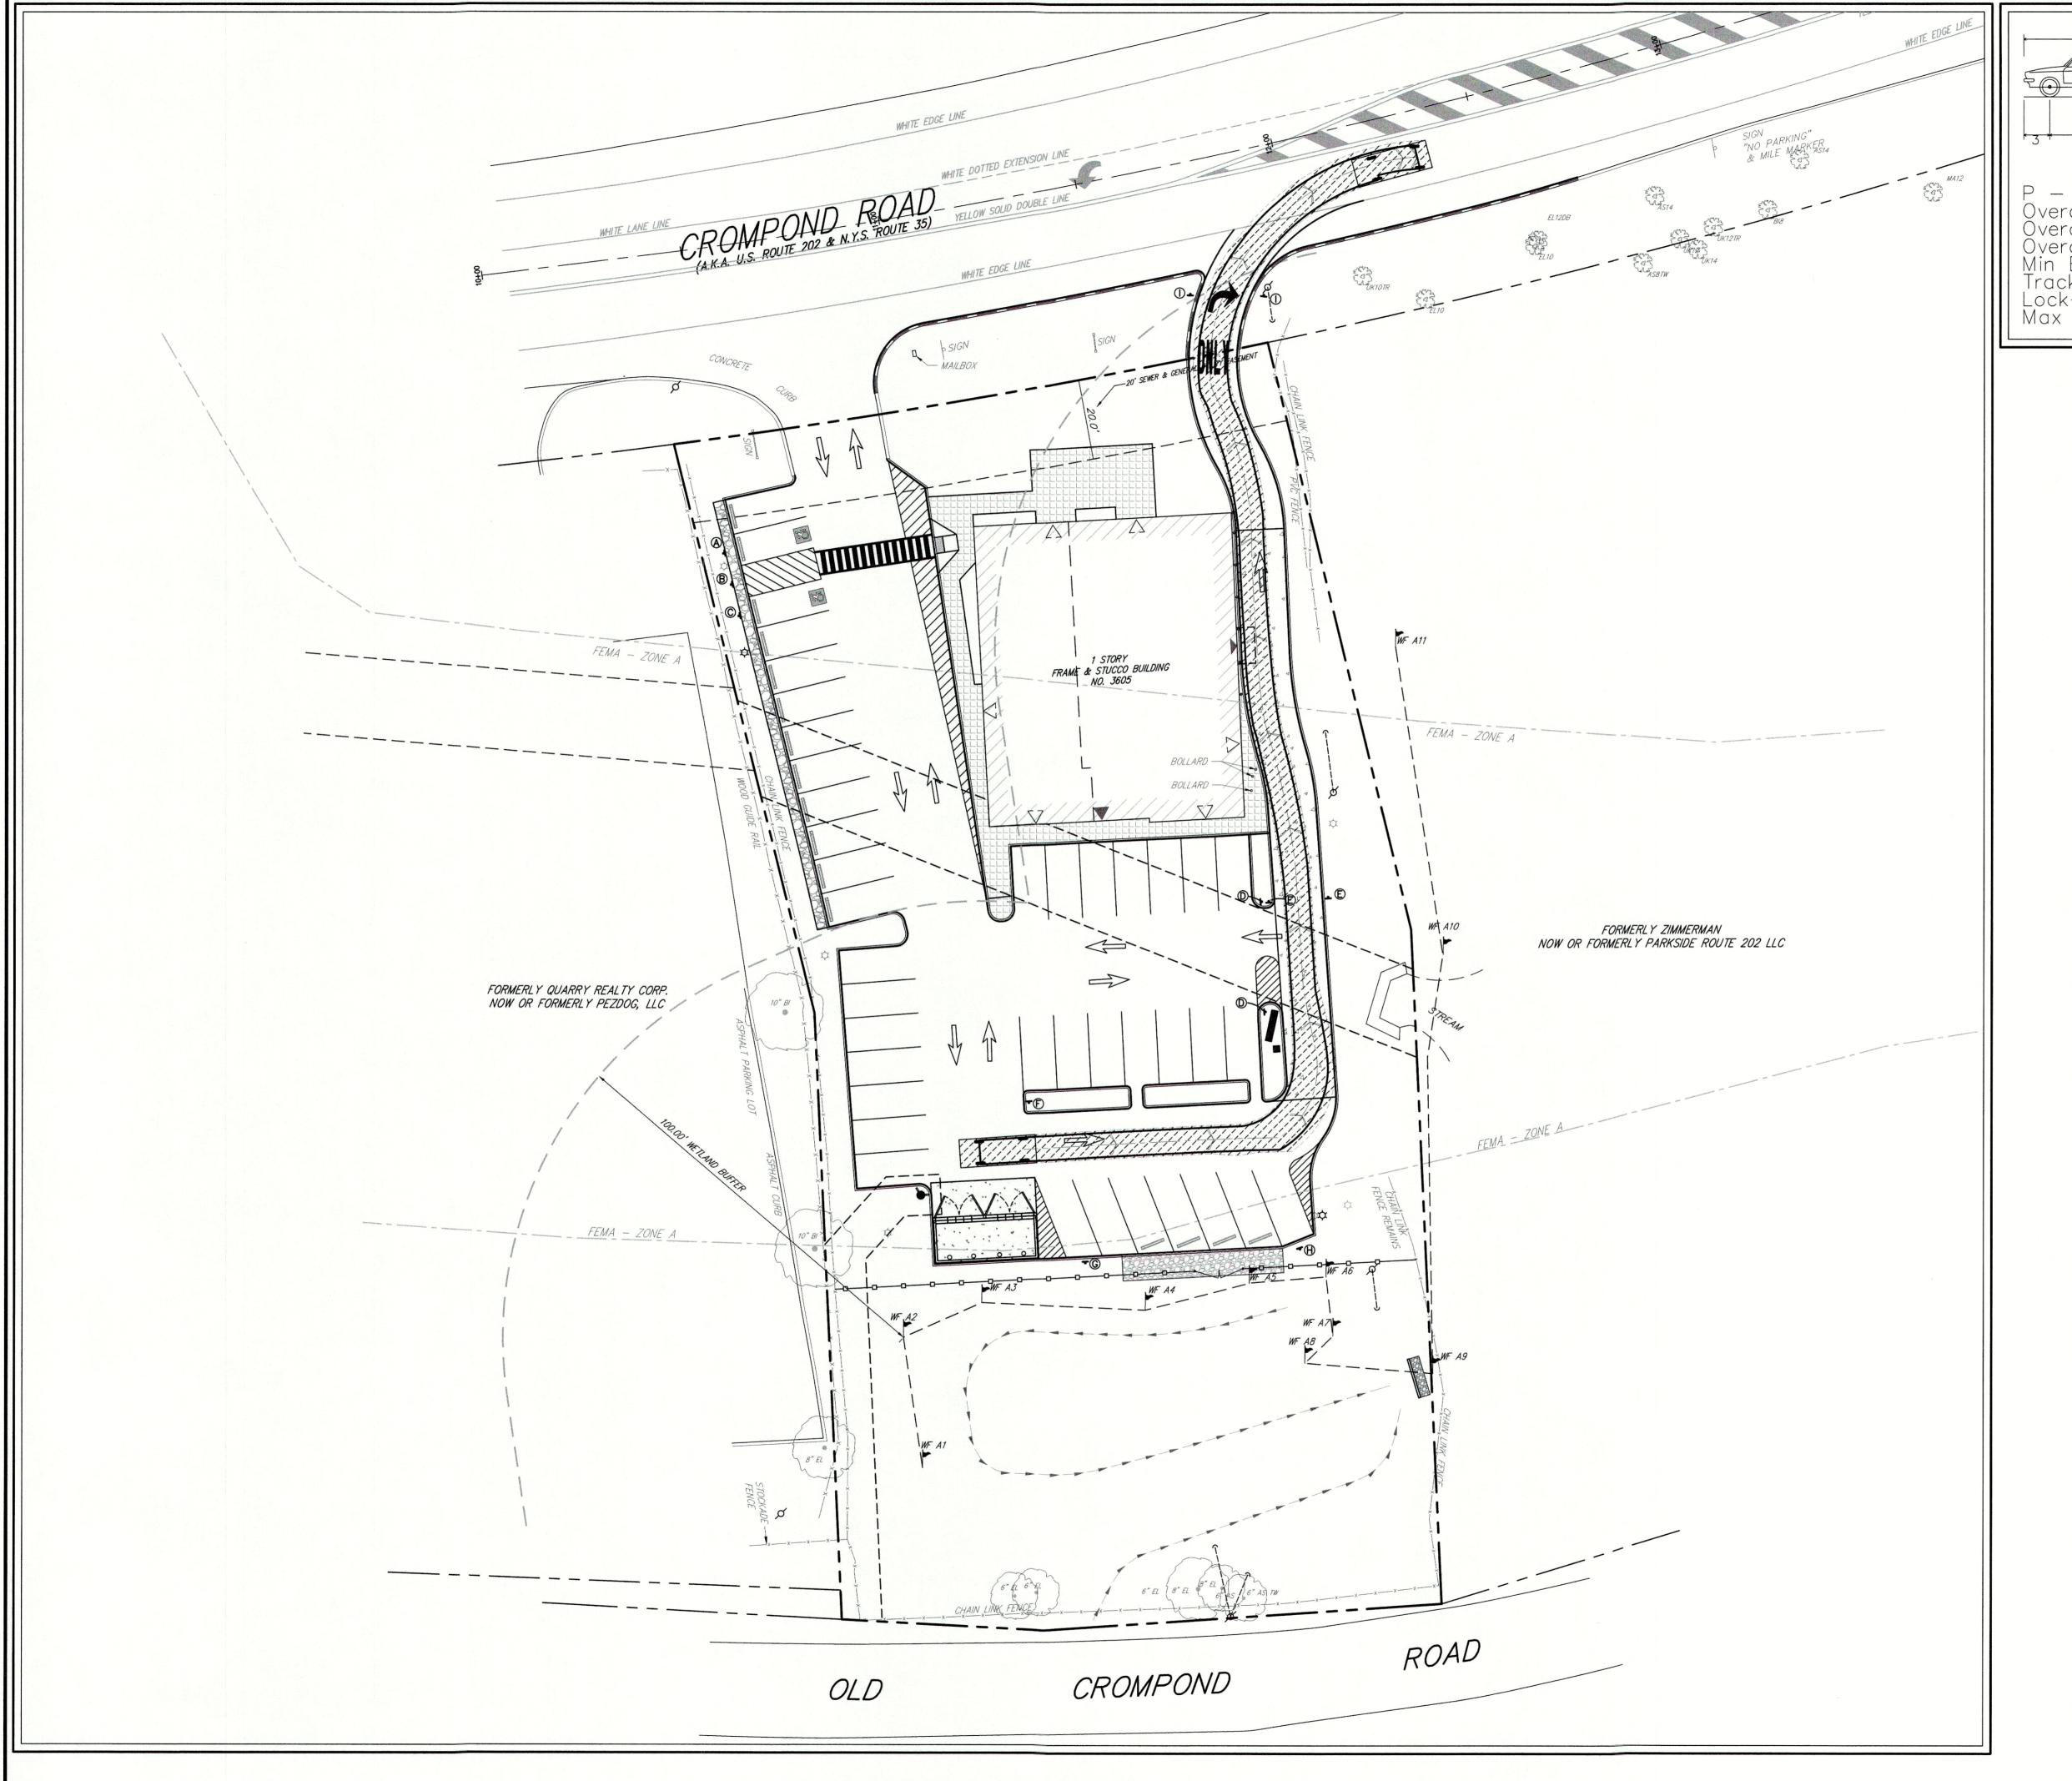

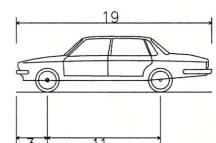

P — Passenger Car Overall Length Overall Width Overall Body Height Min Body Ground Clearance Track Width Lock—to—lock time Max Steering Angle (Virtual)

PASSENGER VEHICLE PROFILE SCALE: N.T.S.


GROUP, UITE 228

ARCHITECT:
WIENER /
191



PASSENGER VENTURNING ANAL


ANY ALTERATION OF PLANS, SPECIFICATIONS, PLATS AND REPORTS BEARING THE SEAL OF A LICENSED PROFESSIONAL ENGINEER OR LICENSED LAND SURVEYOR IS A VIOLATION OF SECTION 7209 OF THE NEW YORK STATE EDUCATION LAW, EXCEPT AS PROVIDED FOR BY SECTION 7209, SUBSECTION 2. Resolution Number 20 - 13
Date 8/10/2020

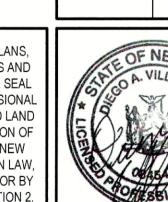


		GEOTION 7203, GOBOLO	HON Z.	7		
No.	Revision	Date	Ву	Drawn:	JAS Appro	oved:
1.	REVISED PER NYCDEP COMMENTS	06/12/2020	PD		1" = 20'	air
2.	REVISED PER TOWN COMMENTS	07/28/2020	PD	Date:	03/13/20	20
3.	ISSUED FOR STAGE 2 NYSDOT REVIEW	11/11/2020	KRM	Project No:	19101	
4.	ISSUED CONSTRUCTION DRAWINGS	02/19/2021	PD	19101-SITE-CD	PASSENGER	TRUC
				Drawing No:		
					10	
				C	_ _	ĽU
	Previous Editions Obsolete					

PASSENGER VEHICLE TURNING MOVEMENT

NOT FOR CONSTRUCTION

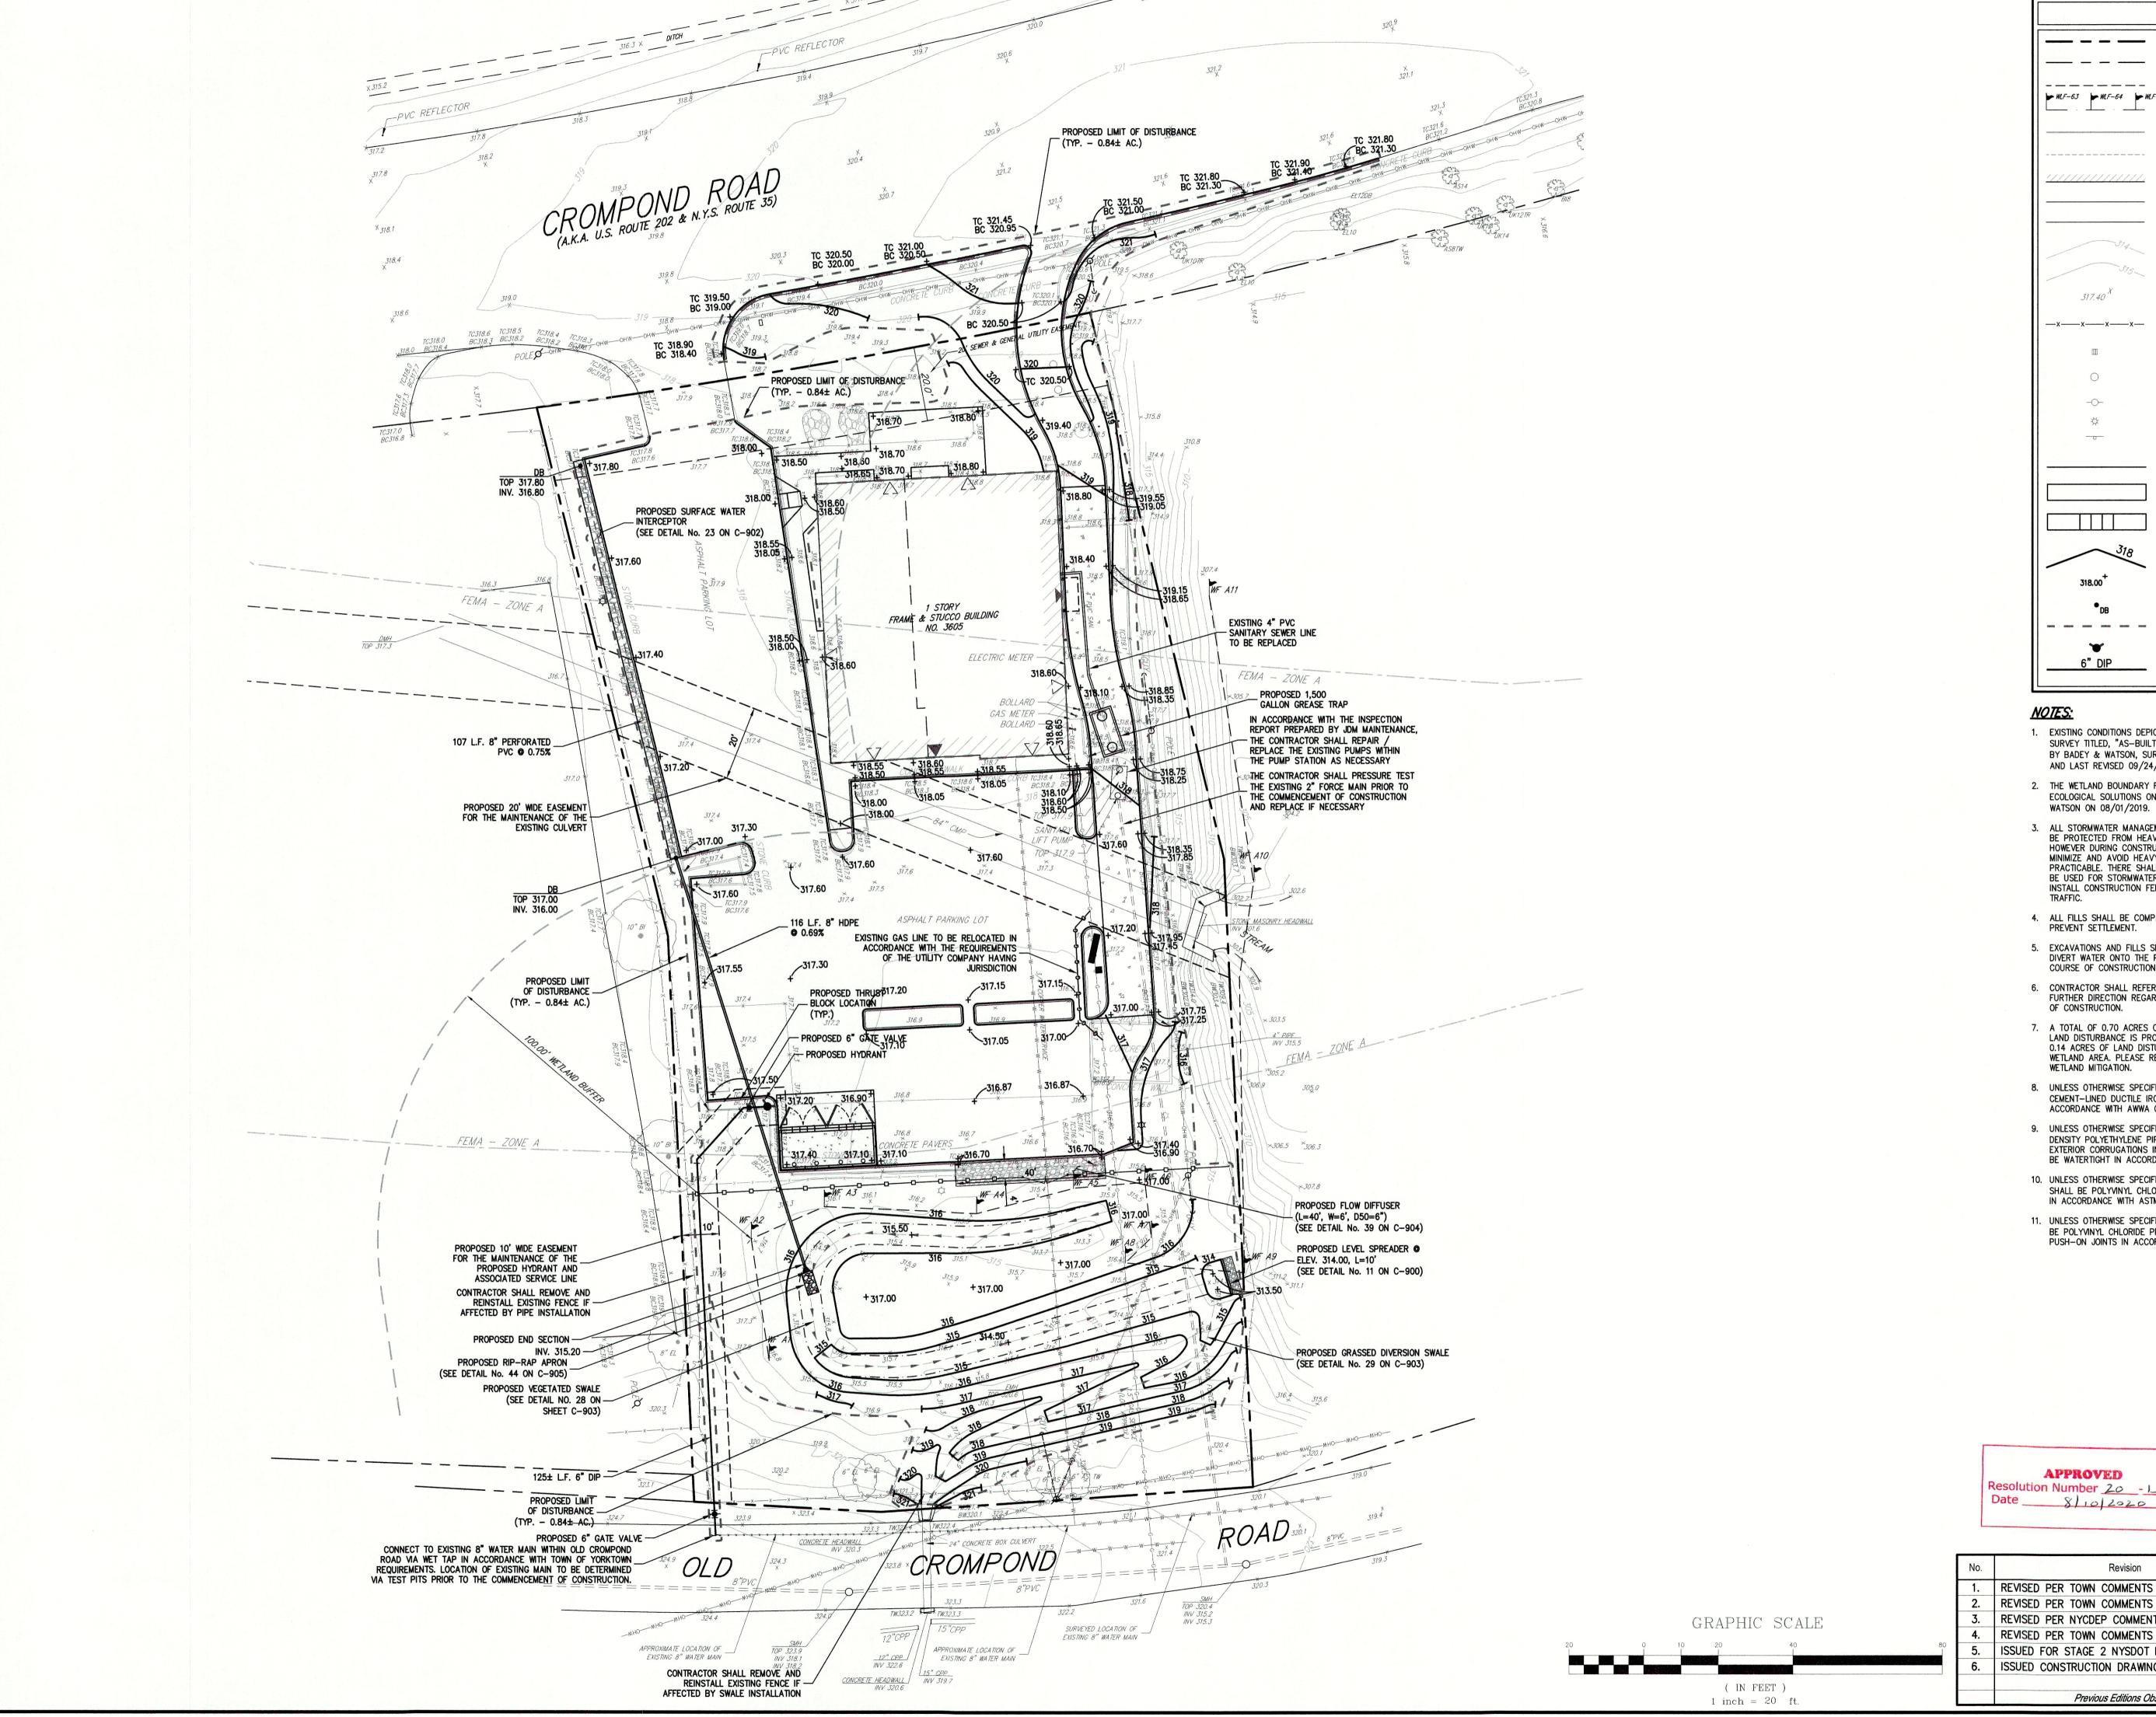

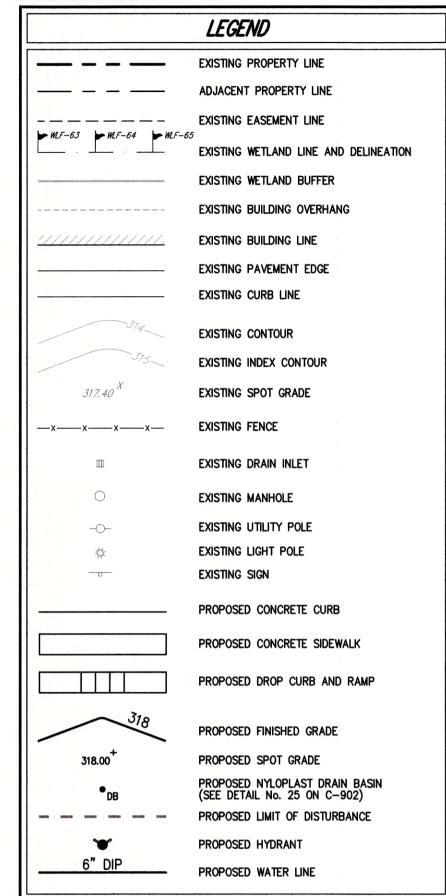

- 1. EXISTING CONDITIONS DEPICTED ON THIS PLAN HAVE BEEN TAKEN FROM SURVEY TITLED, "AS-BUILT & TOPOGRAPHIC SURVEY OF PROPERTY," PREPARED BY BADEY & WATSON, SURVEYING & ENGINEERING, P.C., DATED 08/01/2019, AND LAST REVISED 09/24/2019.
- 2. THE WETLAND BOUNDARY FLAGS SHOWN ON THIS PLAN WERE SET BY ECOLOGICAL SOLUTIONS ON 07/30/2019, AND FIELD LOCATED BY BADEY & WATSON ON 08/01/2019.
- 3. ALL STORMWATER MANAGEMENT PRACTICES SHALL REMAIN UNDISTURBED AND BE PROTECTED FROM HEAVY MACHINERY TRAFFIC DURING CONSTRUCTION. HOWEVER DURING CONSTRUCTION OF THE PRACTICE THE CONTRACTOR SHALL MINIMIZE AND AVOID HEAVY MACHINERY TRAFFIC TO THE MAXIMUM EXTENT PRACTICABLE. THERE SHALL BE NO STORAGE OF MATERIALS WITHIN AREAS TO BE USED FOR STORMWATER MANAGEMENT PRACTICES. THE CONTRACTOR SHALL INSTALL CONSTRUCTION FENCE AROUND THE PRACTICE TO DISCOURAGE VEHICLE TRAFFIC.
- 4. ALL FILLS SHALL BE COMPACTED TO PROVIDE STABILITY OF MATERIAL AND TO PREVENT SETTLEMENT.
- EXCAVATIONS AND FILLS SHALL NOT ENDANGER ADJOINING PROPERTIES, NOR DIVERT WATER ONTO THE PROPERTY OF OTHERS AT ANY TIME DURING THE COURSE OF CONSTRUCTION.
- 6. CONTRACTOR SHALL REFER TO EROSION AND SEDIMENT CONTROL PLAN FOR FURTHER DIRECTION REGARDING SITE STABILIZATION THROUGHOUT THE COURSE
- 7. A TOTAL OF 0.70 ACRES OF LAND DISTURBANCE IS PROPOSED. 0.40 ACRES OF LAND DISTURBANCE IS PROPOSED WITHIN THE ON-SITE WETLAND BUFFER, AND 0.14 ACRES OF LAND DISTURBANCE IS PROPOSED WITHIN THE DELINEATED WETLAND AREA. PLEASE REFER TO JMC DRAWING L-100 FOR PROPOSED
- 8. UNLESS OTHERWISE SPECIFIED, PIPE FOR WATER LINES SHALL BE DOUBLE CEMENT-LINED DUCTILE IRON PIPE (DIP), CLASS 52, WITH PUSH-ON JOINTS IN ACCORDANCE WITH AWWA C-150, C-151, C-104 AND C-111.
- 9. UNLESS OTHERWISE SPECIFIED, PIPE FOR STORM DRAINS SHALL BE HIGH DENSITY POLYETHYLENE PIPE (HDPE) WITH A SMOOTH INTERIOR AND ANNULAR EXTERIOR CORRUGATIONS IN ACCORDANCE WITH ASTM F-2648. JOINTS SHALL BE WATERTIGHT IN ACCORDANCE WITH ASTM D-3212.
- 10. UNLESS OTHERWISE SPECIFIED, PIPE FOR SANITARY SEWER GRAVITY LINES SHALL BE POLYVINYL CHLORIDE PIPE (PVCP), SDR-35, WITH PUSH-ON JOINTS IN ACCORDANCE WITH ASTM D-3034 AND D-3212.
- 11. UNLESS OTHERWISE SPECIFIED, PIPE FOR SANITARY SEWER FORCE MAINS SHALL BE POLYVINYL CHLORIDE PRESSURE PIPE (PVCPP), SDR-26, 160 PSI, WITH PUSH-ON JOINTS IN ACCORDANCE WITH ASTM D-2241.


NIO

APPROVED Resolution Number 20 - 13

ANY ALTERATION OF PLANS, SPECIFICATIONS, PLATS AND REPORTS BEARING THE SEAL OF A LICENSED PROFESSIONAL ENGINEER OR LICENSED LAND SURVEYOR IS A VIOLATION OF SECTION 7209 OF THE NEW YORK STATE EDUCATION LAW, EXCEPT AS PROVIDED FOR BY SECTION 7209, SUBSECTION 2.



					The same of the sa	
No.	Revision	Date	Ву		JAS Approved:	JAR
1.	REVISED PER TOWN COMMENTS	03/13/2020	PD		1" = 20'	
2.	REVISED PER TOWN COMMENTS	05/26/2020	PD		12/10/2019	
3.	REVISED PER NYCDEP COMMENTS	06/12/2020	PD	Project No:	19101	
4.	REVISED PER TOWN COMMENTS	07/28/2020	PD	19101-SITE-CD	GRAD-UTIL GRAD)-UTIL.scr
5.	ISSUED FOR STAGE 2 NYSDOT REVIEW	11/11/2020	KRM	Drawing No:		
6.	ISSUED CONSTRUCTION DRAWINGS	02/19/2021	PD		200	7
					-200	J
	Previous Editions Obsolete					

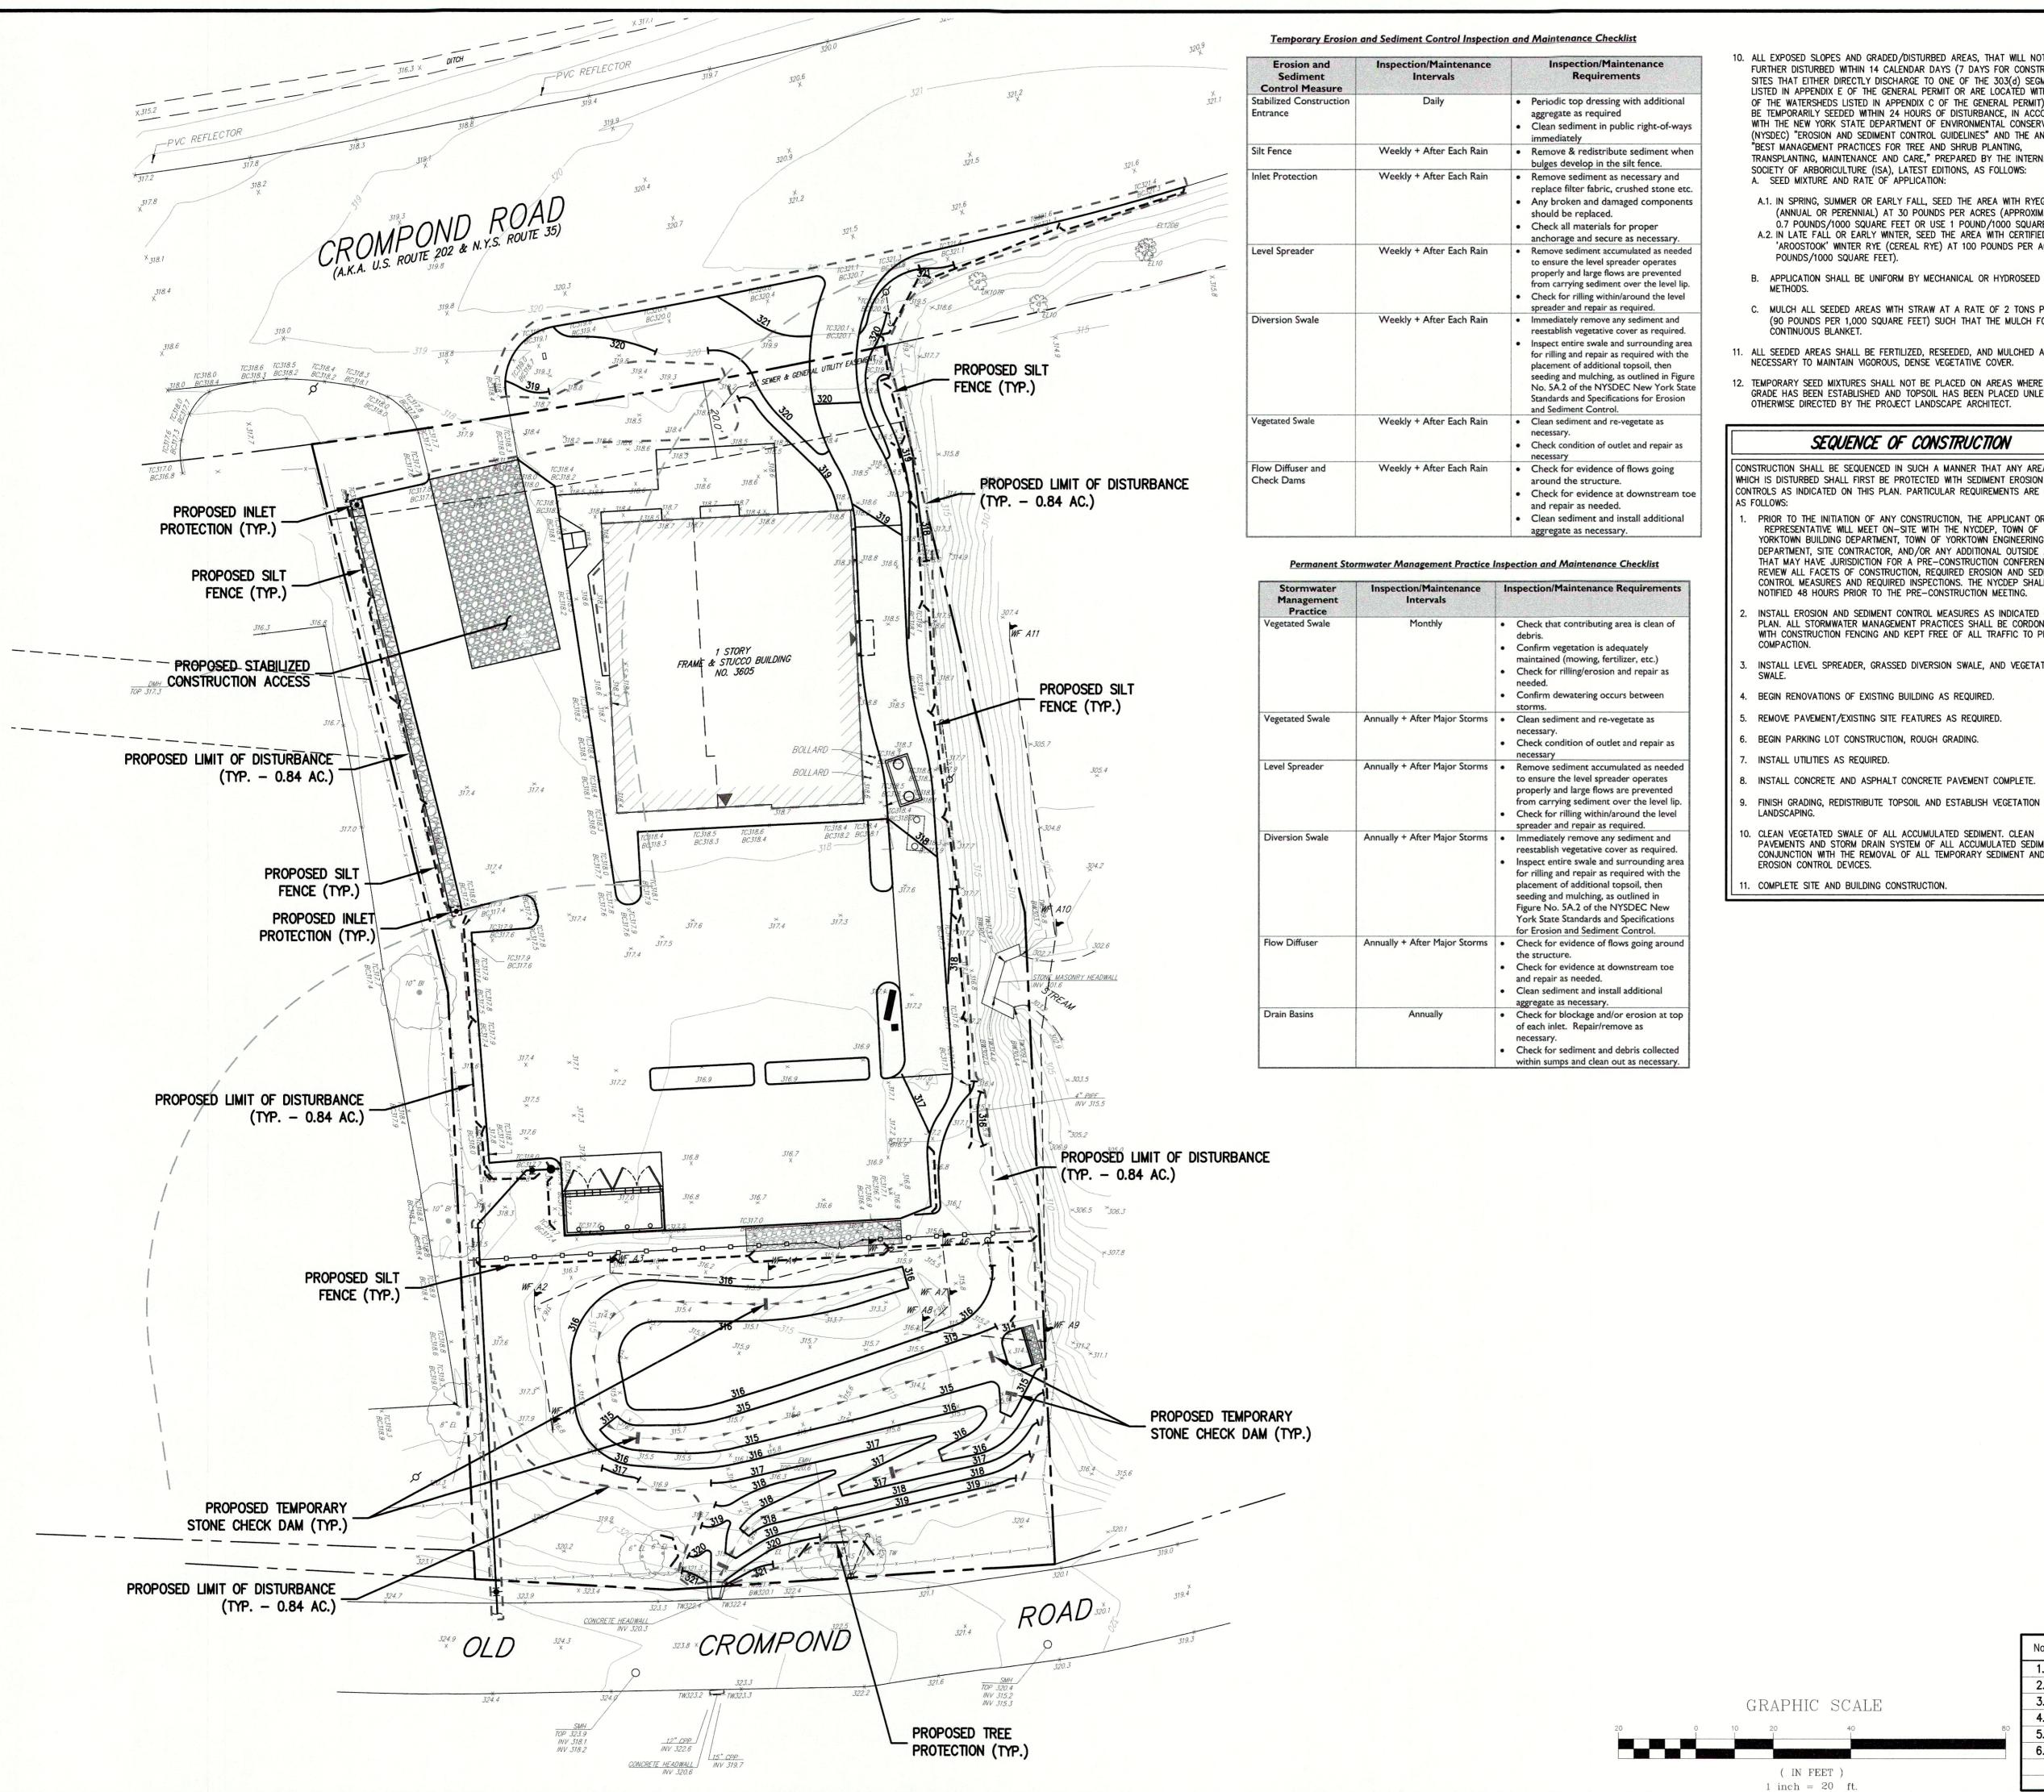

10. ALL EXPOSED SLOPES AND GRADED/DISTURBED AREAS, THAT WILL NOT BE FURTHER DISTURBED WITHIN 14 CALENDAR DAYS (7 DAYS FOR CONSTRUCTION SITES THAT EITHER DIRECTLY DISCHARGE TO ONE OF THE 303(d) SEGMENTS LISTED IN APPENDIX E OF THE GENERAL PERMIT OR ARE LOCATED WITHIN ONE OF THE WATERSHEDS LISTED IN APPENDIX C OF THE GENERAL PERMIT), SHALL BE TEMPORARILY SEEDED WITHIN 24 HOURS OF DISTURBANCE, IN ACCORDANCE WITH THE NEW YORK STATE DEPARTMENT OF ENVIRONMENTAL CONSERVATION (NYSDEC) "EROSION AND SEDIMENT CONTROL GUIDELINES" AND THE ANSI A300 BEST MANAGEMENT PRACTICES FOR TREE AND SHRUB PLANTING, TRANSPLANTING, MAINTENANCE AND CARE," PREPARED BY THE INTERNATIONAL SOCIETY OF ARBORICULTURE (ISA), LATEST EDITIONS, AS FOLLOWS:

A.1. IN SPRING, SUMMER OR EARLY FALL, SEED THE AREA WITH RYEGRASS (ANNUAL OR PERENNIAL) AT 30 POUNDS PER ACRES (APPROXIMATELY 0.7 POUNDS/1000 SQUARE FEET OR USE 1 POUND/1000 SQUARE FEET). A.2. IN LATE FALL OR EARLY WINTER, SEED THE AREA WITH CERTIFIED

- POUNDS/1000 SQUARE FEET).
- C. MULCH ALL SEEDED AREAS WITH STRAW AT A RATE OF 2 TONS PER ACRE (90 POUNDS PER 1,000 SQUARE FEET) SUCH THAT THE MULCH FORMS A
- NECESSARY TO MAINTAIN VIGOROUS, DENSE VEGETATIVE COVER.
- 12. TEMPORARY SEED MIXTURES SHALL NOT BE PLACED ON AREAS WHERE FINAL GRADE HAS BEEN ESTABLISHED AND TOPSOIL HAS BEEN PLACED UNLESS OTHERWISE DIRECTED BY THE PROJECT LANDSCAPE ARCHITECT.

CONTROLS AS INDICATED ON THIS PLAN. PARTICULAR REQUIREMENTS ARE GIVEN

- REPRESENTATIVE WILL MEET ON-SITE WITH THE NYCDEP, TOWN OF YORKTOWN BUILDING DEPARTMENT, TOWN OF YORKTOWN ENGINEERING THAT MAY HAVE JURISDICTION FOR A PRE-CONSTRUCTION CONFERENCE TO NOTIFIED 48 HOURS PRIOR TO THE PRE-CONSTRUCTION MEETING.
- 4. BEGIN RENOVATIONS OF EXISTING BUILDING AS REQUIRED.
- BEGIN PARKING LOT CONSTRUCTION, ROUGH GRADING.
- INSTALL UTILITIES AS REQUIRED.
- 3. INSTALL CONCRETE AND ASPHALT CONCRETE PAVEMENT COMPLETE.
- 1. COMPLETE SITE AND BUILDING CONSTRUCTION.

- 'AROOSTOOK' WINTER RYE (CEREAL RYE) AT 100 POUNDS PER ACRE (2.5
- ALL SEEDED AREAS SHALL BE FERTILIZED, RESEEDED, AND MULCHED AS

SEQUENCE OF CONSTRUCTION

CONSTRUCTION SHALL BE SEQUENCED IN SUCH A MANNER THAT ANY AREA WHICH IS DISTURBED SHALL FIRST BE PROTECTED WITH SEDIMENT EROSION

- PRIOR TO THE INITIATION OF ANY CONSTRUCTION, THE APPLICANT OR HIS DEPARTMENT, SITE CONTRACTOR, AND/OR ANY ADDITIONAL OUTSIDE AGENCIES REVIEW ALL FACETS OF CONSTRUCTION, REQUIRED EROSION AND SEDIMENT CONTROL MEASURES AND REQUIRED INSPECTIONS. THE NYCDEP SHALL BE
- INSTALL EROSION AND SEDIMENT CONTROL MEASURES AS INDICATED ON THIS PLAN. ALL STORMWATER MANAGEMENT PRACTICES SHALL BE CORDONED OFF WITH CONSTRUCTION FENCING AND KEPT FREE OF ALL TRAFFIC TO PREVENT
- INSTALL LEVEL SPREADER, GRASSED DIVERSION SWALE, AND VEGETATED
- . REMOVE PAVEMENT/EXISTING SITE FEATURES AS REQUIRED.

- 9. FINISH GRADING, REDISTRIBUTE TOPSOIL AND ESTABLISH VEGETATION AND/OR
- O. CLEAN VEGETATED SWALE OF ALL ACCUMULATED SEDIMENT. CLEAN PAVEMENTS AND STORM DRAIN SYSTEM OF ALL ACCUMULATED SEDIMENT IN CONJUNCTION WITH THE REMOVAL OF ALL TEMPORARY SEDIMENT AND EROSION CONTROL DEVICES.

- LEGEND EXISTING PROPERTY LINE ADJACENT PROPERTY LINE EXISTING EASEMENT LINE ₩LF-63 ₩LF-64 ₩LF-65 EXISTING WETLAND LINE AND DELINEATION EXISTING WETLAND BUFFER EXISTING BUILDING LINE EXISTING PAVEMENT EDGE
 - EXISTING CURB LINE $O_{\tilde{\Omega}}$ EXISTING CONTOUR $\overline{\forall}$

 \circ

OUP

ARCHITECT.

EXISTING INDEX CONTOUR EXISTING SPOT GRADE EXISTING FENCE EXISTING DRAIN INLET EXISTING MANHOLE EXISTING UTILITY POLE

EXISTING SIGN PROPOSED CONCRETE CURB PROPOSED CONCRETE SIDEWALK

PROPOSED DROP CURB AND RAMP

PROPOSED FINISHED GRADE

EXISTING LIGHT POLE

PROPOSED SPOT GRADE PROPOSED SILT FENCE

—x——x——x——x—

PROPOSED LIMIT OF DISTURBANCE PROPOSED STABILIZED CONSTRUCTION ACCESS

PROPOSED TEMPORARY STONE CHECK DAM

PROPOSED TREE PROTECTION

NOTES:

EXISTING CONDITIONS DEPICTED ON THIS PLAN HAVE BEEN TAKEN FROM SURVEY TITLED, "AS-BUILT & TOPOGRAPHIC SURVEY OF PROPERTY," PREPARED BY BADEY & WATSON, SURVEYING & ENGINEERING, P.C., DATED 08/01/2019, AND LAST REVISED 09/24/2019.


- THIS PLAN IS FOR TEMPORARY EROSION AND SEDIMENT CONTROL INFORMATION
- PRIOR TO BEGINNING ANY CLEARING, GRUBBING OR EXCAVATION, ALL EROSION AND SEDIMENT CONTROL MEASURES SHALL BE INSTALLED IN ACCORDANCE WITH ALL THE PLANS AND SPECIFICATIONS. EROSION AND SEDIMENT CONTROL MEASURES SHALL BE MAINTAINED UNTIL THE SITE IS STABILIZED. FINAL STABILIZATION OF LANDSCAPED AREAS SHALL BE IN ACCORDANCE WITH THE LANDSCAPE PLAN.
- 4. THE CONTRACTOR SHALL INSPECT AND MAINTAIN ON-SITE EROSION AND SEDIMENT CONTROL MEASURES ON A DAILY BASIS. ALL COLLECTED SEDIMENT WITHIN SEDIMENT BARRIERS SHALL BE REMOVED PERIODICALLY AS REQUIRED TO MAINTAIN THE FUNCTION OF THE SEDIMENT BARRIERS. ALL SEDIMENT COLLECTED SHALL BE RESPREAD ON-SITE WITHIN STABILIZED AREAS AS DIRECTED BY THE OWNERS REPRESENTATIVE.
- 5. THE CONTRACTOR SHALL INSPECT DOWNSTREAM CONDITIONS FOR EVIDENCE OF SEDIMENTATION ON A WEEKLY BASIS, AFTER EACH RAINSTORM, AND AS MAY BE REQUIRED OR DIRECTED BY ALL APPLICABLE APPROVALS AND PERMITS. TH CONTRACTOR SHALL IMMEDIATELY PROVIDE A WRITTEN REPORT ON FINDINGS OF SEDIMENT IN DOWNSTREAM AREAS TO ALL AUTHORITIES HAVING JURISDICTION AND MAKE REPAIRS AS REQUIRED OR DIRECTED.
- 6. ADDITIONAL EROSION AND SEDIMENT CONTROL MEASURES SHALL BE INSTALLED BY THE CONTRACTOR AS REQUIRED/WARRANTED BY FIELD CONDITIONS AND AS DIRECTED BY THE OWNERS REPRESENTATIVE, JMC, AND/OR ANY AUTHORITY HAVING JURISDICTION.
- 7. STOCKPILING OF CONSTRUCTION MATERIAL SHALL BE PLACED IN AN AREA APPROVED BY THE OWNERS REPRESENTATIVE. STOCKPILED EXCAVATED MATERIAL SHALL HAVE TWO ROWS OF SILT FENCE LOCATED AROUND ITS PERIMETER. ALL STOCKPILED MATERIAL SHALL BE MAINTAINED IN AN ORDERLY MANNER SO AS NOT TO IMPEDE ON PEDESTRIAN AND/OR VEHICULAR TRAFFIC
- 8. DUST SHALL BE CONTROLLED BY SPRINKLING OR OTHER APPROVED METHODS AS NECESSARY, OR AS DIRECTED BY THE OWNERS REPRESENTATIVE.
- ALL STORMWATER MANAGEMENT PRACTICES SHALL REMAIN UNDISTURBED AND BE PROTECTED FROM HEAVY MACHINERY TRAFFIC DURING CONSTRUCTION. HOWEVER DURING CONSTRUCTION OF THE PRACTICE THE CONTRACTOR SHALL MINIMIZE AND AVOID HEAVY MACHINERY TRAFFIC TO THE MAXIMUM EXTENT PRACTICABLE. THERE SHALL BE NO STORAGE OF MATERIALS WITHIN AREAS TO BE USED FOR STORMWATER MANAGEMENT PRACTICES. THE CONTRACTOR SHALL INSTALL CONSTRUCTION FENCE AROUND THE PRACTICE TO DISCOURAGE VEHICLE TRAFFIC.

ZOL H S REI SI AC



SPECIFICATIONS, PLATS AND REPORTS BEARING THE SEAL OF A LICENSED PROFESSIONAL ENGINEER OR LICENSED LAND SURVEYOR IS A VIOLATION OF SECTION 7209 OF THE NEW YORK STATE EDUCATION LAV EXCEPT AS PROVIDED FOR SECTION 7209, SUBSECTIO

ANY ALTERATION OF PLANS

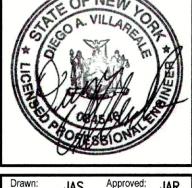

No.	Revision	Date	Ву
1.	REVISED PER TOWN COMMENTS	03/13/2020	PD
2.	REVISED PER NYCDEP COMMENTS	06/12/2020	PD
3.	REVISED PER NYCDEP COMMENTS	06/29/2020	PD
4.	REVISED PER TOWN COMMENTS	07/28/2020	PD
5.	ISSUED FOR STAGE 2 NYSDOT REVIEW	11/11/2020	KRM
6.	ISSUED CONSTRUCTION DRAWINGS	02/19/2021	PD
-	Previous Editions Obsolete		


APPROVED


Resolution Number 20 - 13


Date 8/10/2020


LAW, R BY ON 2.		Of Art As				
Ву	Drawn:	JAS Appro	oved: JAR			
PD	Scale:	1" = 20'				
PD	Date:	12/10/2019				
PD	Project No:	19101				
PD	19101-SITE-CD	SE	SE.scr			
KRM	Drawing No:					
PD	C-	-40)0 II			
			-			


GRAPHIC SCALE

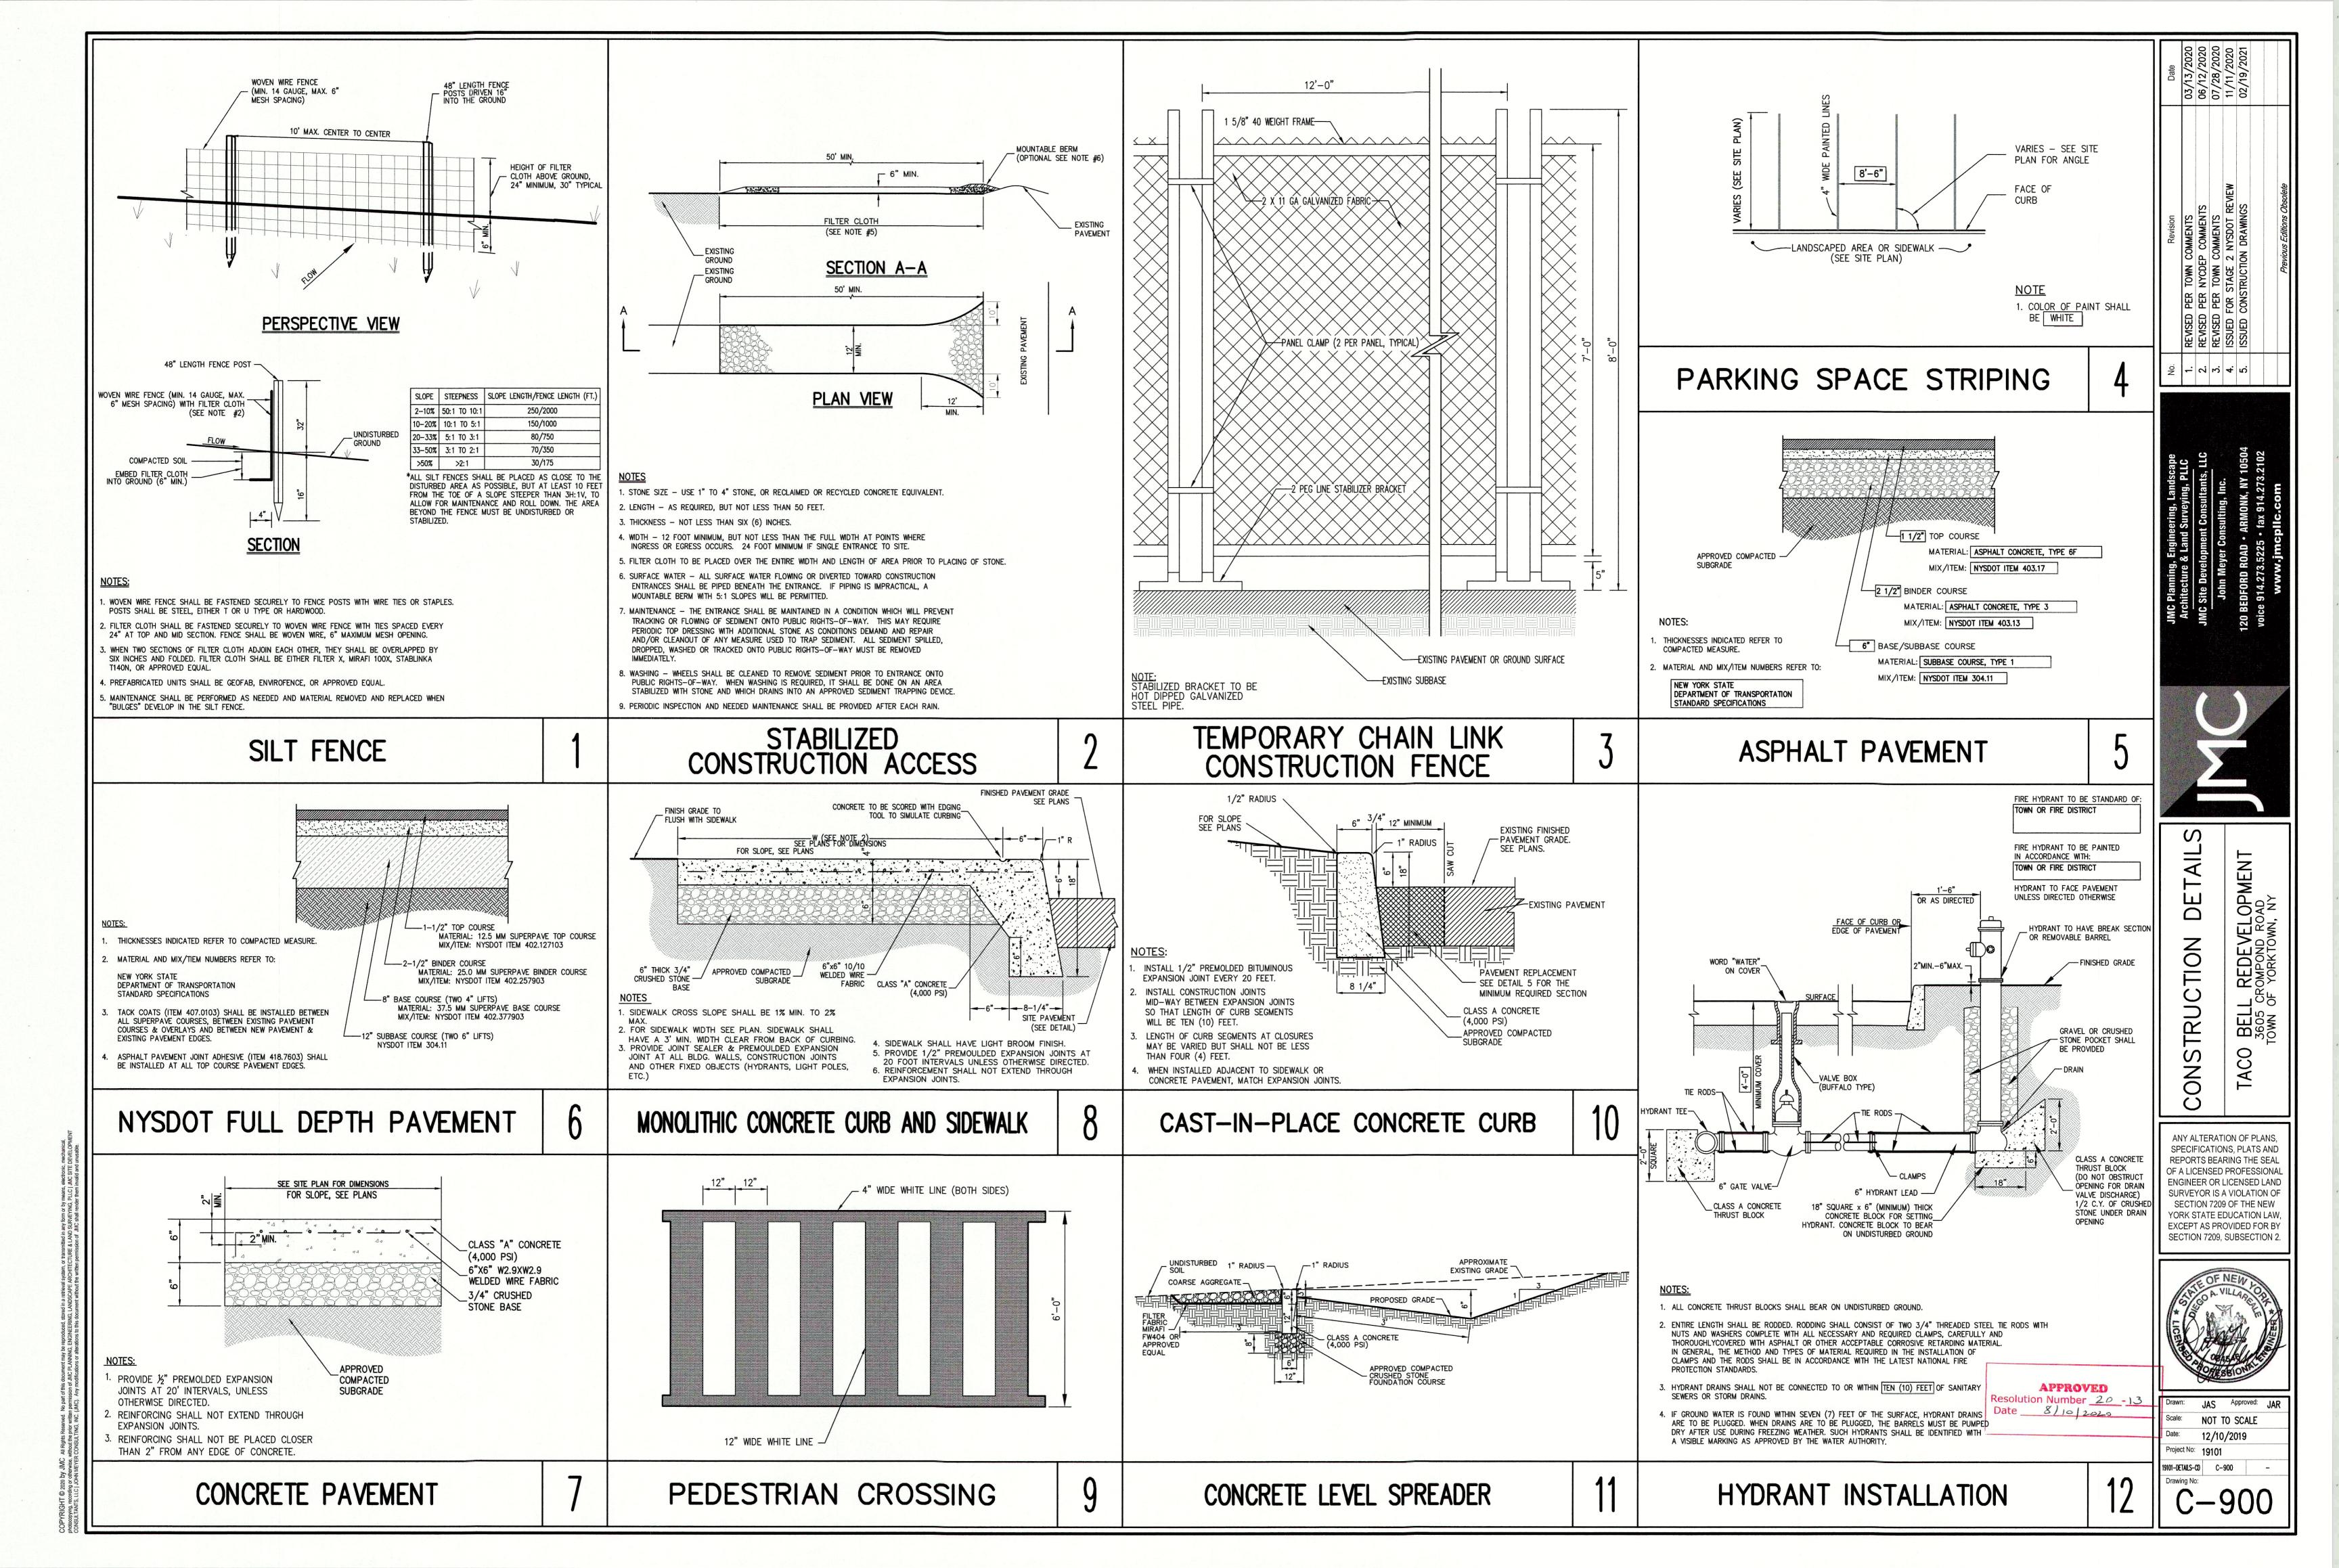


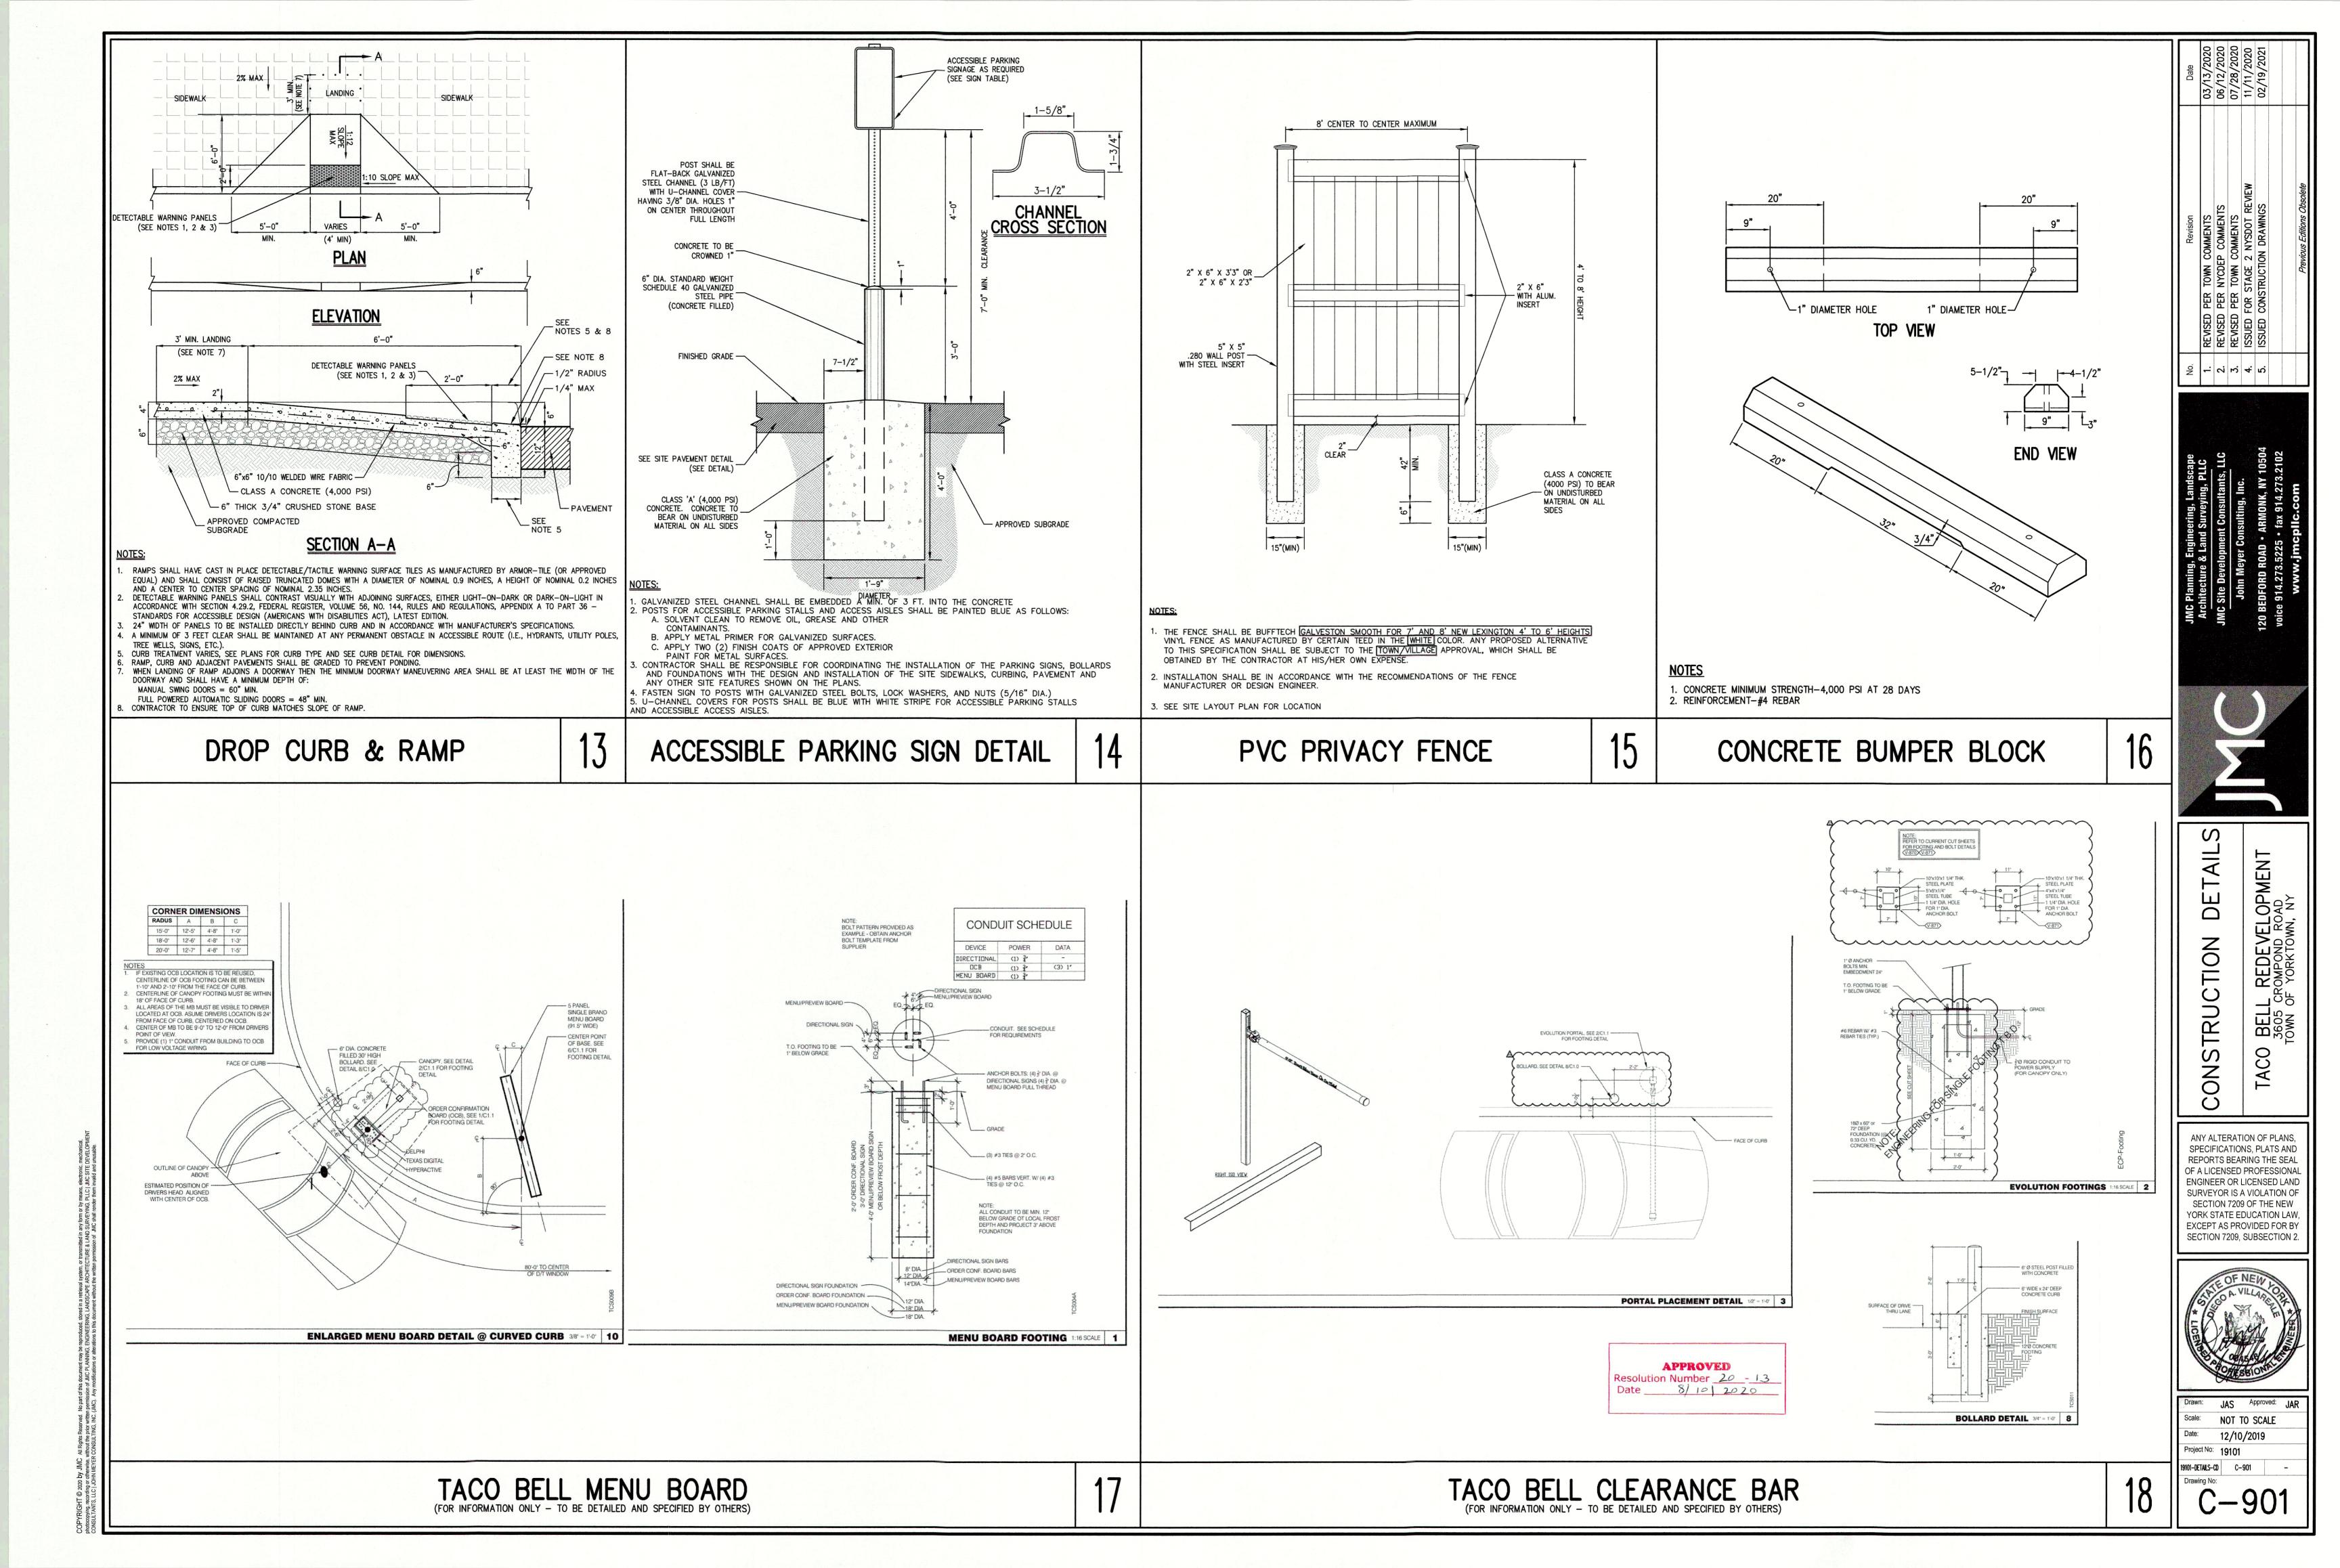


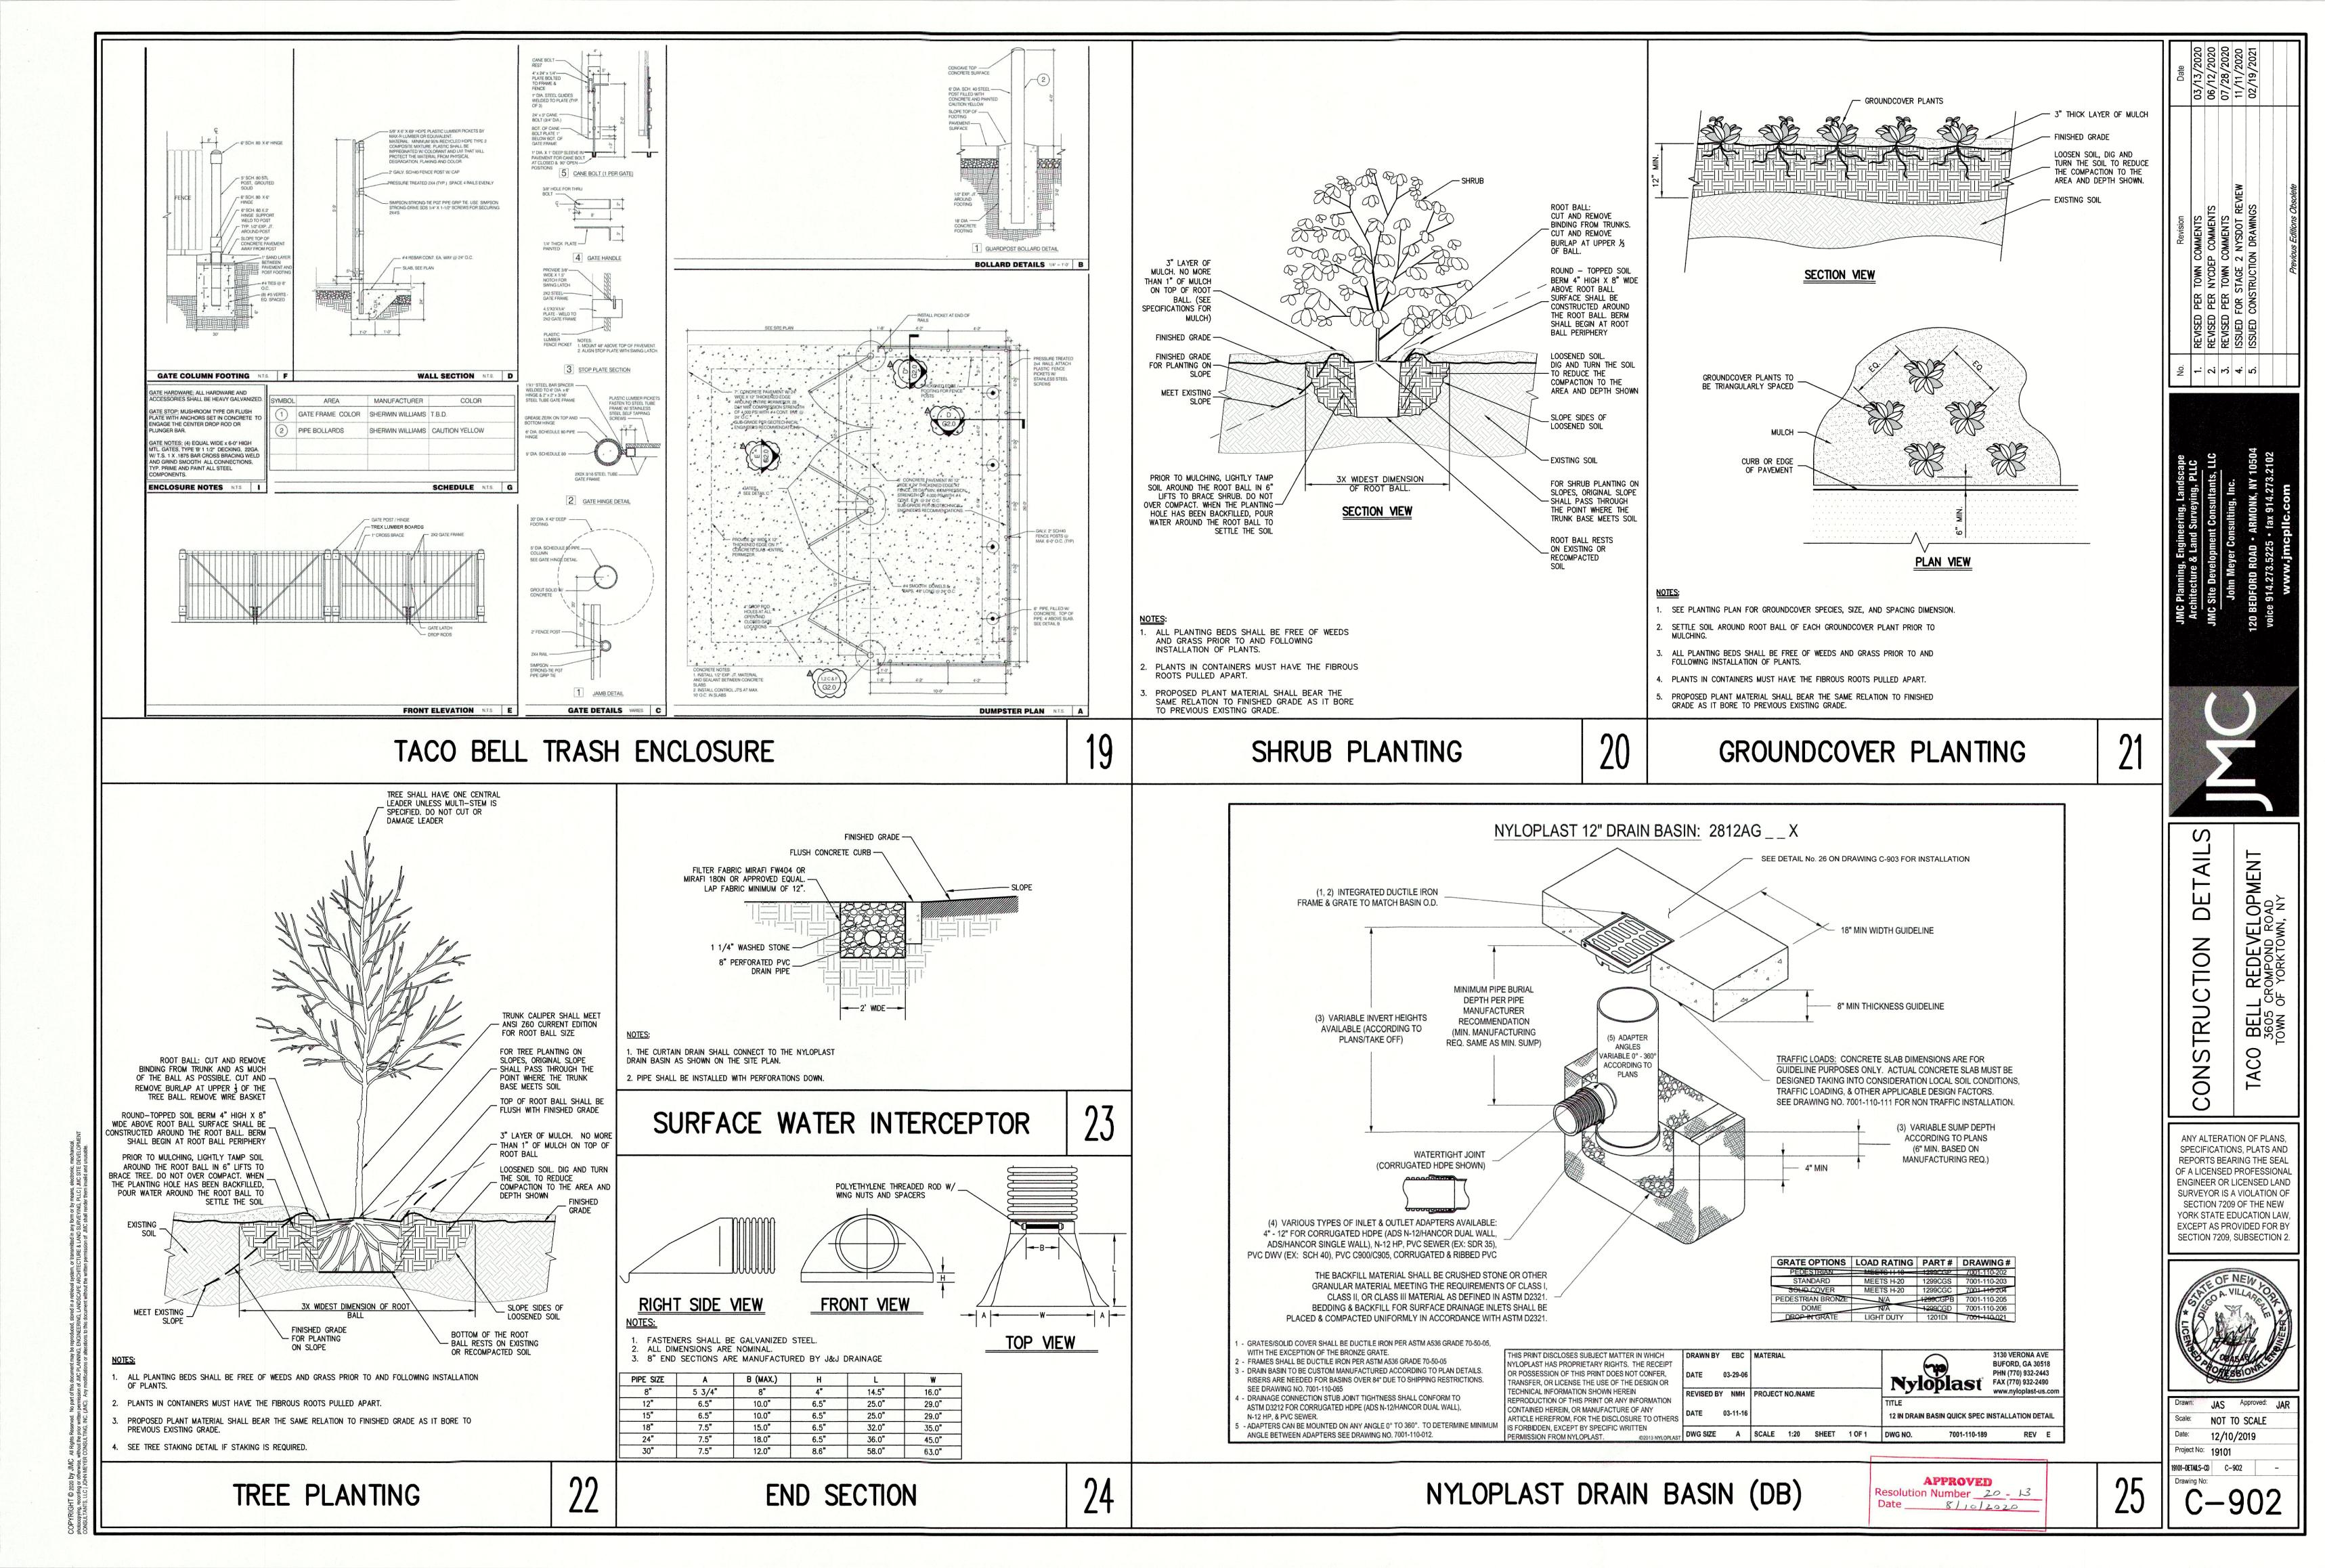

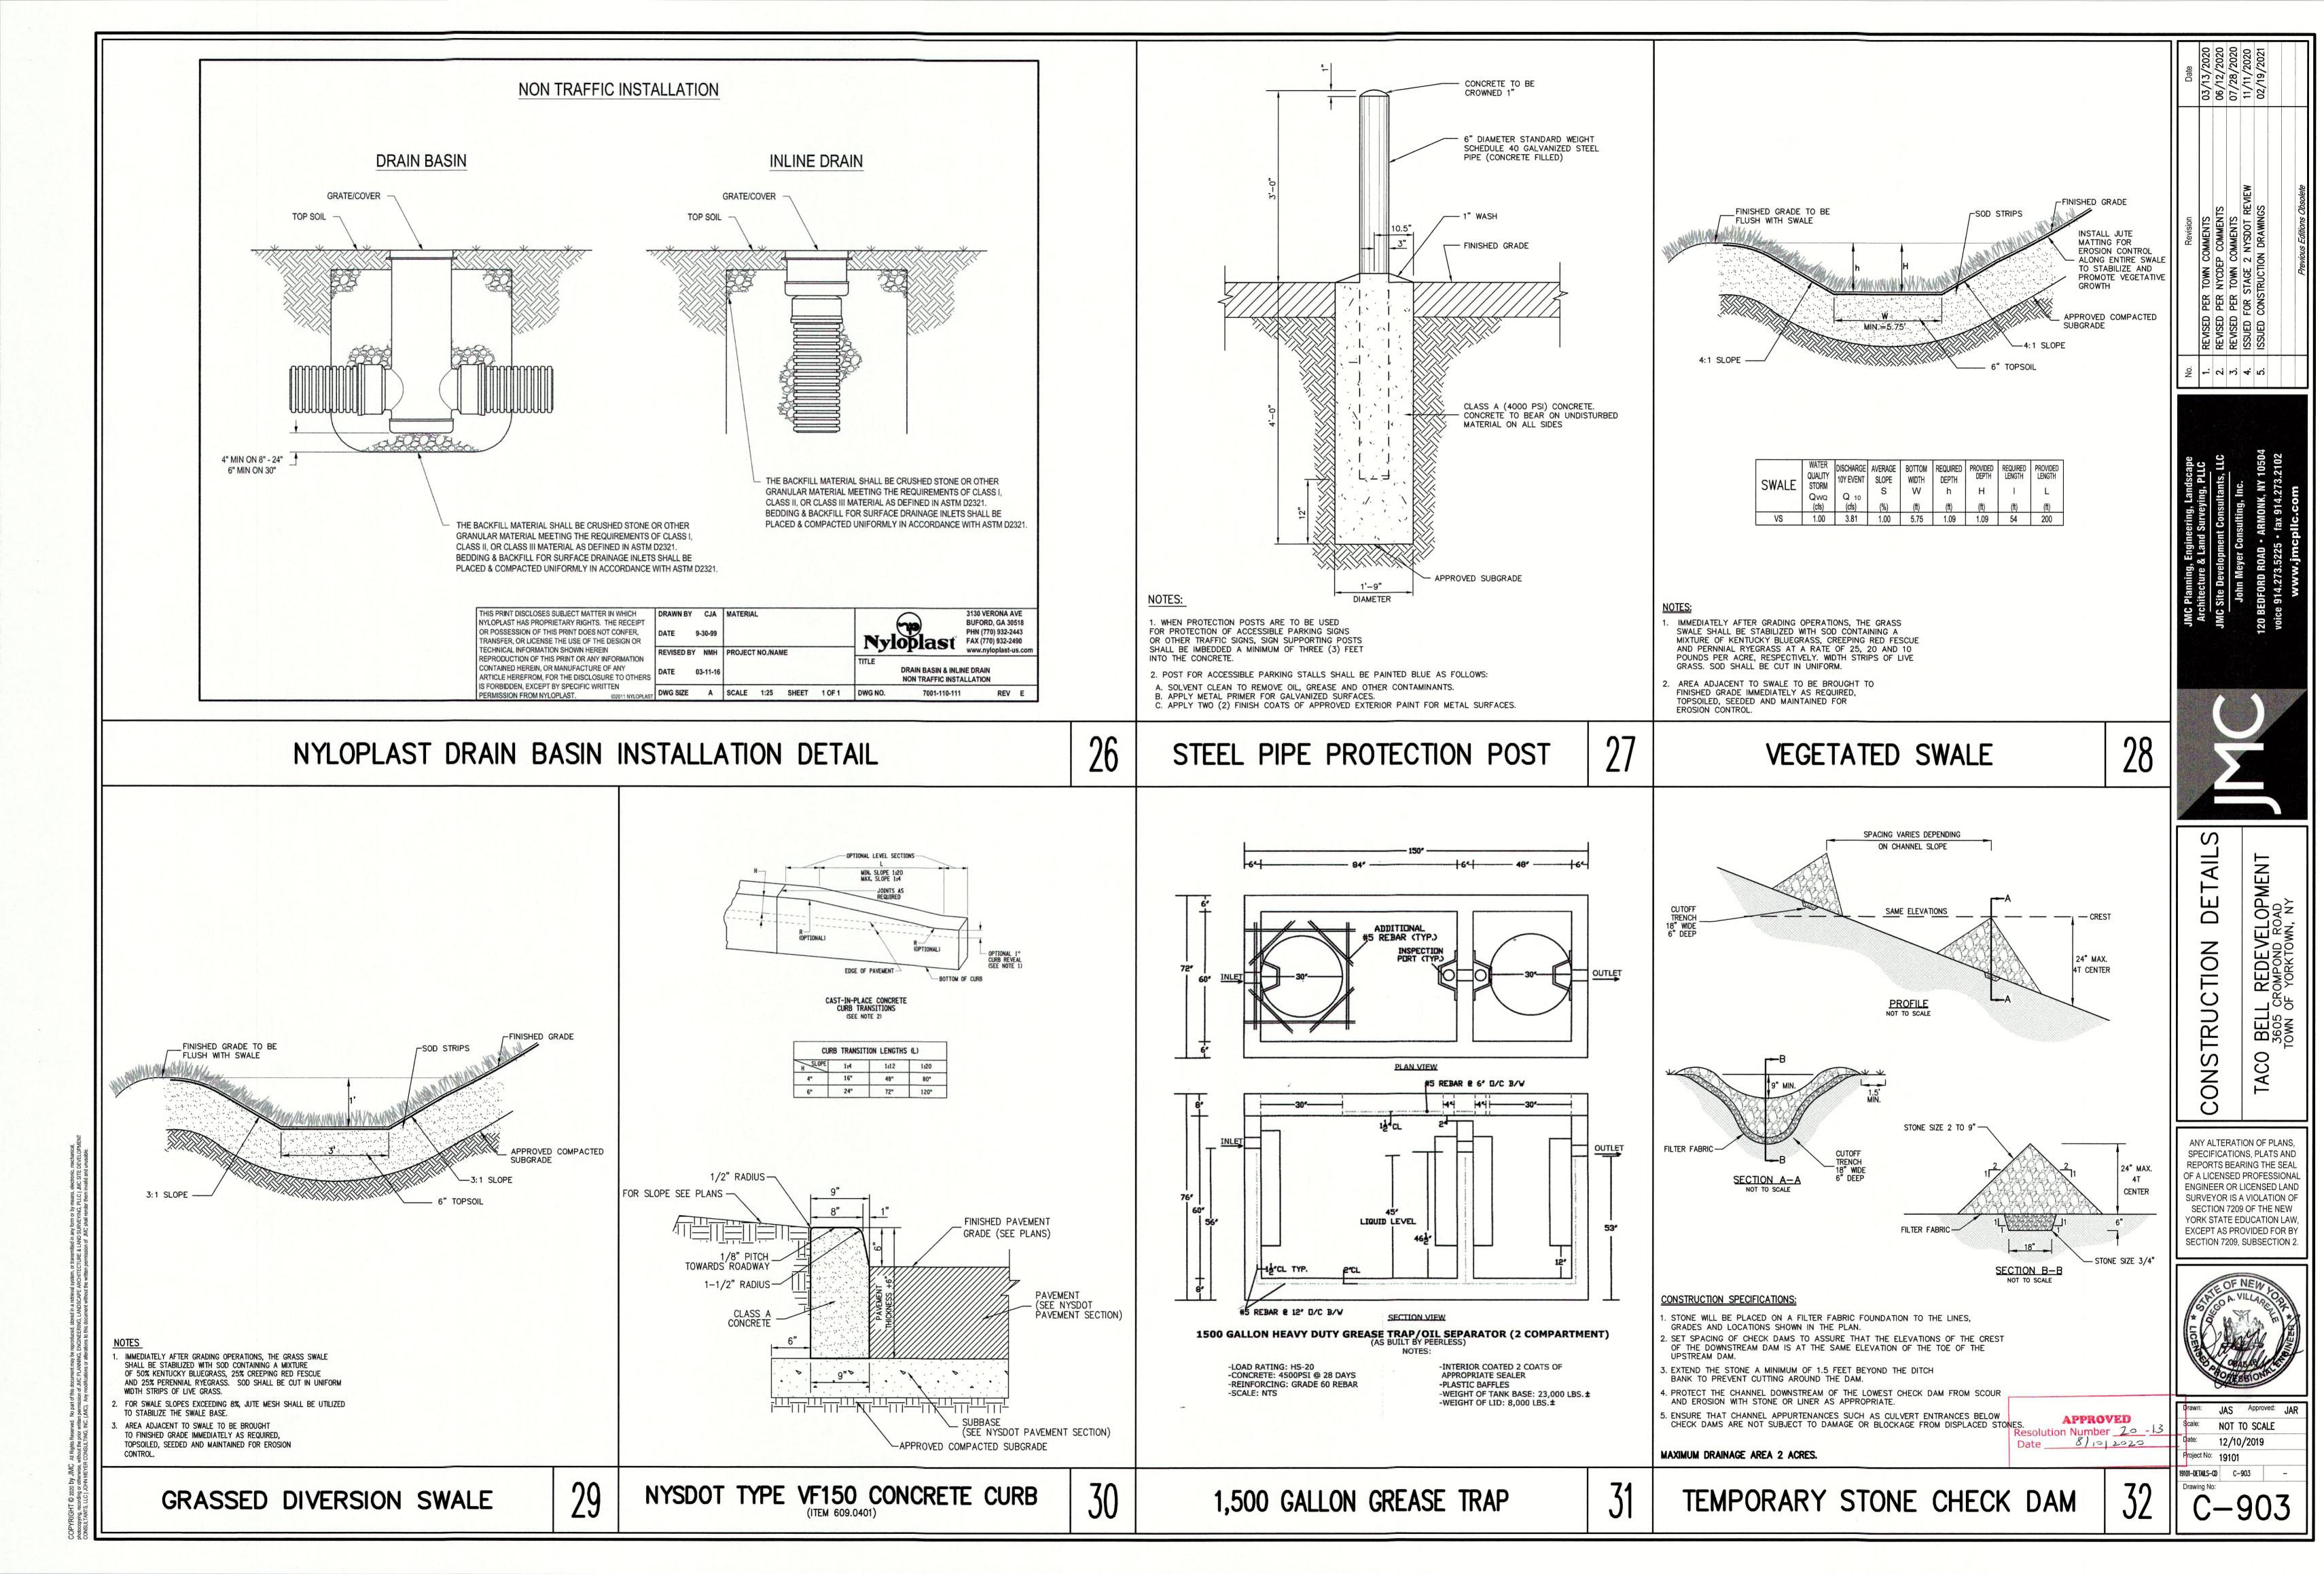


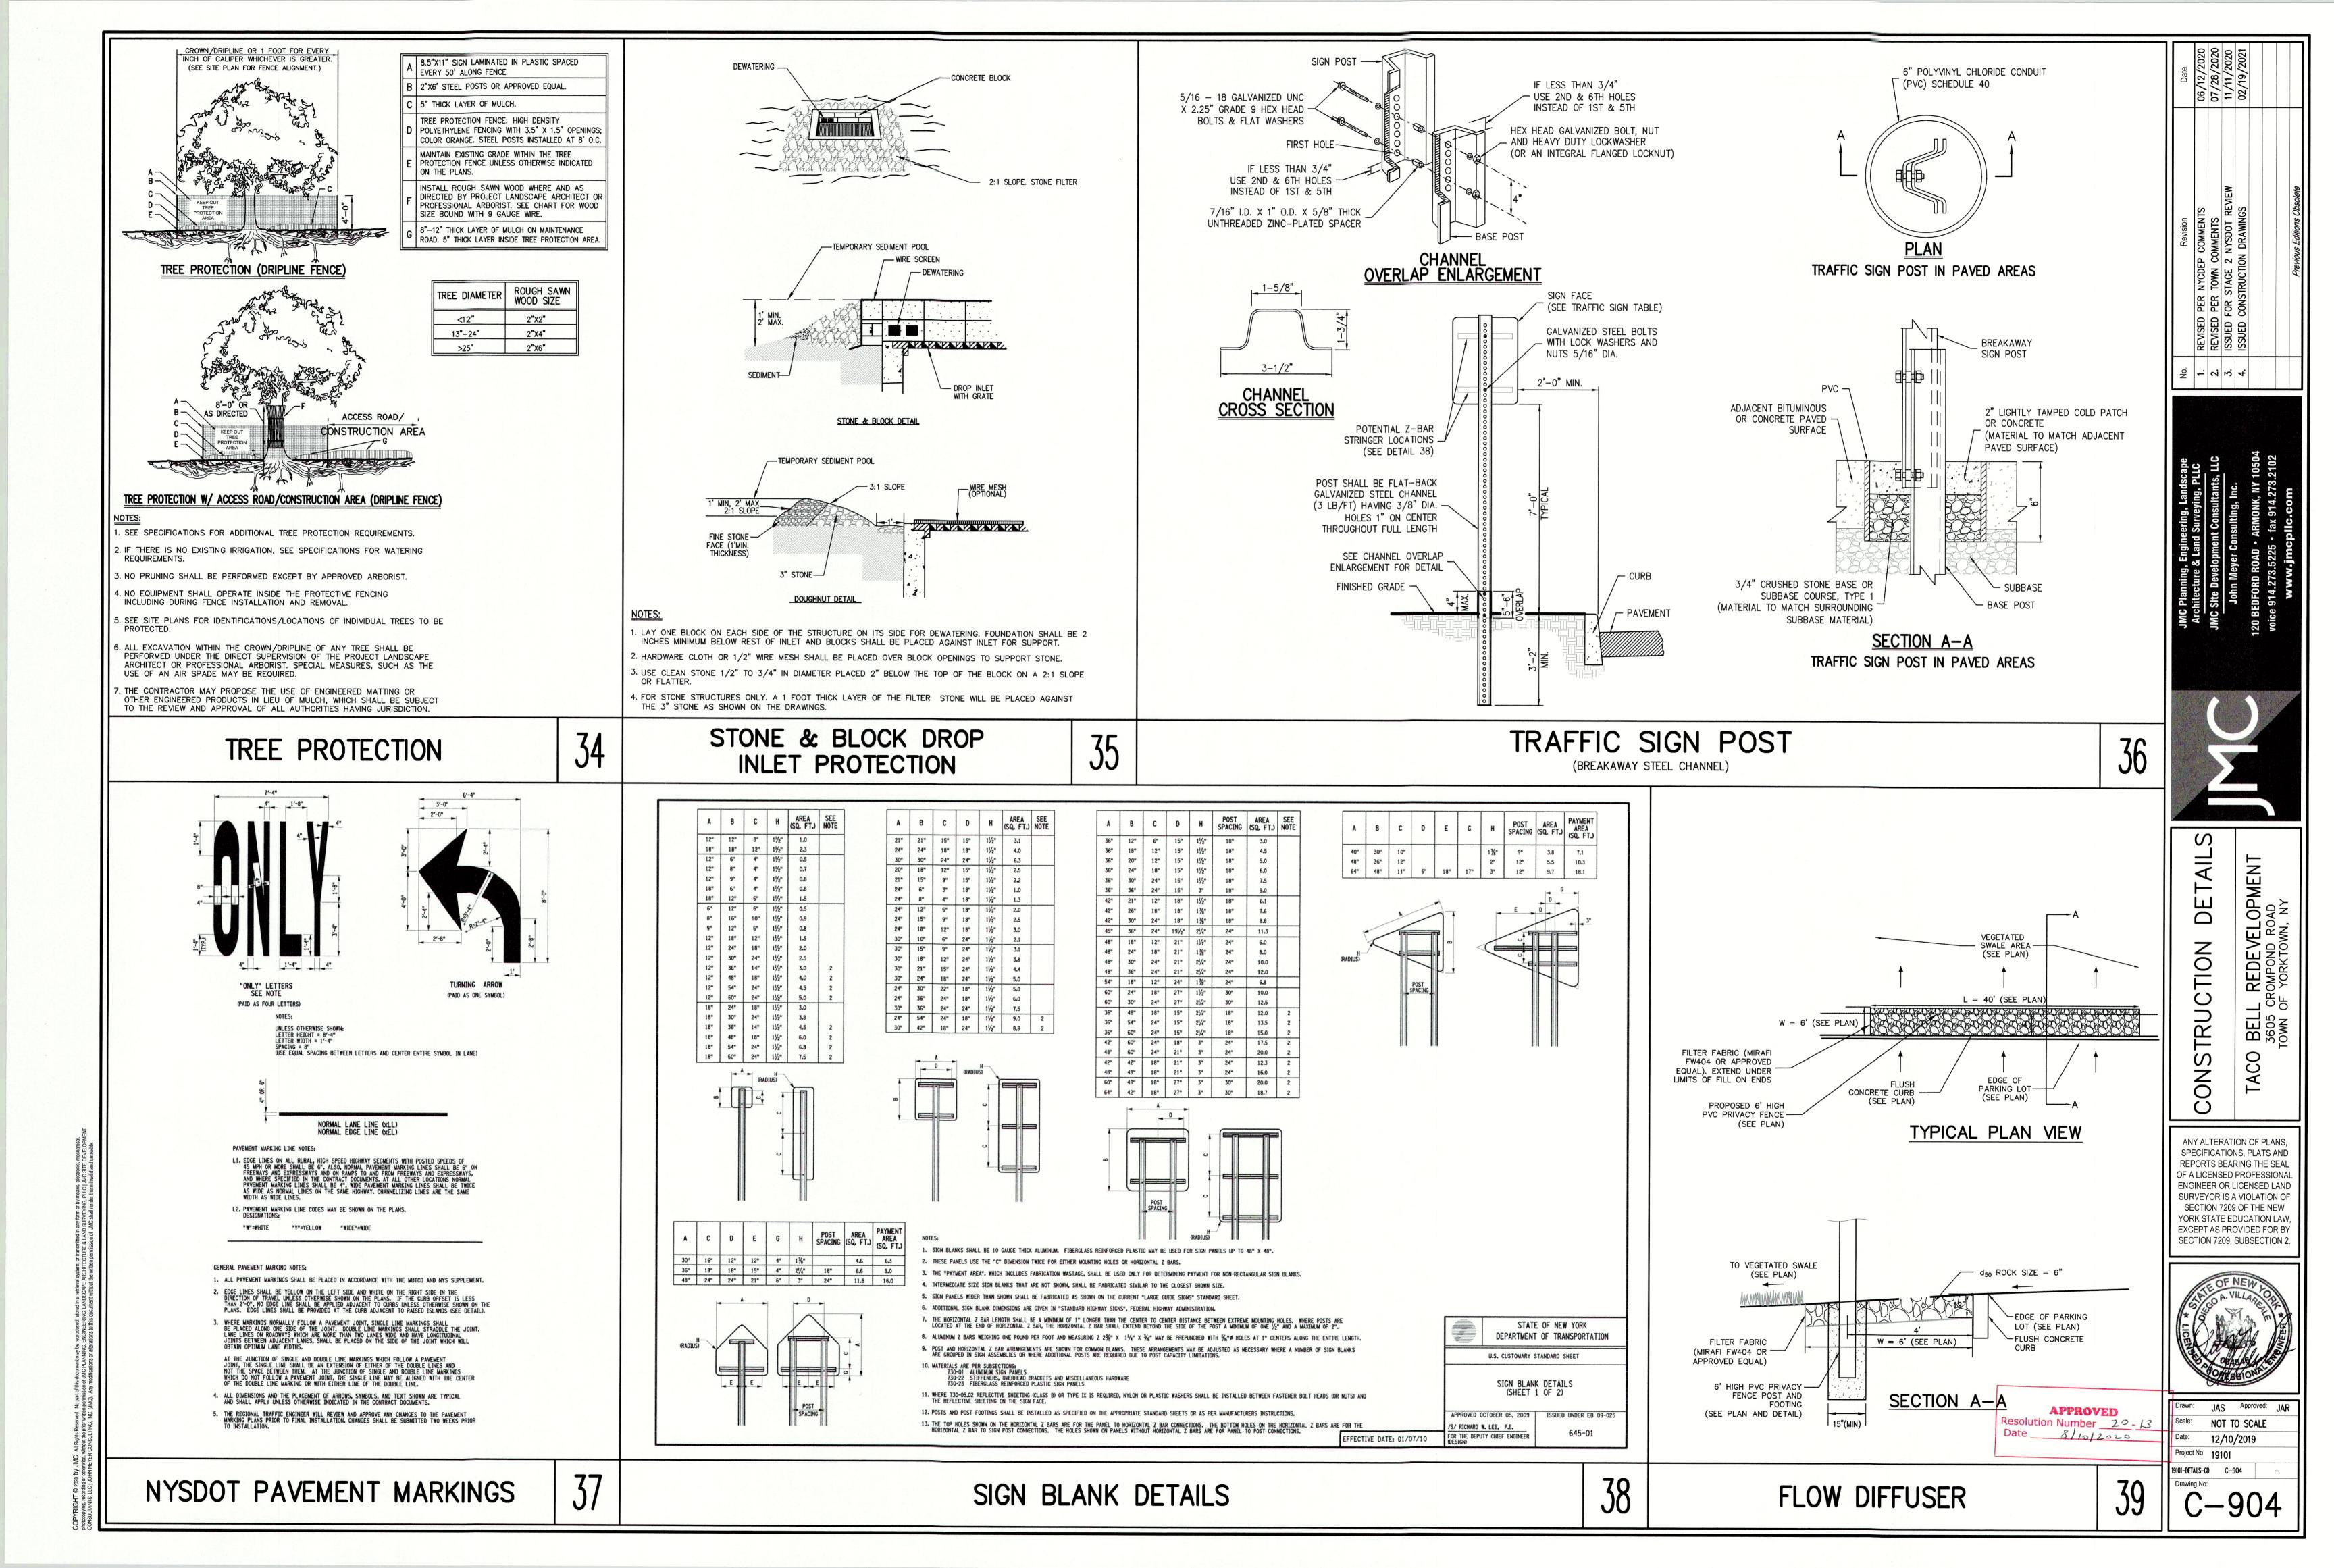

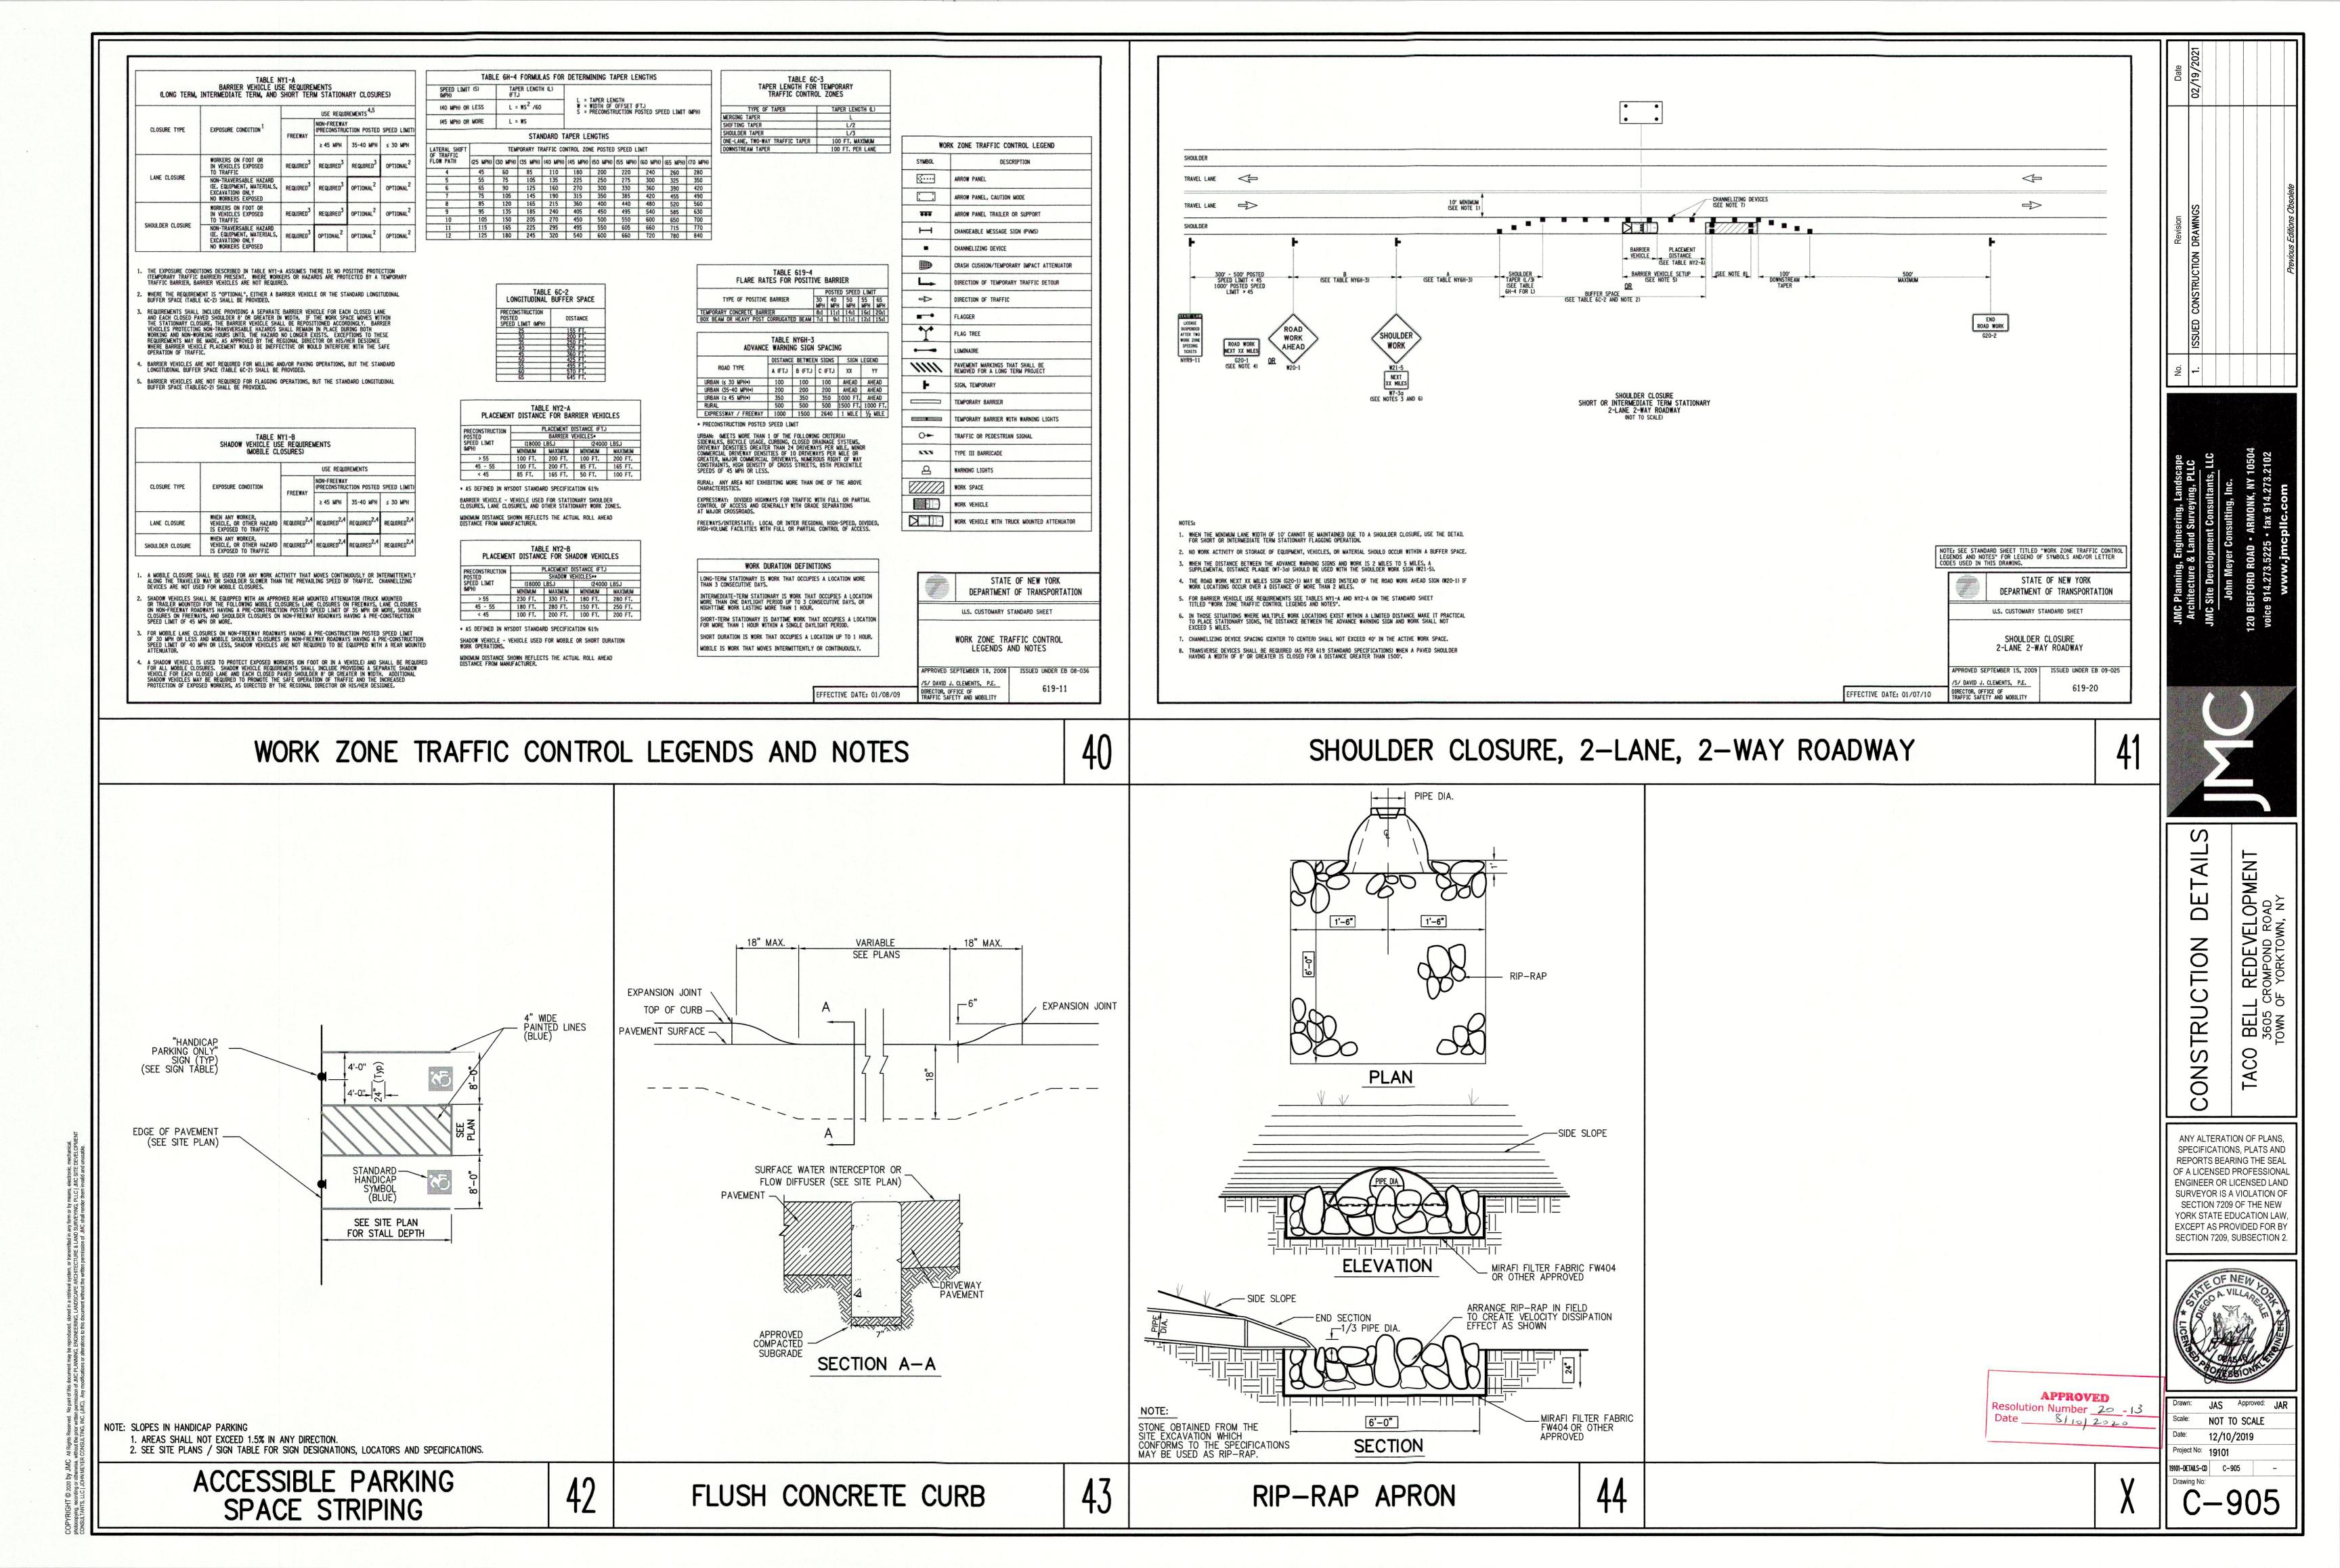

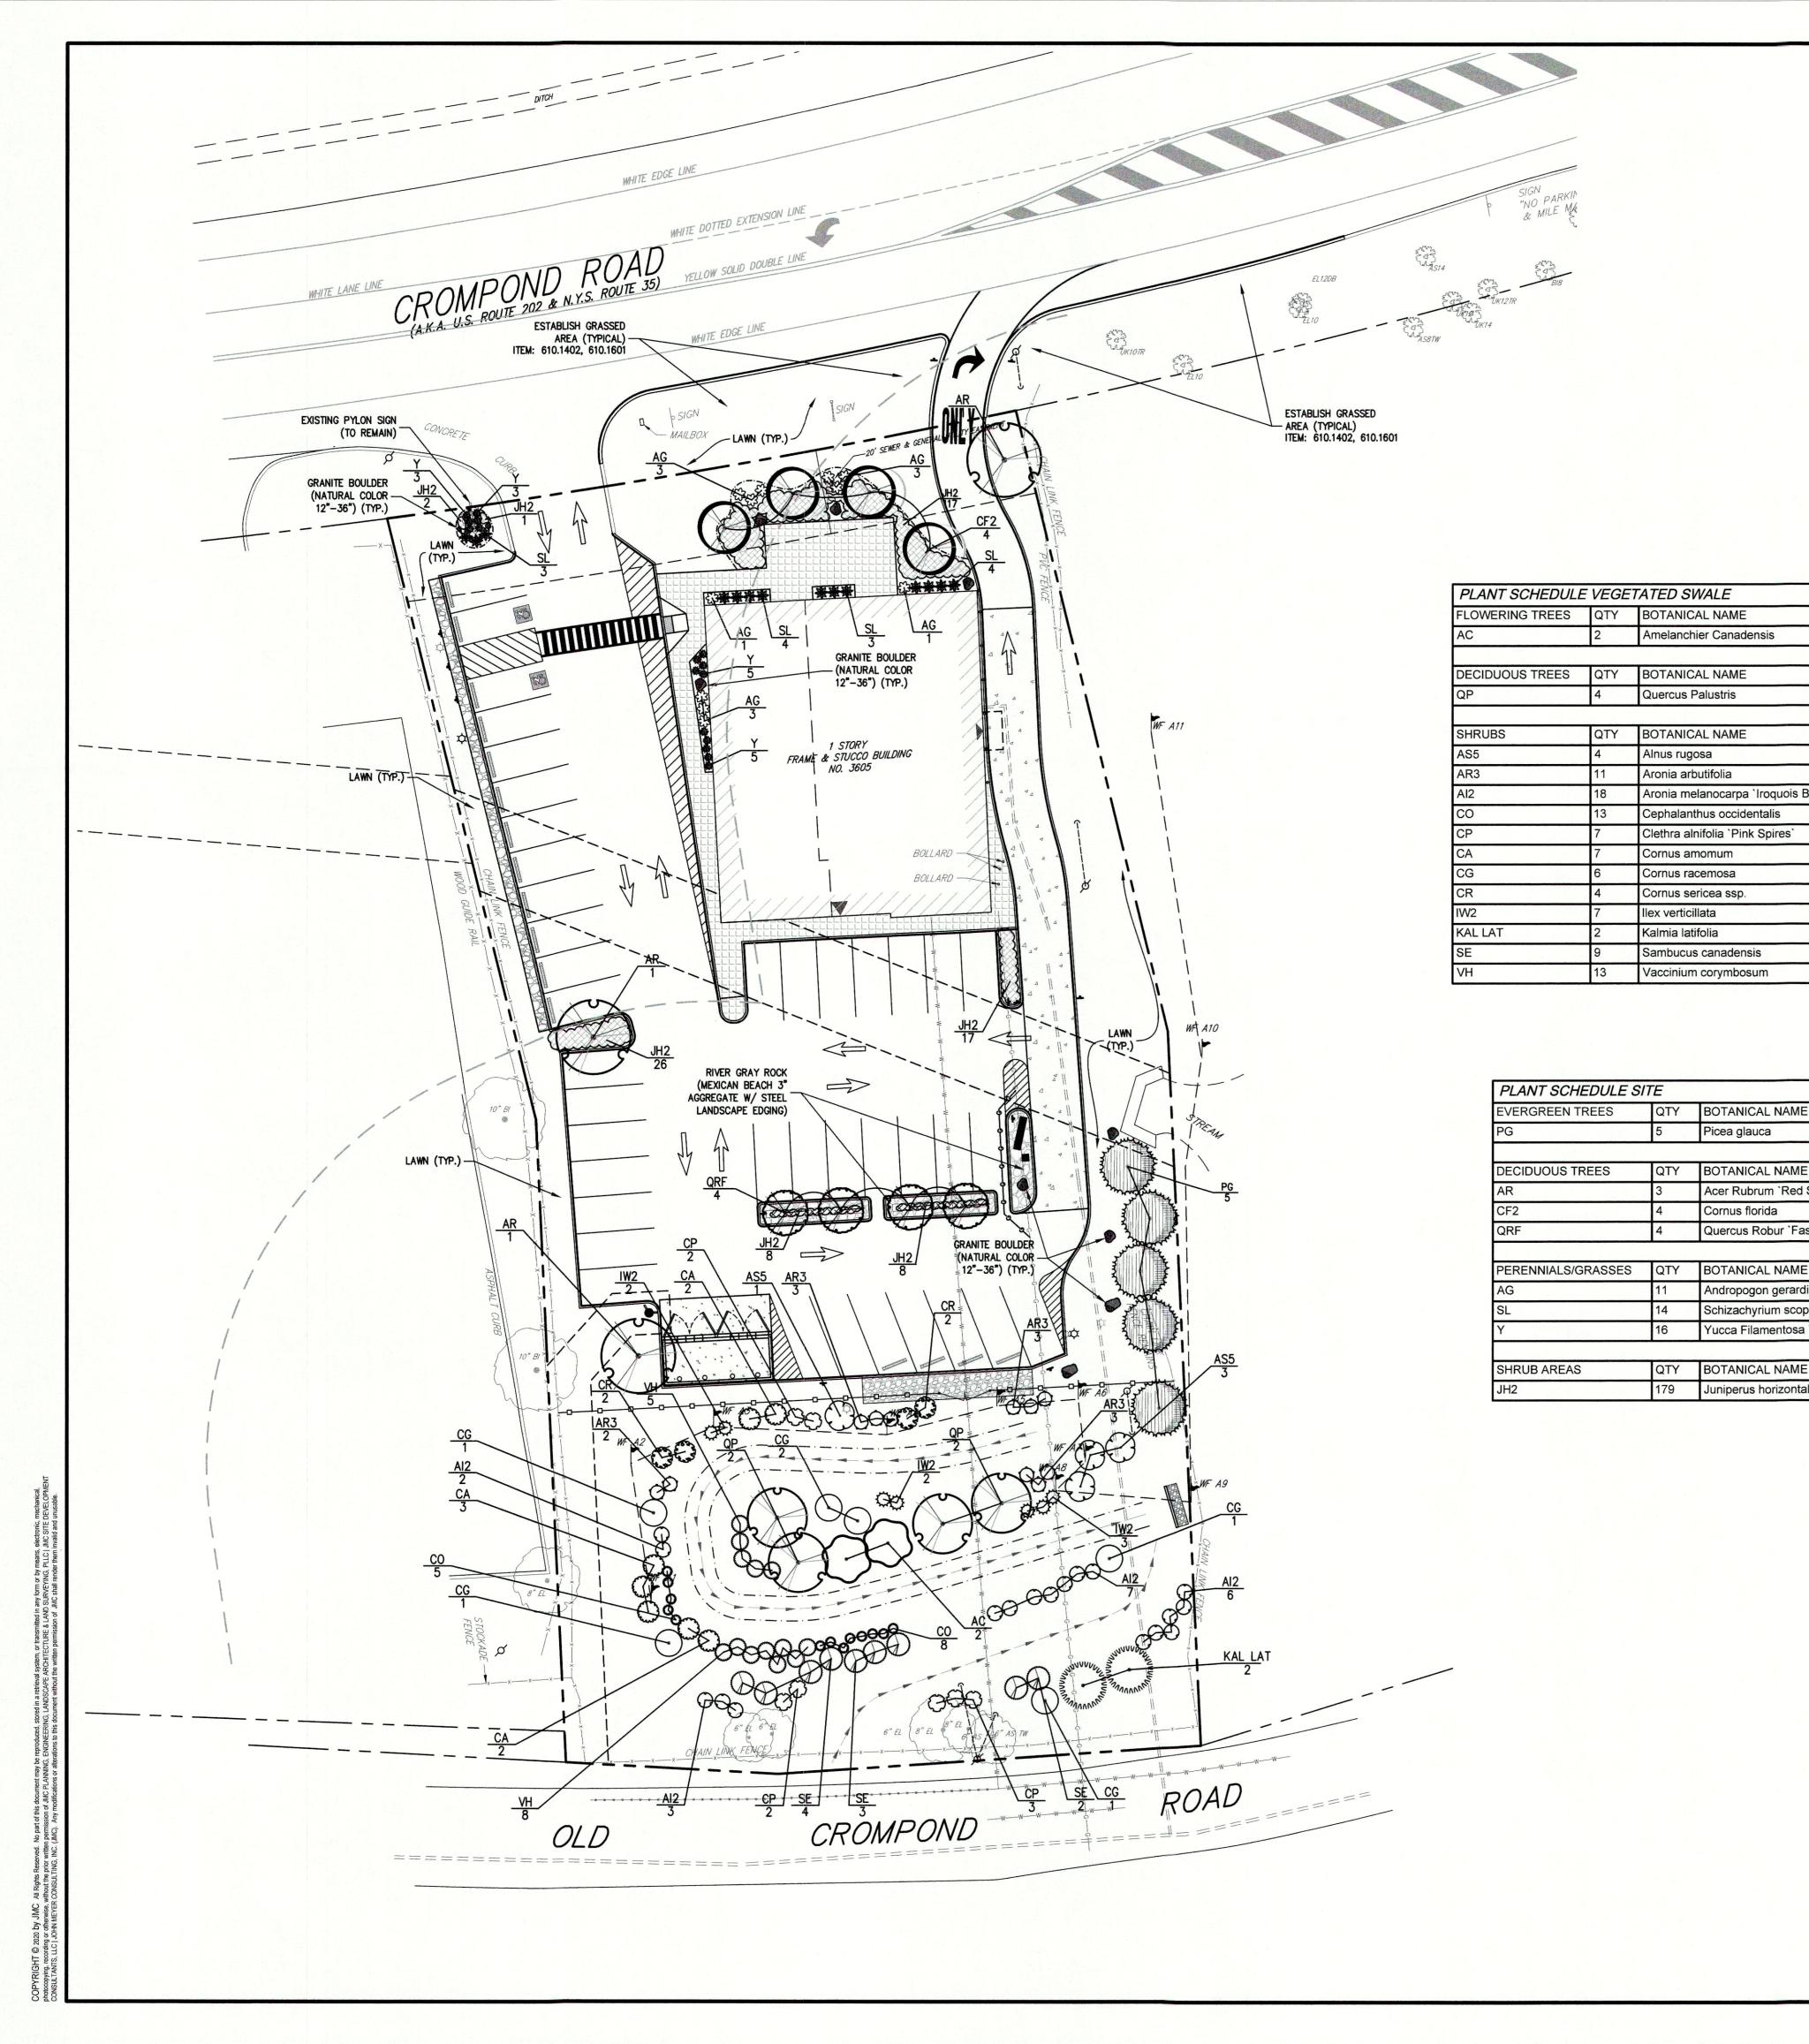



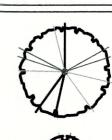

PROPOSED DECIDUOUS TREE

LEGEND





PROPOSED ACCENT TREE



PROPOSED SHRUB / PERENNIAL PROPOSED SHRUB MASSING



PROPOSED BOULDER

PROPOSED RIVER GRAY ROCK

NOTES:

- 1. ALL PLANT MATERIAL SHALL BE FIRST QUALITY STOCK. PLANTED MATERIAL AND METHODS OF INSTALLATION SHALL CONFORM TO THE AMERICAN NURSERY AND LANDSCAPE ASSOCIATION, AMERICAN STANDARD FOR NURSERY STOCK, LATEST EDITION.
- 2. ALL AREAS OF THE SITE NOT OCCUPIED BY BUILDING OR PAVEMENT AND NOT SPECIFIED AS BEING PLANTED WITH TREES, SHRUBS OR GROUND COVER SHALL
- 3. ALL PLANTING BEDS SHALL BE MULCHED WITH 3" OF BROWN MULCH. MULCH SHALL BE CLEAN, NON-DYED, TOXIC FREE, SHREDDED HARDWOOD. THE CONTRACTOR SHALL PROVIDE A SAMPLE TO THE PROJECT LANDSCAPE ARCHITECT FOR APPROVAL PRIOR TO THE INSTALLATION.
- PLANT MATERIALS AS SPECIFIED ON THE DRAWINGS AND DELIVERED TO THE SITE SHALL BE NURSERY GROWN AND CERTIFIED TRUE TO THEIR GENUS, SPECIES AND VARIETY. SUBSTITUTIONS ARE NOT PERMITTED WITHOUT THE PROJECT LANDSCAPE ARCHITECTS WRITTEN APPROVAL.
- 5. ALL LANDSCAPING SHALL CONTINUE TO BE MAINTAINED IN A HEALTHY GROWING CONDITION THROUGHOUT THE DURATION OF THE PROJECT. ANY PLANTING NOT SO MAINTAINED SHALL BE REPLACED WITH NEW PLANTS AT THE BEGINNING OF THE NEXT, IMMEDIATELY FOLLOWING, GROWING SEASON.
- ALL TREES AND SHRUBS SHALL BE PRUNED AND SHAPED AND BE SUBJECT TO THE APPROVAL OF THE PROJECT LANDSCAPE ARCHITECT AND GOVERNMENTAL AUTHORITIES HAVING JURISDICTION.
- 7. PLANTING STOCK SHALL BE WELL-BRANCHED AND WELL-FORMED, SOUND, VIGOROUS, HEALTHY, FREE FROM DISEASE, SUN-SCALE, WINDBURN, ABRASION, AND HARMFUL INSECTS OR INSECTS EGGS; AND SHALL HAVE HEALTHY, NORMAL UNBROKEN ROOT SYSTEMS. DECIDUOUS TREES AND SHRUBS SHALL BE SYMMETRICALLY DEVELOPED. OF UNIFORM HABIT OF GROWTH, WITH STRAIGHT TRUNKS OR STEMS, AND FREE FROM OBJECTIONABLE DISFIGUREMENTS. EVERGREEN TREES AND SHRUBS SHALL HAVE WELL-DEVELOPED SYMMETRICAL TOPS WITH TYPICAL SPREAD OF BRANCHES FOR EACH PARTICULAR SPECIES OR VARIETY. ONLY VINES AND GROUND COVER PLANTS WELL ESTABLISHED IN REMOVAL CONTAINERS, INTEGRAL CONTAINERS, OR FORMED HOMOGENEOUS SOIL SECTIONS SHALL BE USED. PLANTS SHALL BE GROWN UNDER CLIMATIC CONDITIONS SIMILAR TO THOSE IN THE LOCALITY OF THE PROJECT.
- 8. ALL STOCK SHALL BE BALLED AND BURLAPPED OR CONTAINER GROWN STOCK, UNLESS OTHERWISE SPECIFIED. BAREROOT STOCK OF ANY KIND IS UNACCEPTABLE UNLESS SPECIFIED.
- 9. ALL PLANTING BEDS, LAWNS AND LANDSCAPED AREAS SHALL RECEIVE A MINIMUM 4" THICK LAYER OF TOPSOIL, UNLESS OTHERWISE SPECIFIED.
- 10. THE CONTRACTOR SHALL FIELD LOCATE ALL UTILITIES WITHIN THE PLANTING AREAS SO AS NOT TO PLANT TREES OR PLACE BOULDERS OVER THEM.
- 11. FINAL LOCATION OF ALL PLANT MATERIALS SHALL BE SUBJECT TO APPROVAL BY PROJECT LANDSCAPE ARCHITECT. PROJECT LANDSCAPE ARCHITECT MAY ADJUST SPACING AND LOCATION IN FIELD PRIOR TO OR AFTER PLANTING.
- 12. CONTRACTOR SHALL IMMEDIATELY REPORT ANY UNSATISFACTORY SITE CONDITIONS TO THE OWNER IN WRITING. CONTRACTOR SHALL RECEIVE NO ADDITIONAL PAYMENT FOR ADDITIONAL WORK ASSOCIATED WITH THE UNSATISFACTORY CONDITIONS IF NOT PROPERLY REPORTED AND WITHOUT PRIOR WRITTEN APPROVAL OF THE OWNER.


Resolution Number 20 -

8/10/2020




WIENE.

 O_{i}

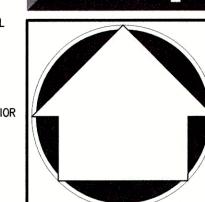

OPMENT LANDSCAPING , AND MITIGATION VEL BO RO REDE **BEL** 3605 00

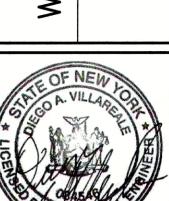

FOUR SEASON LANDSCAPING MAINTENANCE SCHEDULE (BY OWNER):

SPRING: GENERAL CLEANUP AND MAINTENANCE TO BE PERFORMED AROUND THE ENTIRE PROPERTY. PRUNE AND MAINTAIN TREES AND SHRUBS AS REQUIRED TO MAINTAIN THE NATURAL PLANT APPEARANCE. ALL FALLEN AND DEAD BRANCHES ARE TO BE REMOVED. ANY DEAD PLANTS ARE TO BE REPLACED. FERTILIZER IS TO BE USED ON THE TREES (ERICACEOUS FERTILIZER ON ALL AZALEAS). SHRUB FERTILIZATION SHALL BE PERFORMED USING SLOW RELEASE, COMPLETE ORGANIC BASED PRODUCTS. WEED KILLER TO BE USED ON LAWN AS A PRE-EMPTIVE EFFORT TO PREVENT GROWTH.

SUMMER: LAWN IS TO BE MOWED AS REQUIRED TO MAINTAIN A GRASS HEIGHT OF 3 INCHES. ALL FALLEN OR DEAD BRANCHED TO BE REMOVED AS REQUIRED. ANY DEAD PLANTS ARE TO BE REPLACED. ALL OPEN LAWN AREAS ARE TO BE WATERED AS CONDITIONS DICTATE THROUGHOUT THE

GENERAL CLEANUP AROUND PROPERTY TO BE CONDUCTED AS REQUIRED. LEAVES AND BRANCHES ARE TO BE CLEARED FROM ALL OPEN LAWN AREAS. ALL BARE SPOTS ON THE LAWN ARE TO BE FERTILIZED AND RESEEDED AS NECESSARY. SHRUB FERTILIZATION SHALL BE PERFORMED USING SLOW RELEASE, COMPLETE ORGANIC BASED

WINTER: GENERAL CLEANUP AND MAINTENANCE AROUND PROPERTY TO BE PERFORMED AS NECESSARY. ANY AND ALL DEAD OR FALLEN BRANCHES TO BE REMOVED FROM LAWN.

ANY ALTERATION OF PLANS,
SPECIFICATIONS, PLATS AND
REPORTS BEARING THE SEAL
OF A LICENSED PROFESSIONAL
ENGINEER OR LICENSED LAND
SURVEYOR IS A VIOLATION OF
SECTION 7209 OF THE NEW
YORK STATE EDUCATION LAW,
EXCEPT AS PROVIDED FOR BY
SECTION 7209, SUBSECTION 2.

A LICENSON	OF A STATE OF THE PARTY OF THE	NEW XO	MERK SE
Drawn:	IAC	Approved:	IAD

No.	Revision	Date	Ву
1.	REVISED PER TOWN COMMENTS	03/13/2020	PD
2.	REVISED PER ABACA COMMENTS	05/07/2020	PD
3.	REVISED PER TOWN COMMENTS	05/26/2020	PD
4.	REVISED PER NYCDEP COMMENTS	06/12/2020	PD
5.	REVISED PER TOWN COMMENTS	07/28/2020	PD
6.	ISSUED FOR STAGE 2 NYSDOT REVIEW	11/11/2020	KRM
7.	ISSUED CONSTRUCTION DRAWINGS	02/19/2021	PD
	Previous Editions Obsolete		

-
R
.ls

GRAPHIC SCALE

VEGETATED SWALE

Pin Oak

COMMON NAME

COMMON NAME

Speckled Alder

Red Chokeberry

Black Chokeberry

Summersweet Clethra

Buttonbush

Silky Dogwood

Gray Dogwood

Winterberry

Elderberry

Mountain Laurel

Highbush Blueberry

UPPER SITE

COMMON NAME

COMMON NAME

Eastern Dogwood

COMMON NAME

COMMON NAME

Creeping Juniper

Big Bluestem

Pyramidal English Oak

Little Bluestem Grass

Yellow Adam's Needle

White Spruce

Red Maple

Red Twig Dogwood

Shadblow Serviceberry

SIZE

SIZE

3 gal

3 gal

2 gal

2 gal.

SIZE

3" - 3 1/2" Cal.

3" - 3 1/2" Cal.

8`-10` HT

2 gal.

2" - 2 1/2" Cal.

2" - 2 1/2" Cal.

ROOT COND.

ROOT COND.

ROOT COND. REMARKS

ROOT COND. REMARKS

REMARKS

REMARKS

REMARKS

B&B

B & B

Cont.

Cont.

Cont.

Cont.

B&B

B&B

B & B

B & B

Cont.

Cont.

ROOT COND.

ROOT COND.

ROOT COND.

REMARKS

REMARKS

BOTANICAL NAME

Quercus Palustris

BOTANICAL NAME

Aronia arbutifolia

Cornus amomum

Cornus racemosa

Cornus sericea ssp

Sambucus canadensis

Vaccinium corymbosum

QTY BOTANICAL NAME

Picea glauca

BOTANICAL NAME

Cornus florida

QTY BOTANICAL NAME

179 Juniperus horizontalis

Acer Rubrum 'Red Sunset'

Quercus Robur 'Fastigiata'

Andropogon gerardii

Schizachyrium scoparium

Yucca Filamentosa `Starburst`

llex verticillata

Kalmia latifolia

Cephalanthus occidentalis

Clethra alnifolia `Pink Spires`

Aronia melanocarpa `Iroquois Beauty` TM

Alnus rugosa

Amelanchier Canadensis

(IN FEET) 1 inch = 20 ft.

Luminaire	e Sched	lule					
Symbol	Qty	Label	Arrangement	LMF	Lum. Lumens	Lum. Watts	Part Number
0-	2	3MB-120	SINGLE	1.000	25117	421	ARE-EHO-3MB-HV-12-E-UL-XX-1000
0—4	3	4MB-120	SINGLE	1.000	26977	421	ARE-EHO-4MB-HV-12-E-UL-XX-1000
\odot	15	W	SINGLE	1.000	N.A.	58.9	CL-P5642-30K
	1	2M-6L	SINGLE	1.000	6100	47	XSPW-B-WM-2ME-6L-57K-UL-XX
	2	4M-8L	SINGLE	1.000	8475	71	XSPW-B-WM-4ME-8L-57K-UL-XX

Calculation Summary; 1.	00 LLF					
Label	Units	Avg	Max	Min	Avg/Min	Max/Min
All Calc Points	Fc	1.97	20.3	0.0	N.A.	N.A.
Property Line	Fc	0.31	1.0	0.0	N.A.	N.A.
Paved Parking	Fc	5.28	20.3	0.0	N.A.	N.A.

Poles Existing to be used: 18' AFC

ADDITIONAL EQUIPMENT REQUIRED (5) - PB-1A4XX - (Single Vertical Tenon)

***Isolines set to 0.5FC ***

NOTES: 1.0FC Max at PL

This is an LED Light Source

0.7 0.7 0.7 0.6 0.5 0.4 0.3 0.2 0.1 0.1 MH: 7.5 Orient: 90 0 1 0.5 0.4 0.4 0.4 0.3 0.3 0.2 0.1 0.1 Tilt: 0 3 1 0.4 0.3 0.9 3.3 0.3 0.2 0.2 0.1 0.1 0.0 0.8 0.0 0.0 0.1 0.1 0.2 0.3 0.5 1.0 2.0 3.0 3.2 3.1 2.9 2.8 2.5 2.2 1.9 1.8 1.9 2.4 3.W Okient: 0 2.2 0.1 0.3 0.20 0.2 0.2 0.2 0.1 0.1 0.1 0.0 0.0 0.0 0.0 0.1 0.1 0.2 0.3 0.5 10 1.6 2.6 4.1 4.5 3.4 3.0 2.5 2.1 1.7 1.4 1.3 1.5 8.2 3.7 4.3 5 MH: 60 3.0 0.1 0.2 0.2 0.2 0.1 0.1 0.1 0.0 0.0 0.0 0.0 0.1 0.1 0.2 0.3 0.6 1.0 1.9 3.6 6.3 7.1 5.1 4.6 3.7 2.7 2.0 1.6 1.6 1/8 2.5 3. MH; 7.5 8 Tilt: 0 3.5 0.1 0.0 0.1 0.1 0.1 0.1 0.1 0.1 0.4 0.0 0.0 0.0 0.1 0.1 0.1 0.1 0.1 MH: 12 Orient: 270 0.0 0.0 0.1 0.0 001 0.1 0.1 0.1

Resolution Number 20 - 13
Date August 10, 2020

CREE LIGHTING

9201 Washington Ave, Racine, WI 53406 https://creelighting.com - (800) 236-6800

Illumination results shown on this lighting design are based on project parameters provided to Cree Lighting used inconjunction with luminaire test procedures conducted under laboratory conditions. Actual project conditions differing from these design parameters may affect field results. The customer is responsible for verifying dimensional accuracy along with compliance with any applicable electrical, lighting, or energy code.

Project Name: Taco Bell - 3605 Crompond Road, Yorktown, NY- EXT

SR-40412


Footcandles calculated at grade

Filename: TB-200123YTNYCJWR4.AGJate:5/7/2020

Layout By: Collin Witherow

Scale 1" = 16'

0 32 64

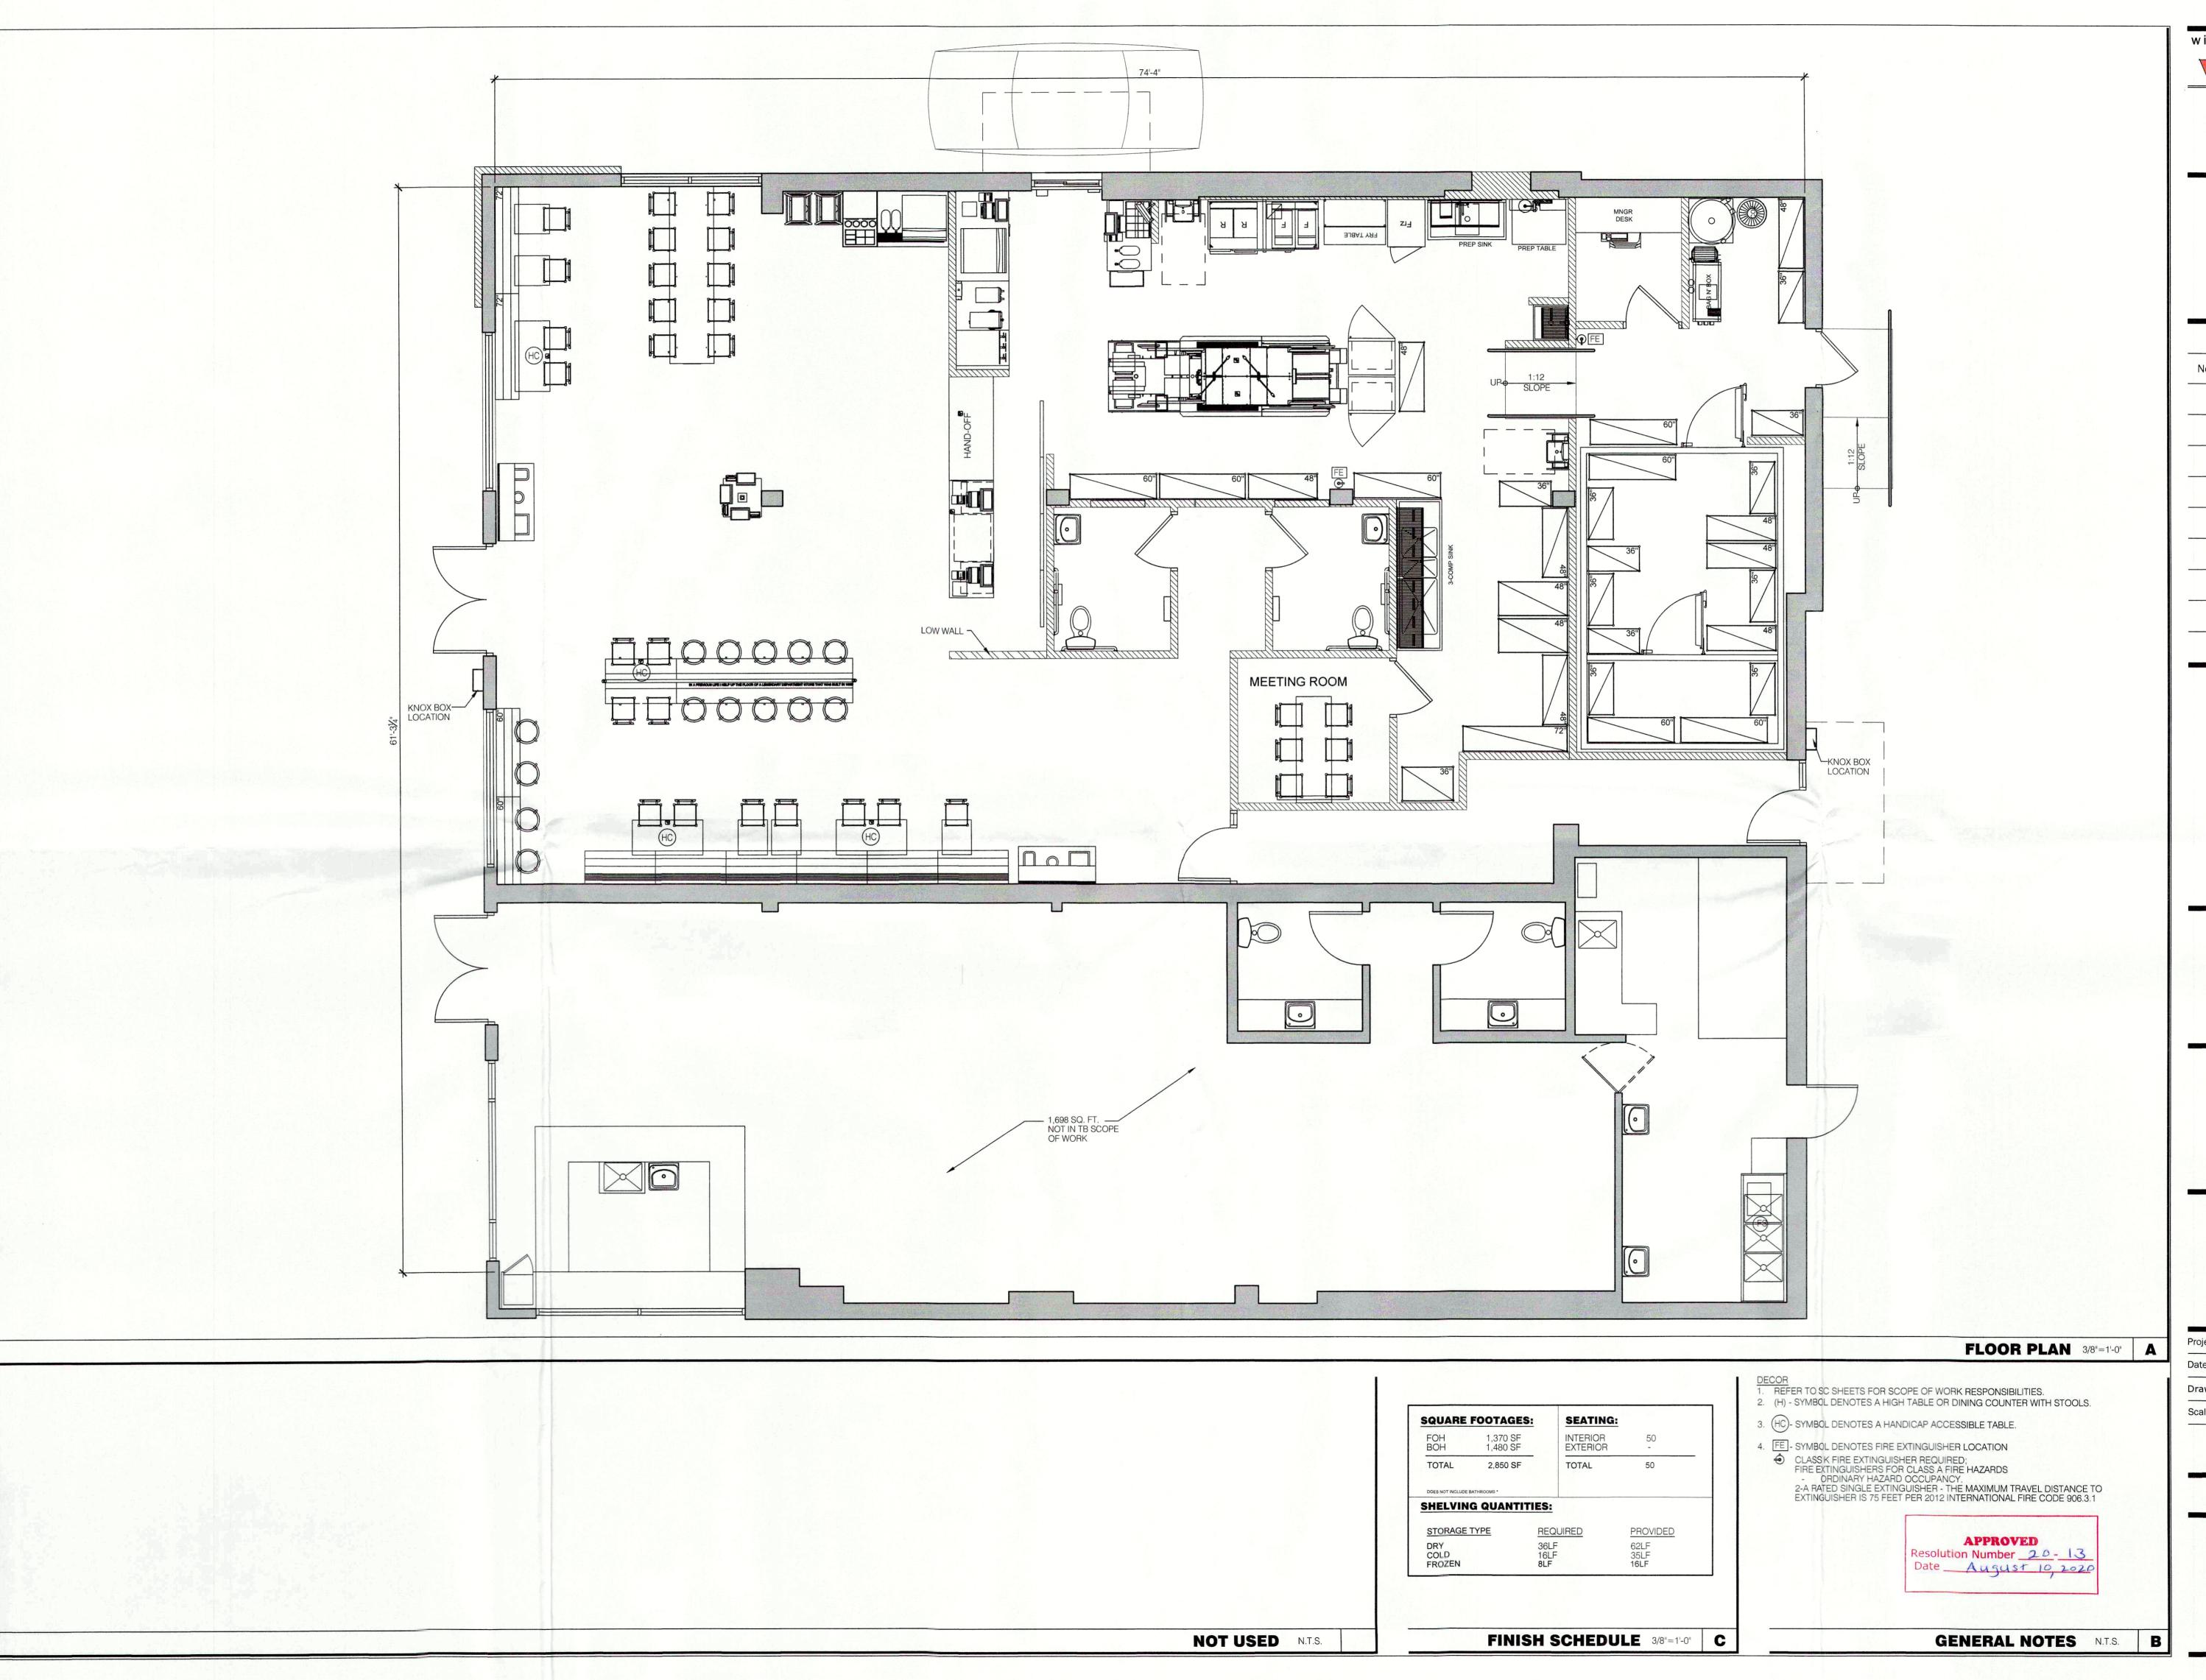

wiener architecture group, LLC

Josiah Wiener, RA

Architecture
Planning
Interior Design

telephone: 973 933 6636 fax: 646 607 8220 info@wag-architects.com 191 Central Avenue, Suite 228, Newark, New Jersey 07103

Architects

No. Description Date



Taco Bell 3605 Crompond Road Cortlandt, New York 10567

Modern Explorer

Floor Plan

Project No. W103-19


Date: 05/28/2020

Drawn By: SK

Scale: As Noted

NY License No. 029493

A2.0

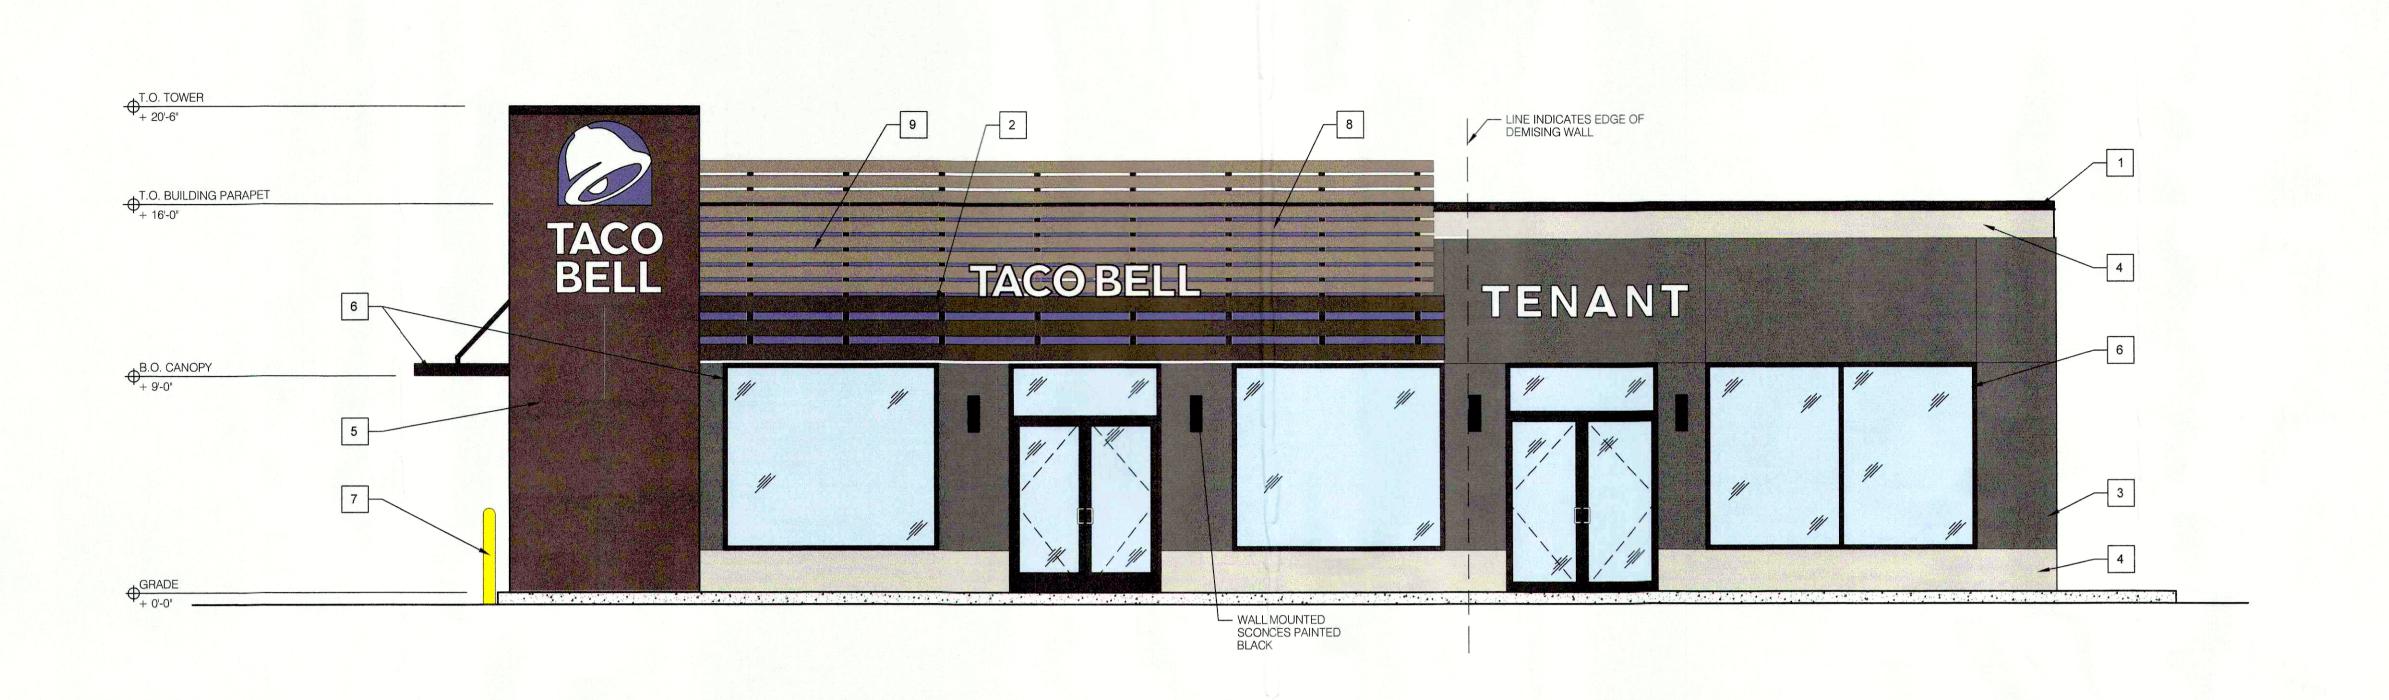



191 Central Avenue, Suite 228, Newark, New Jersey 07103

Resolution Number 20 - 13
Date 8 10 2020




Taco Bell 3605 Crompond Road Cortlandt, New York 10567

Modern Explorer

Exterior Elevations

Project No. W103-19	
Date: 05/28/2020	
Drawn By: SK	1
Scale: As Noted	
NY License No. 029493	

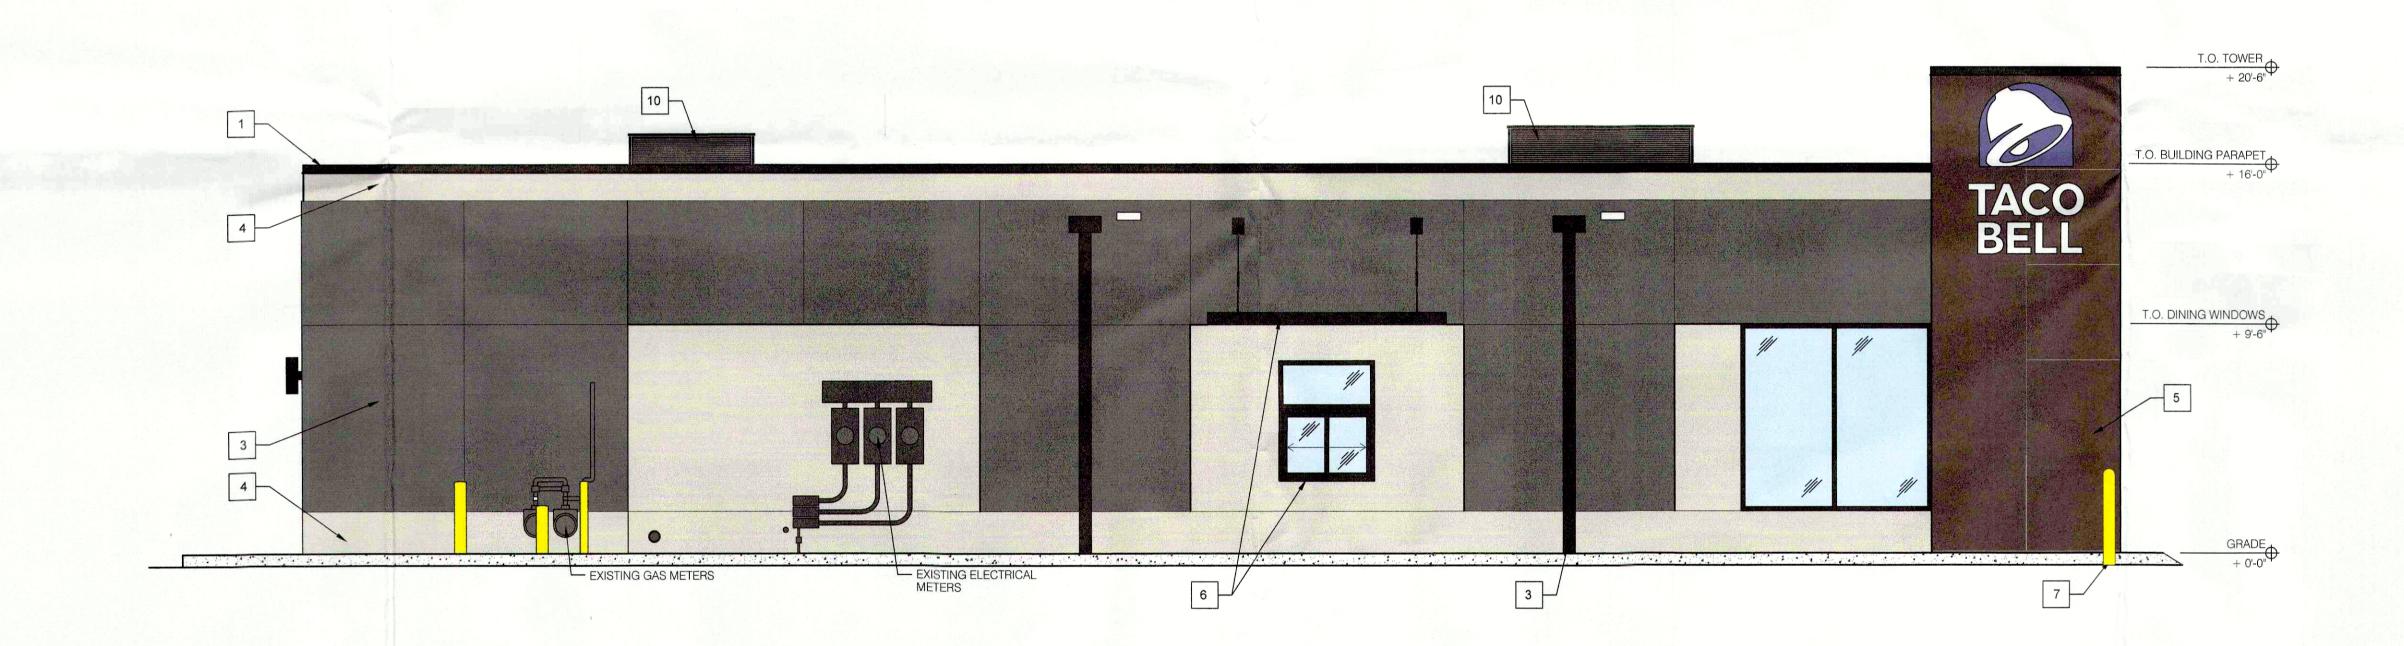

SYMBOL MANUFACTURER COLOR AREA PARAPET CAP SW 7069 "IRON ORE" SHERWIN WILLIAMS VALANCE SIGN VENDOR SW 7034 "STATUS BRONZE" (EQUAL) MAIN BUILDING COLOR, SCUPPER, COLLECTOR & VERTICAL DOWNSPOUT, DOORS SW 7069 "CITYSCAPE" SHERWIN WILLIAMS ACCENT COLOR / PARAPET WALLS SHERWIN WILLIAMS SW 6098 "PACER WHITE" WESTERN STATES METAL ROOFING WEATHERED RUSTIC **TOWER** STOREFRONT, WINDOW MULLIONS, AND CANOPIES POWDER COATING-DRYLAC-038/60080-STATUARY BRONZE 6" DIAMETER BOLLARDS OSHA YELLOW SLAT WALL GTC ALUMA BARN WOOD BEHIND SLAT WALL SHERWIN WILLIAMS SW 6831 "CLEMATIS" CITYSCAPES - ACRYLICAP LOUVER SW 7069 "IRON ORE" - TRIM TO MATCH HVAC SCREENING

FINISH SCHEDULE N.A.

MISCELLANEOUS

A. EXISTING STOREFRONT SYSTEM TO BE REMOVED AND REPLACED WITH NEW.

SEALERS (REFER TO SPECS):

A. SEALANT AT ALL WALL AND ROOF PENETRATIONS.

B. SEALANT AT ALL WINDOW AND DOOR FRAMES AT HEAD AND JAMB. DO NOT SEAL SILL @

PROPOSED EAST ELEVATION 3/8"=1'-0" B

PROPOSED NORTH ELEVATION 3/8"=1'-0" A


C. APPLY NEOPRENE GASKET (CONT.) BETWEEN BUILDING & CANOPY.

"CRITICAL" DIMENSIONS:

A. REQUIRED CLEAR OPENING WIDTH TO ENSURE COORDINATION WITH STANDARD SIGNAGE/ BUILDING ELEMENTS DIMENSIONS.

NOTE: NO EXTERIOR SIGNS ARE WITHIN THE SCOPE OF WORK COVERED BY THE BUILDING PERMIT APPLICATION. THE GENERAL CONTRACTOR SHALL BE RESPONSIBLE FOR COORDINATING THE INSTALLATION OF ALL EXTERIOR SIGNS AND INSTALLATION OF REQUIRED BLOCKING AND ELECTRICAL CONNECTIONS FOR FINAL APPROVED SIGNS. SIGN VENDOR SHALL VERIFY IN FIELD ALL DIMENSIONS AND METHODS OF INSTALLATION BEFORE MANUFACTURING.

GENERAL NOTES N.T.S. C

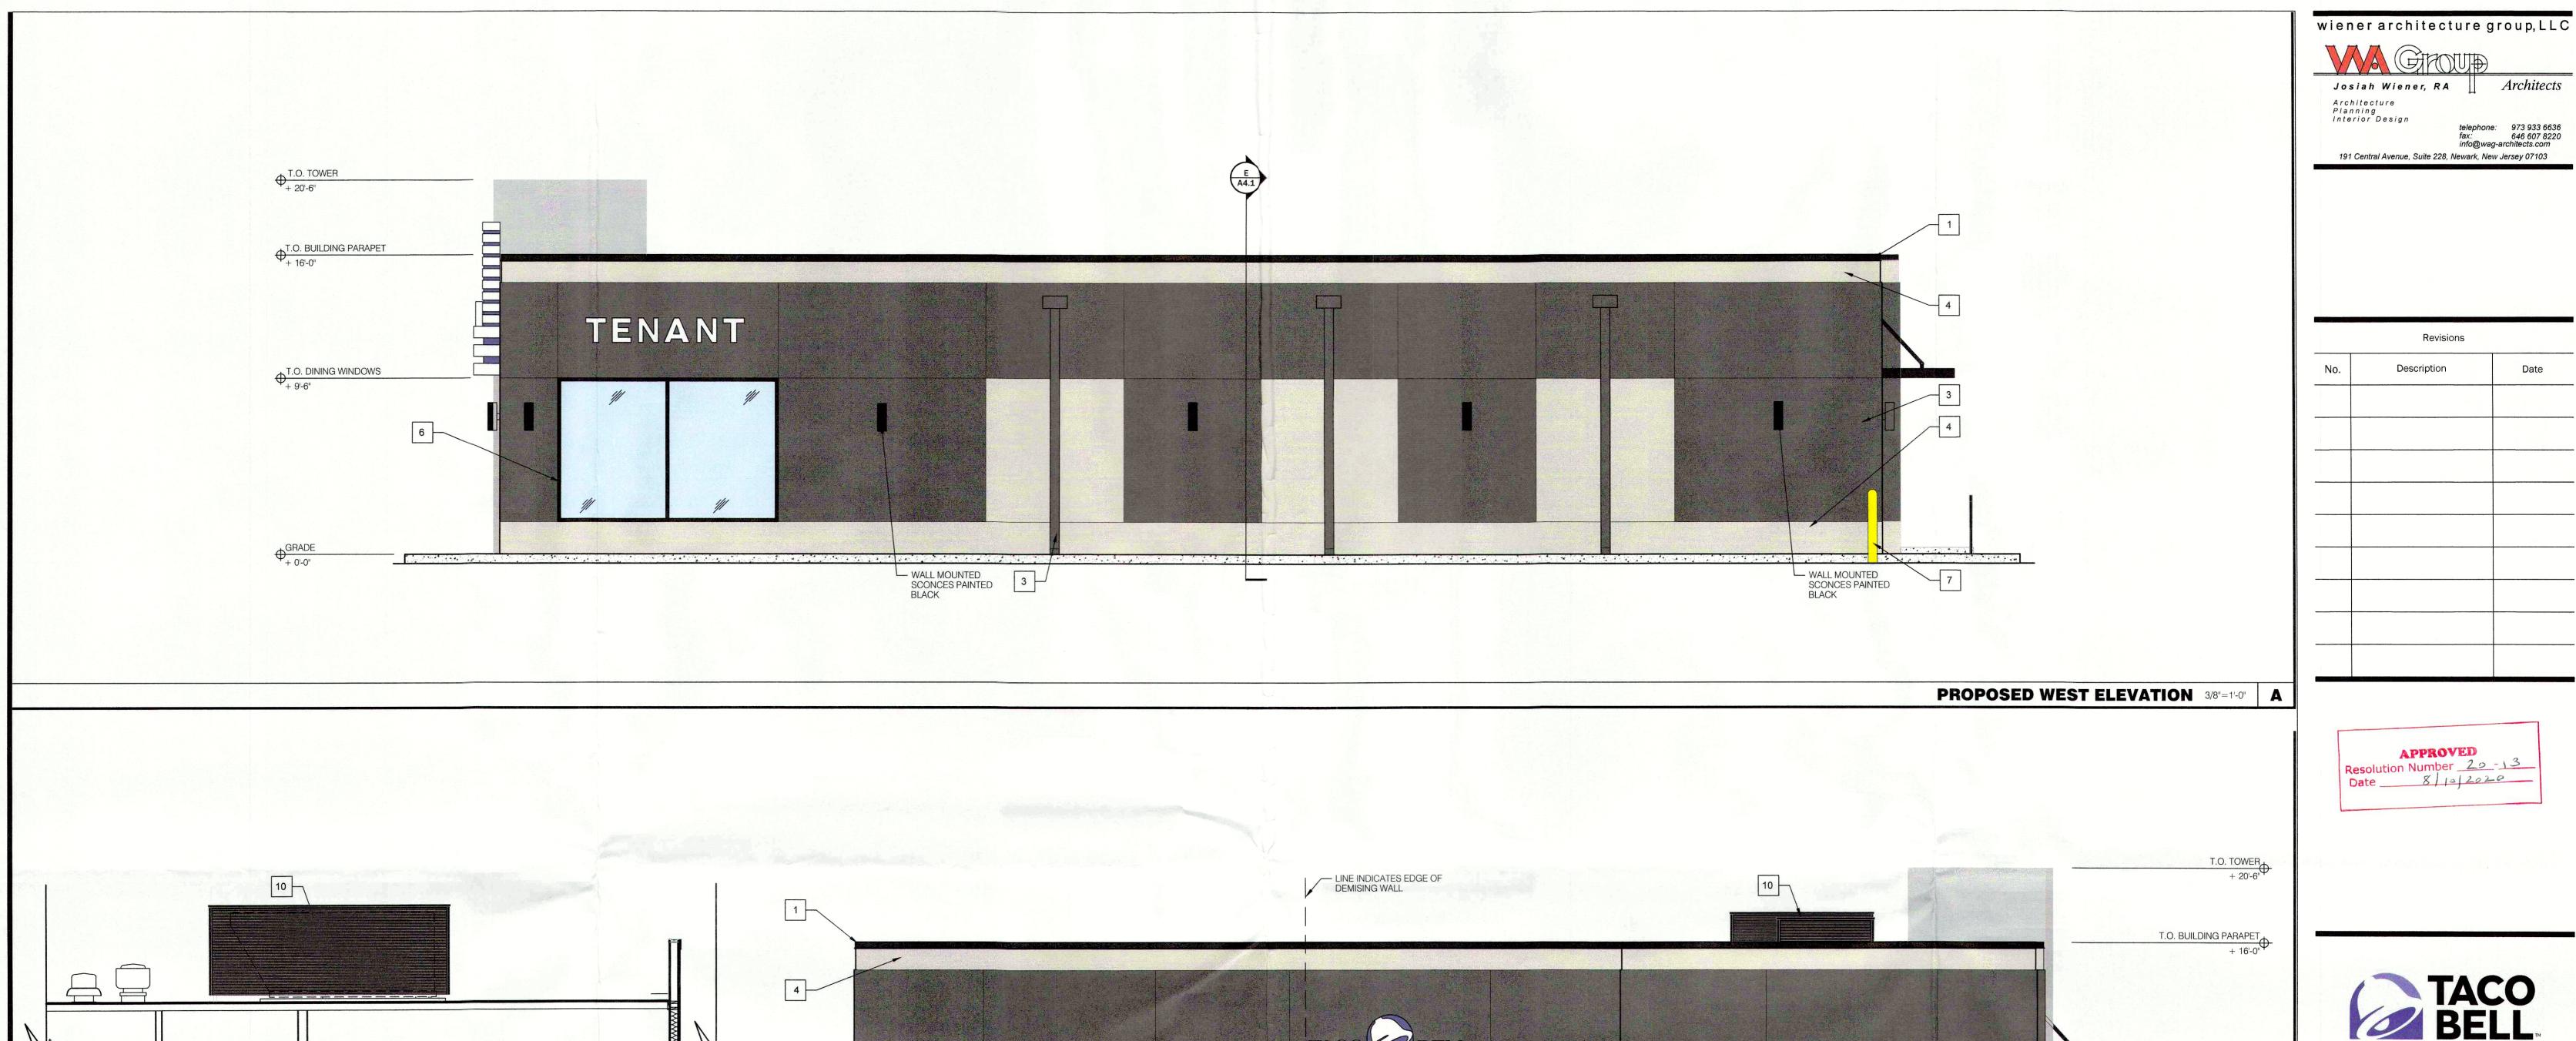

4

BUILDING SECTION 3/8"=1'-0" E



Taco Bell 3605 Crompond Road Cortlandt, New York 10567

B.O. CANOPY + 9'-0"

PROPOSED SOUTH ELEVATION 3/8"=1'-0" B

GENERAL NOTES N.T.S. C

1-1/2" SQUARE RAILINGS PAINTED BLACKFOR RAMP

Modern Explorer

Exterior Elevations

Project No. W103-19	
Date: 05/28/2020	
Drawn By: SK	
Scale: As Noted	
NY License No. 029493	

A4.1

				PROPOSED SOUTH ELEVATION 3/8"=1'-0" B
SYMBOL	AREA	MANUFACTURER	COLOR	
	PARAPET CAP	SHERWIN WILLIAMS	SW 7069 "IRON ORE"	MISCELLANEOUS
2	VALANCE	SIGN VENDOR	SW 7034 "STATUS BRONZE" (EQUAL)	A. EXISTING STOREFRONT SYSTEM TO BE REMOVED AND REPLACED WITH NEW.
3	MAIN BUILDING COLOR, SCUPPER, COLLECTOR & VERTICAL DOWNSPOUT, DOORS	SHERWIN WILLIAMS	SW 7069 "CITYSCAPE"	SEALERS (REFER TO SPECS): A. SEALANT AT ALL WALL AND ROOF PENETRATIONS.
4	ACCENT COLOR / PARAPET WALLS	SHERWIN WILLIAMS	SW 6098 "PACER WHITE"	B. SEALANT AT ALL WINDOW AND DOOR FRAMES AT HEAD AND JAMB. DO NOT SEAL SILL @ WINDOWS.
5	TOWER	WESTERN STATES METAL ROOFING	G WEATHERED RUSTIC	C. APPLY NEOPRENE GASKET (CONT.) BETWEEN BUILDING & CANOPY.
6	STOREFRONT, WINDOW MULLIONS, AND CANOPIES		POWDER COATING-DRYLAC-038/60080-STATUARY BRONZE	"CRITICAL" DIMENSIONS: A. REQUIRED CLEAR OPENING WIDTH TO ENSURE COORDINATION WITH STANDARD SIGNAGE/ BUILDING ELEMENTS DIMENSIONS.
7	6" DIAMETER BOLLARDS		OSHA YELLOW	SIGN TOLD THE ELEMENT OF SIME NOT ON.
8	SLAT WALL	GTC	ALUMA BARN WOOD	NOTE: NO EXTERIOR SIGNS ARE WITHIN THE SCOPE OF WORK COVERED BY THE BUILDING
9	BEHIND SLAT WALL	SHERWIN WILLIAMS	SW 6831 "CLEMATIS"	PERMIT APPLICATION. THE GENERAL CONTRACTOR SHALL BE RESPONSIBLE FOR COORDINATING THE INSTALLATION OF ALL EXTERIOR SIGNS AND INSTALLATION OF REQUIRED BY OCKING AND ELECTRICAL CONNECTIONS FOR FINAL APPROVED SIGNS.
10	HVAC SCREENING	CITYSCAPES - ACRYLICAP LOUVER	SW 7069 "IRON ORE" - TRIM TO MATCH	REQUIRED BLOCKING AND ELECTRICAL CONNECTIONS FOR FINAL APPROVED SIGNS. SIGN VENDOR SHALL VERIFY IN FIELD ALL DIMENSIONS AND METHODS OF INSTALLATION BEFORE MANUFACTURING.

WALL MOUNTED SCONCES PAINTED BLACK

FINISH SCHEDULE N.A.

D