


SCALE:  $1" = 2,000'\pm$ 

Zone: C-4 Total Acreage 0.49 AC Tax Map No.: 16.07-1-43

- with the utility provider specifications including but not limited to provided the proper bedding, cover, and detectible warning tape / tracer wire. The
- nearest available cross section data as shown on the FEMA Mapping and was determined to be elevation 422.2.
- survey field work being completed. These previous pump islands and fuel tanks are shown hereon based on the previous survey field work completed.
- to the new building being connected to the proposed building.

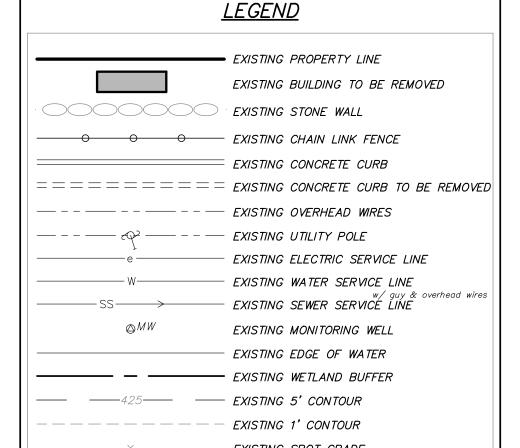


REVISED PER TOWN COMMENTS RESUBMISSION TO TOWN


3 Garrett Place

Carmel, NY 10512 (845) 225–9690 (845) 225–9717 fax

www.insite-eng.com

DRAWING NO. s. v. w. EX-1

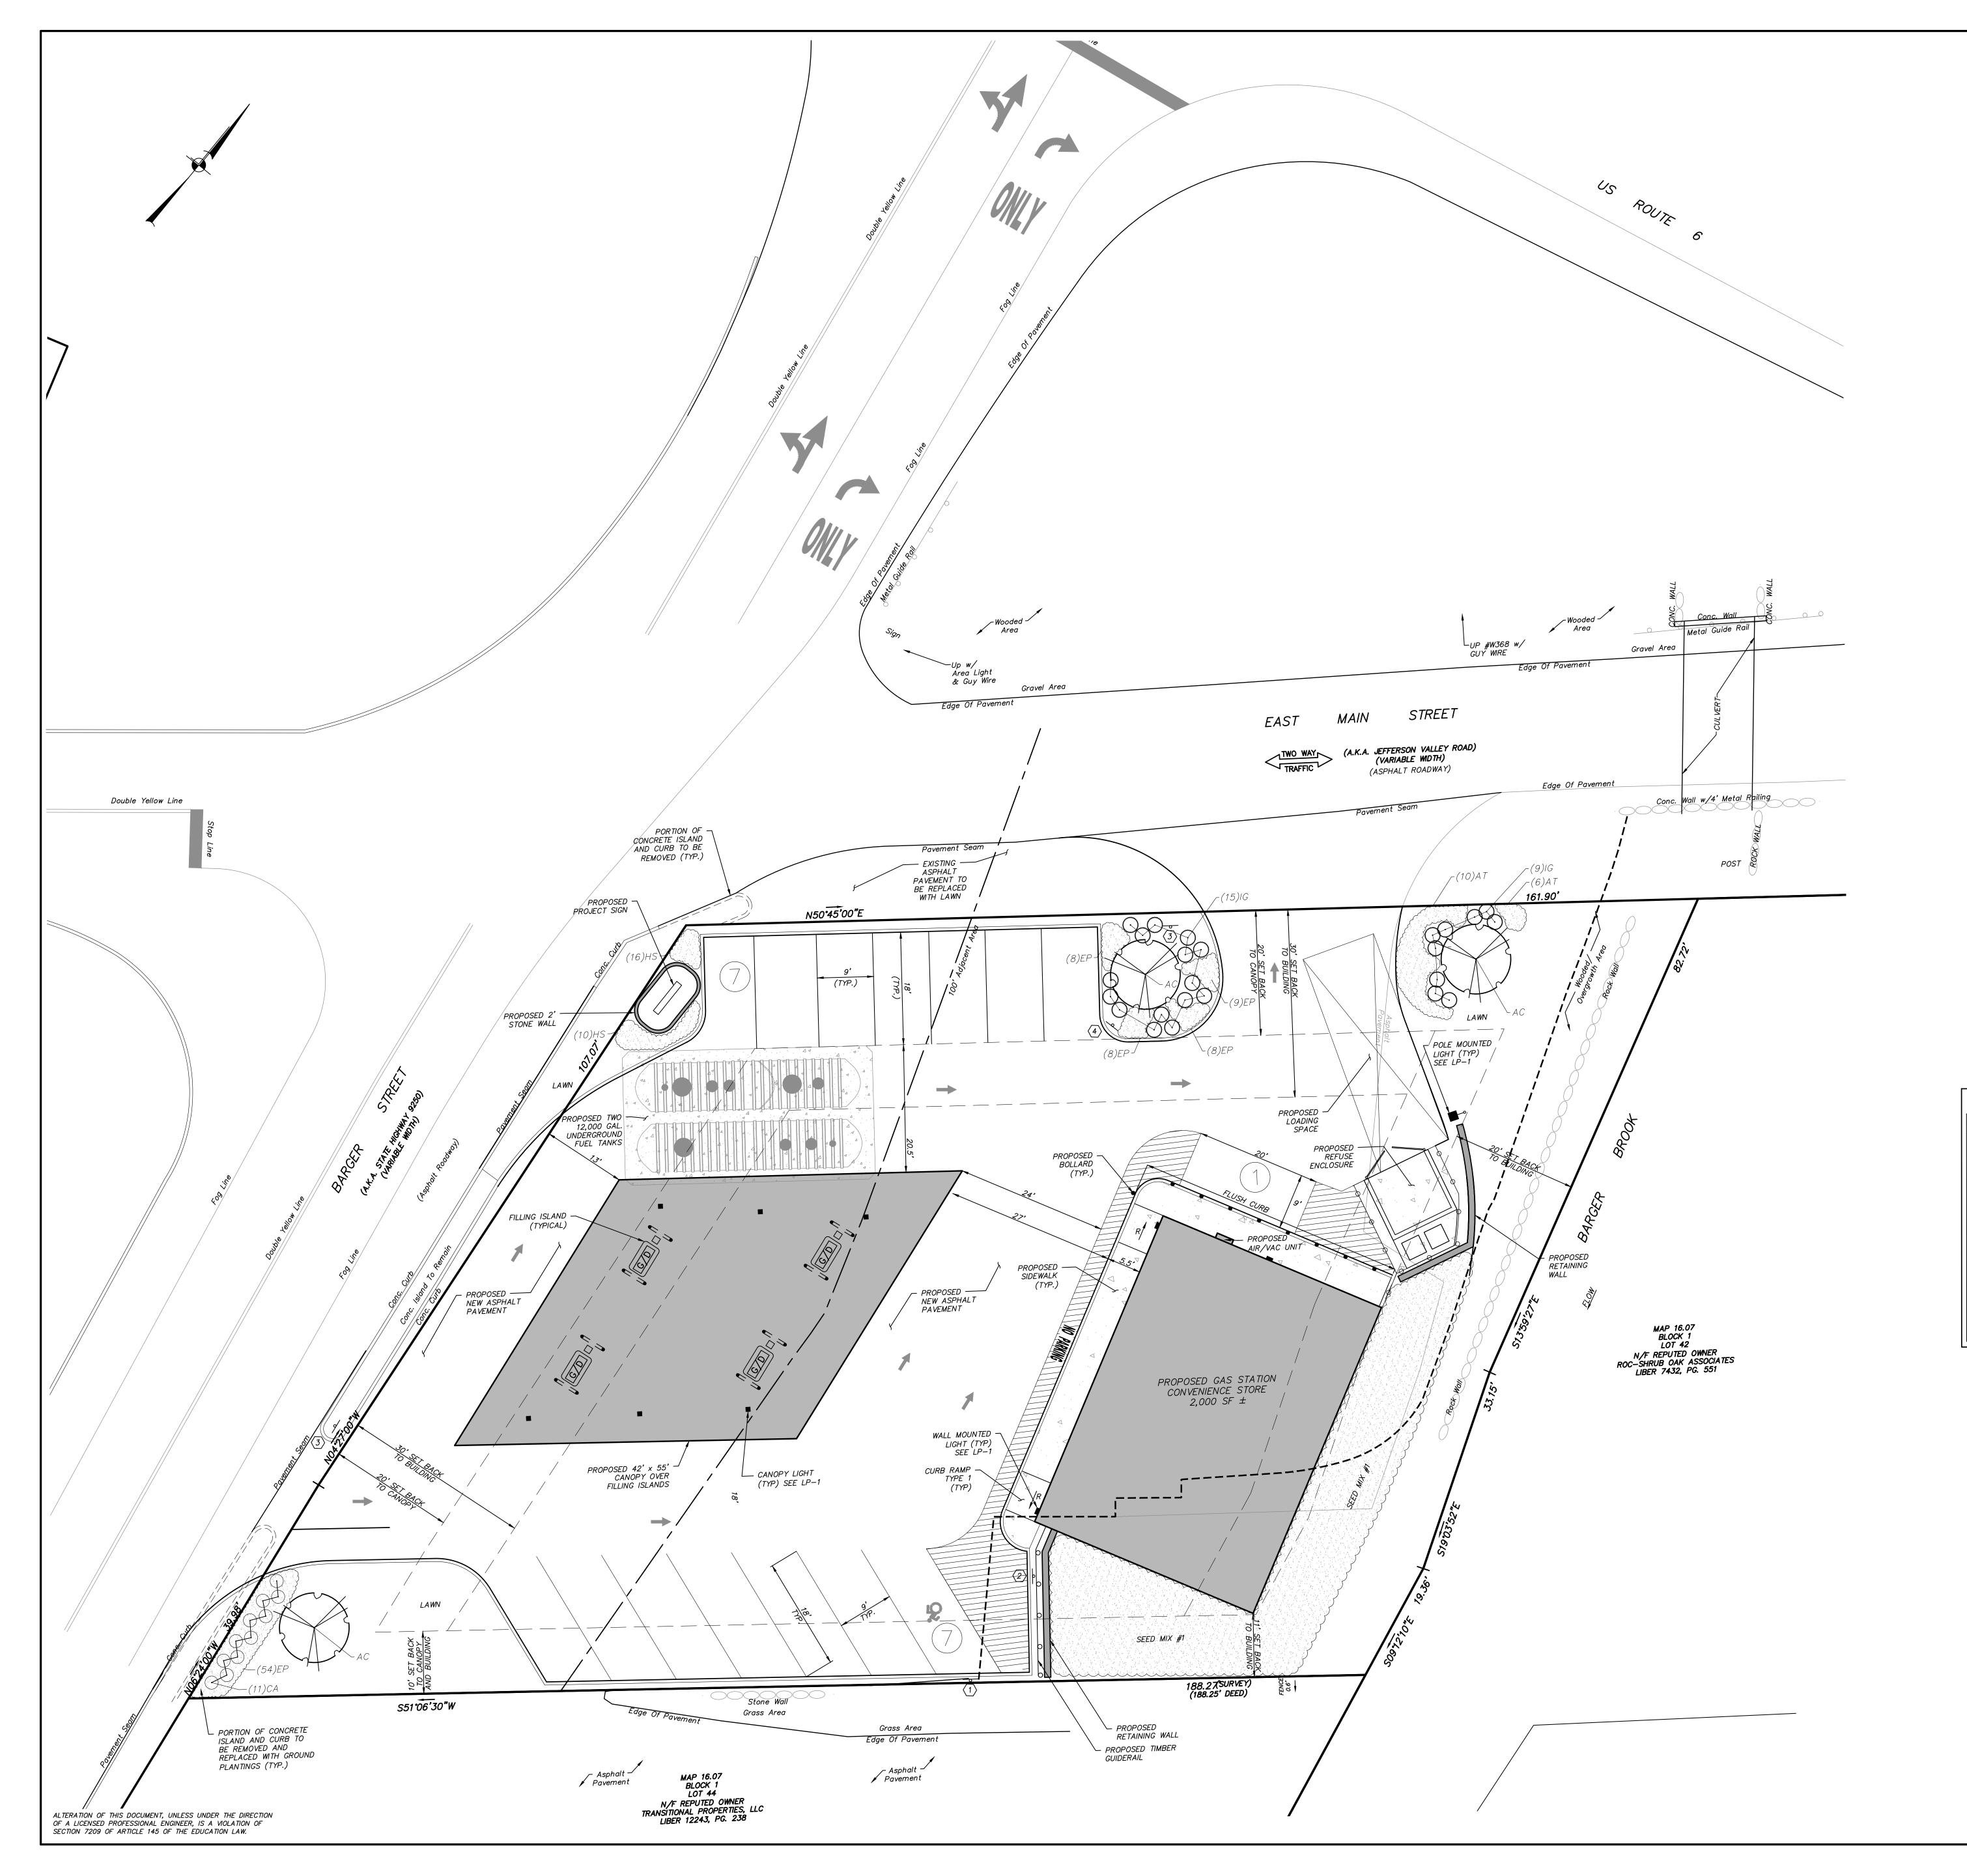

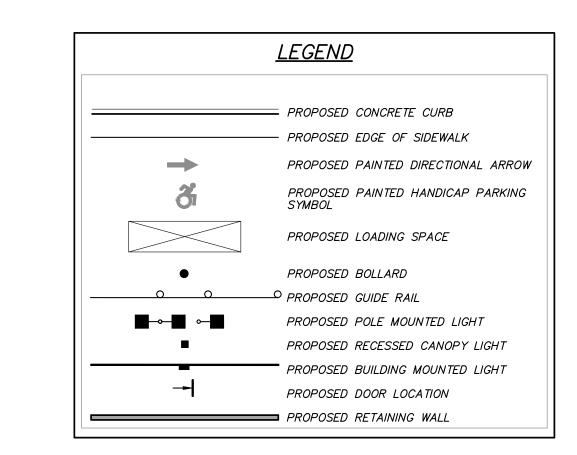

<u>SIGN DATA TABLE</u>						
NO.	TEXT	M.U.T.C.D. NUMBER	SIZE OF SIGN	DESCRIPTION		
1	RESERVED PARKING	NY R7-8*	12" x 18"	Green on White Blue Symbol		
	VAN	R7-8P	12" x 6"	Green on White		
2	NO PARKING ANY TIME	R7-1	12" x 18"	Red on White		
3	DO NOT ENTER	R5–1C	30" x 30"	White on Red		
4	ONE WAY	R3–1C	12" x 36" (3.0 s.f.)	Black Background White Arrow Black Letters		

	<u>YORKTO</u>	WN C-4 ZONING REQU	<u> UIREMENTS:</u>	
		Required/Permitted:	<u>Existing:</u>	<u>Proposed:</u>
Lot Area (sq	. ft.):	20,000 SF	21,344 SF±	21,344 SF±
Lot Width at	Front Line of Main Building:	25'	122'±	122'±
Lot Depth:		100'	171'±	171'±
Frontage:		100'	309'±	309'±
Front Yard:	Main Building:	30'	<i>37'±</i>	48'±
	Accessory Building:	20'	50 <b>'</b> ±	13'±*
Side Yard:	Main Building:	10'	26 <b>'</b> ±	10'±
	Accessory Building:	10'	0	40'±
Rear Yard:	Main Building:	30'	39 <b>'</b> ±	20'±*
	Accessory Building:	30'	79 <b>'</b> ±	90'±
Maximum	Main Building:	35'	_	<35'
Height:	Accessory Building:	20'	_	<20'
Maximum Co	verage (All Buildings):	30%	16% ±	20% ±
Required Off-	-Street Loading Berths	1	0	1

\*Town Board Modification Requested

I ARRING RE	<u>QUIREMENTS:</u>	
	<u>Required:</u>	<u>Provided:</u>
Gasoline Filling Station: 5 Spaces/1000 SF x 2,000 SF	10 Spaces	14
1 Parking Space Per 2 Employees	1	1
Total:	11	15
LOADING RE	QUIREMENTS:	
	<u>Required:</u>	<u>Provided:</u>
Retail/ Service Businesses		
1 For the First 4,000 SF x 2,000 SF	1 Loading Space	1


			<u>PLANT LIST</u>		
	QTY.	SYMBOL	BOTANICAL/COMMON NAME	SIZE	ROOT
$\bigcirc$	3	AC	FLOWERING/SPECIMEN TREES Amelanchier canadensis / Shadblow Serviceberry	10' HT.	B & B
⊙ ⊙	11 24	CA IG	SHRUBS  Cornus alba 'Bailhalo' / Ivory Halo Tatarian dogwood  Ilex glabra / Inkberry Holly	24"-30" HT 12" - 18" HT.	#5 CONT #3 CONT
	16 87 26	AT EP HS	PERENNIALS/GRASSES/GROUNDCOVERS  Asclepias tuberosa / Butterfly Weed Echinacea purpurea/ Purple Coneflower Hemerocalus "Stella De Oro" / Stella de Oro Daylily  SEED MIX #1  Native Upland Wildlife Forage & Cover Meadow Mix (ERNMX-123) by Ernst Conservation Seeds of Meadville, PA.	#1 CONT. #1 CONT. #1 CONT.	36" O.C. 18" O.C. 24" O.C. 20lbs/ac

	2	9-3-20		REVISED P	ER TOWN COMN	<i>IENTS</i>	E.R.A.
	1	12-16-19		RESUBI	NISSION TO TO	WN	G.A.M.
	NO.	DATE			REVISION		BY
			NGINEE	S   ERING, SURV PE ARCHITEC	EYING &	3 Garrett Place Carmel, NY 105 (845) 225–9690 (845) 225–9717 www.insite–eng.o	0 7 fax
E	DRA	<u>NY F</u> BARGER STREE WING:	T, TOWN OF	STRIBUTOR YORKTOWN, WESTCH ANDSCAPE	ESTER COUNTY	OF NEW OF	OPH * HONO
20	PROJE	- 1011	95.100	PROJECT MANAGER	R.D.W.	DRAWING NO.	SHEET /

GRAPHIC SCALE

( IN FEET ) 1 inch = 10 ft. NUMBER 19193.100 | MANAGER

DRAWN BY CHECKED BY s. v. w. SP-1 10-8-19 SCALE 1" = 10'

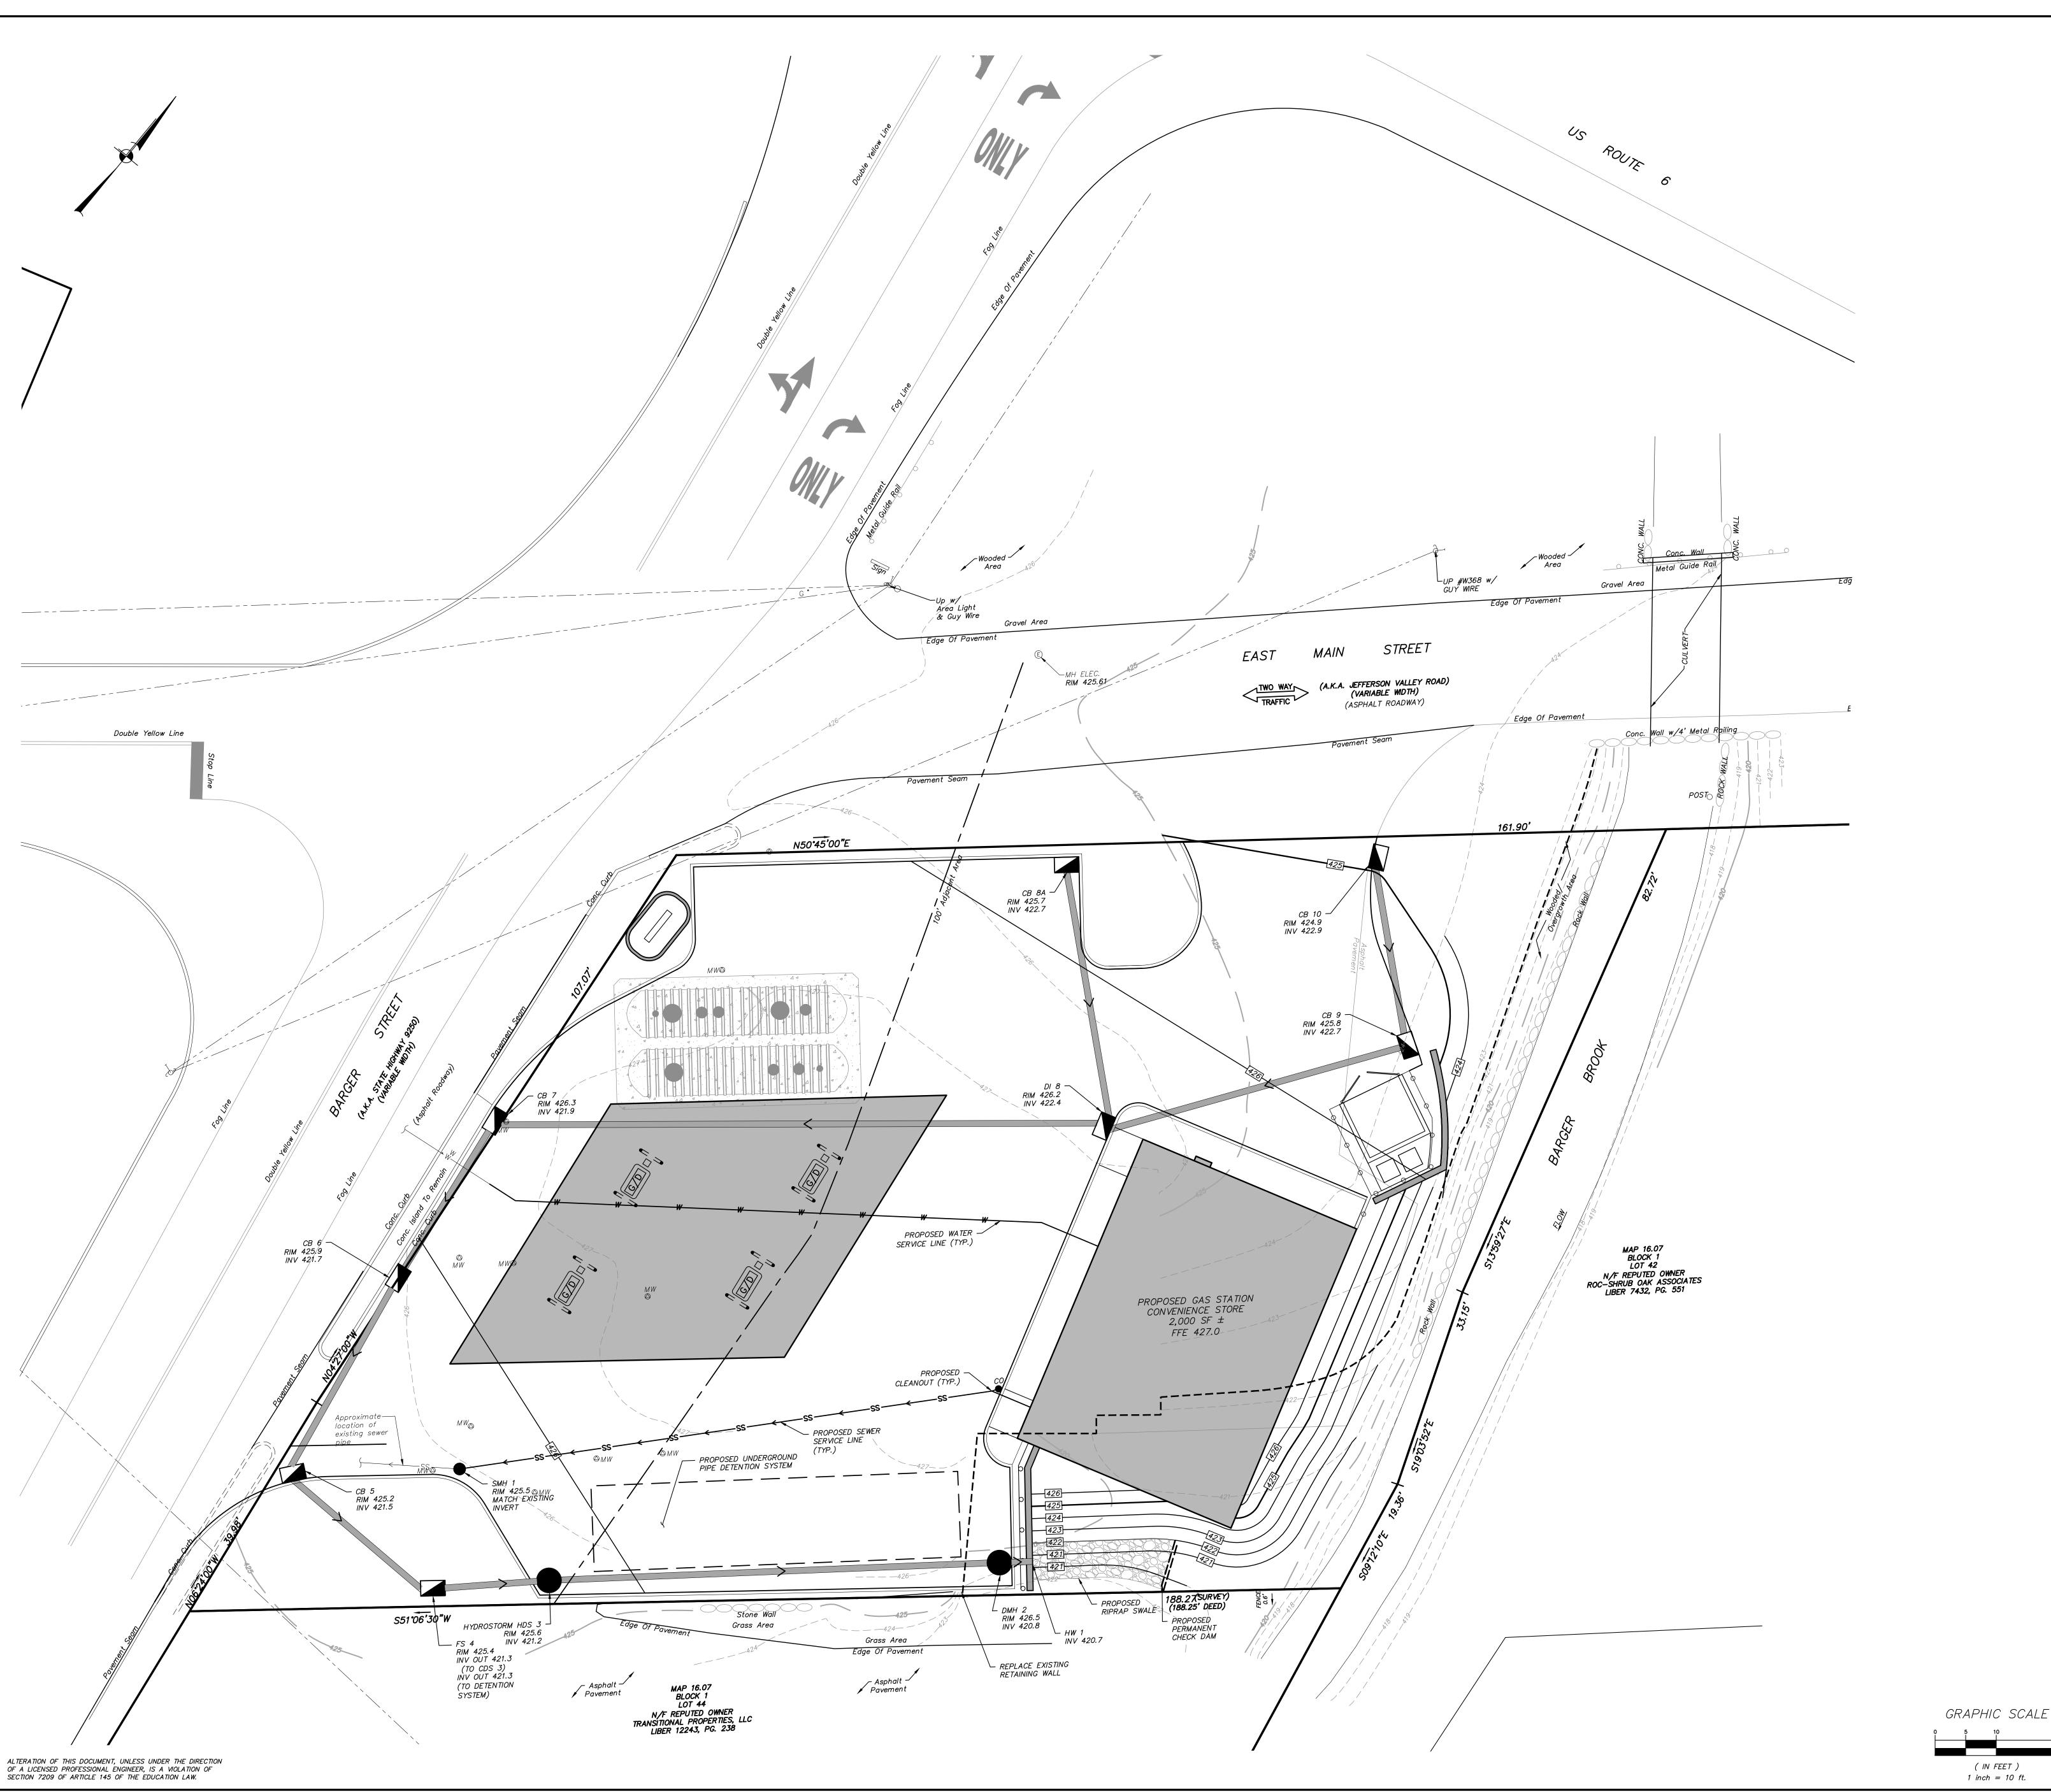

<u>LEGEND</u> 425 PROPOSED 5' CONTOUR PROPOSED SPOT ELEVATION TC 101.0 ×BC 100.5 PROPOSED TOP OF CURB & BOTTOM OF CURB ELEVATIONS TW 105.0 ×BW 100.0 PROPOSED TOP OF WALL & BOTTOM OF WALL ELEVATIONS PROPOSED SEWER MANHOLE PROPOSED DRAINAGE MANHOLE PROPOSED CATCH BASIN PROPOSED OUTLET STRUCTURE PROPOSED END SECTION PROPOSED WATER GATE VALVE PROPOSED WATER VALVE PROPOSED DRAINAGE PIPE → PROPOSED SEWER SERVICE LINE → PROPOSED SEWER SERVICE LINE PROPOSED RETAINING WALL


2 9-3-20 REVISED PER TOWN COMMENTS 1 | 12-16-19 | RESUBMISSION TO TOWN NO. DATE REVISION 3 Garrett Place Carmel, NY 10512 (845) 225–9690 (845) 225–9717 fax ENGINEERING, SURVEYING & LANDSCAPE ARCHITECTURE, P.C. www.insite-eng.com


NY FUEL DISTRIBUTORS

3700 BARGER STREET, TOWN OF YORKTOWN, WESTCHESTER COUNTY <u>GRADING & UTILITIES PLAN</u>

				PROFESS
PROJECT NUMBER	19195.100	PROJECT MANAGER	R.D.W.	DRAWING NO.
DATE	10-8-19	DRAWN BY	S. V. W.	SP-2
SCALE	1" = 10'	CHECKED BY	R.D.W.	

( IN FEET ) 1 inch = 10 ft.

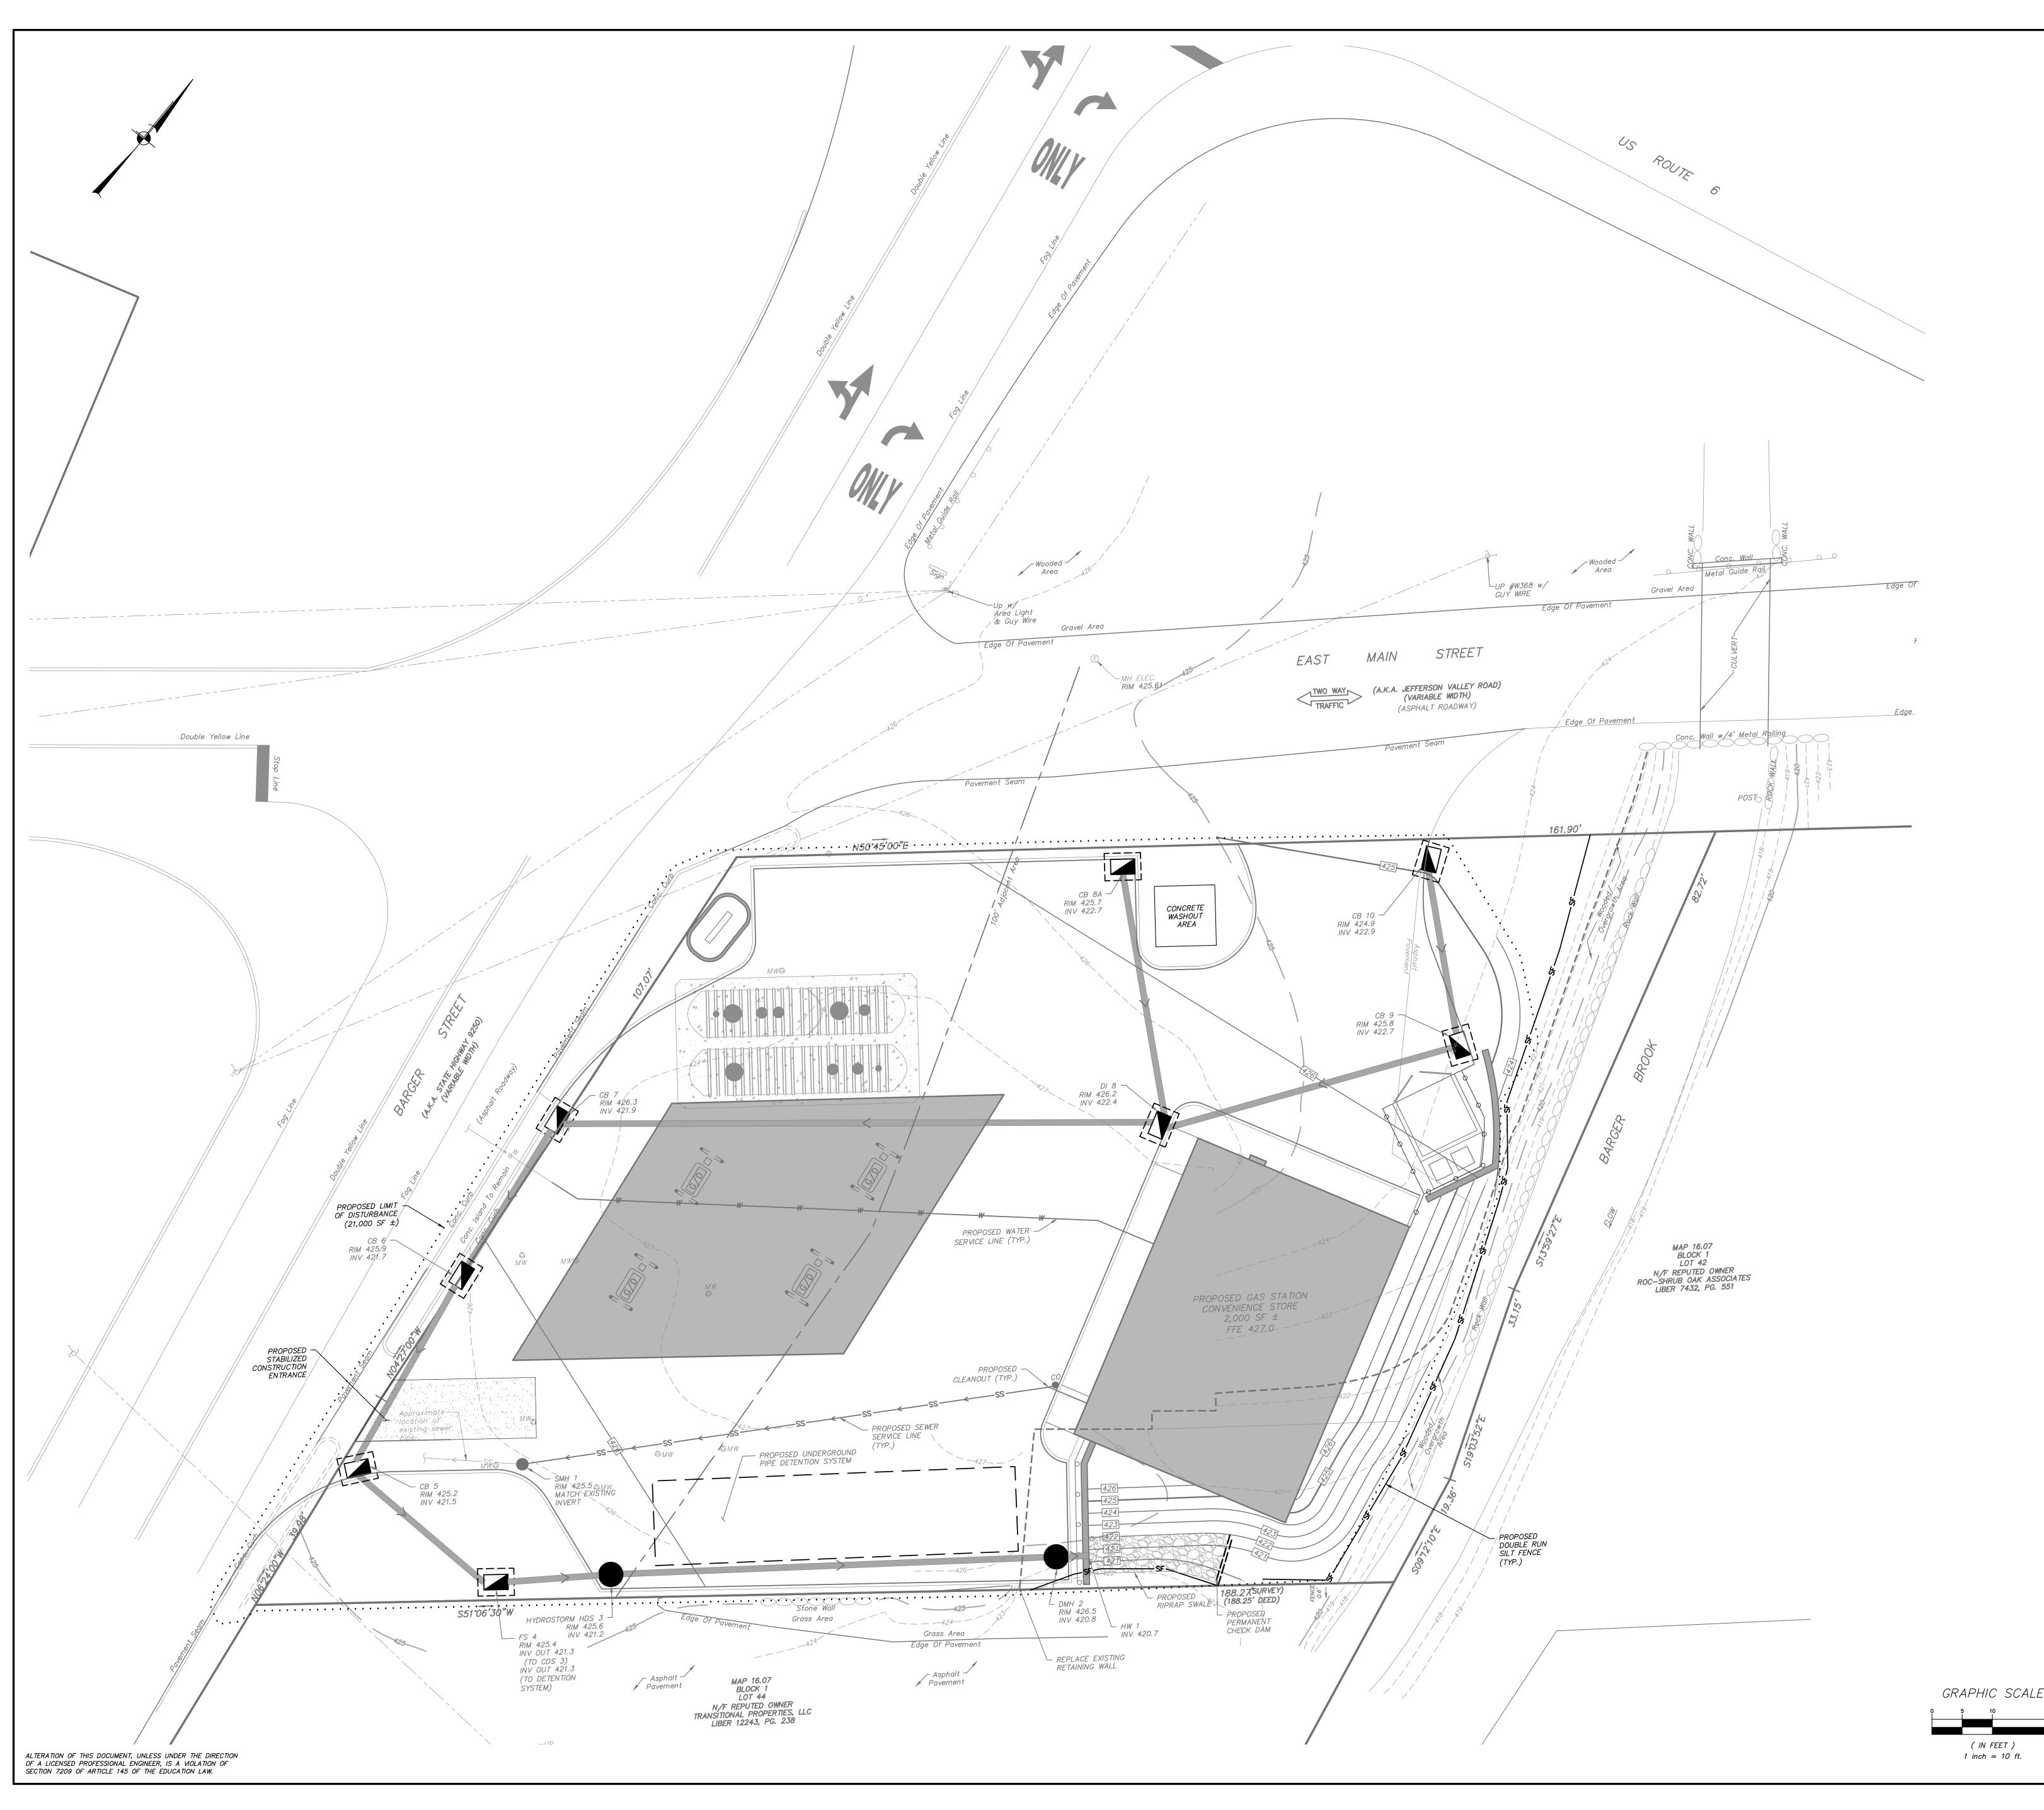

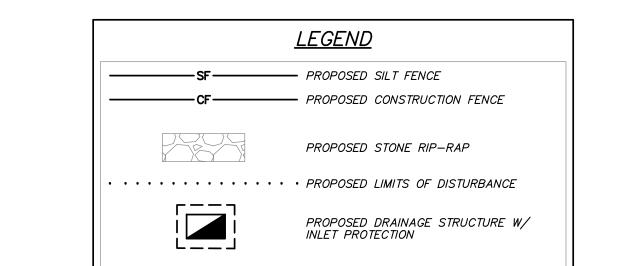

## EROSION & SEDIMENT CONTROL NOTES:


- 1. The owner's field representative (O.F.R.) will be responsible for the implementation and maintenance of erosion and sediment control measures on this site prior to and during construction.
- 2. All construction activities involving the removal or disposition of soil are to be provided with appropriate protective measures to minimize erosion and contain sediment disposition within. Minimum soil erosion and sediment control measures shall be implemented as shown on the plans and shall be installed in accordance with "New York Standards and Specifications For Erosion and Sediment Control,"
- 3. Wherever feasible, natural vegetation should be retained and protected. Disturbance shall be minimized in the areas required to perform construction. No more than 5 acres of unprotected soil shall be exposed at any one time.
- 4. When land is exposed during development, the exposure shall be kept to the shortest practical period of time. In the areas where soil disturbance activity has temporarily or permanently ceased, the application of soil stabilization measures must be initiated by the end of the next business day and completed within fourteen (14) days from the date the current soil disturbance activity ceased. Disturbance shall be minimized to the areas required to perform construction.
- 5. Silt fence shall be installed as shown on the plans prior to beginning any clearing, grubbing or earthwork.
- 6. All topsoil to be stripped from the area being developed shall be stockpiled and immediately seeded for temporary stabilization. Ryegrass (annual or perennial) at a rate of 30 lbs. per acre shall be used for temporary seeding in spring, summer or early fall. 'Aristook' Winter Rye (cereal rye) shall be used for temporary seeding in late fall and winter.
- 7. Any disturbed areas not subject to further disturbance or construction traffic, permanent or temporary, shall have soil stabilization measures initiated for permanent vegetation cover in combination with a suitable mulch within 1 business day of final grading. All seeded areas to receive a minimum 4" topsoil (from stockpile area) and be seeded and mulched as follows:
- Seed mixture to be planted between March 21 and May 20, or between August 15 and October 15 or as directed by project representative at a rate of 100 pounds per acre in the following proportions: Kentucky Bluegrass 20% Creeping Red Fescue 40%
- Annual Ryegrass 20% • Mulch: Salt hay or small grain straw applied at a rate of 90 lbs./1000 S.F. or 2 tons/acre, to be applied and anchored according to "New York Standards and Specification For Erosion and Sediment Control," latest
- Seeding shall be performed in accordance with the current edition of the "NYSDOT Standard Specification, Construction and Materials, Section 610-3.02, Method No. 1". Hydroseeding shall be performed using materials and methods as approved by the site engineer.

10. Grass seed mix may be applied by either mechanical or hydroseeding methods.

- 11. Cut or fill slopes steeper than 2:1 shall be stabilized immediately after grading with Curlex I Single Net Erosion Control Blanket, or approved equal.
- 12. Paved roadways shall be kept clean at all times.

Perennial Ryegrass 20%

- 13. The site shall at all times be graded and maintained such that all stormwater runoff is diverted to soil erosion and sediment control facilities.
- 14. All storm drainage outlets shall be stabilized, as required, before the discharge points become operational.
- 15. Stormwater from disturbed areas must be passed through erosion control barriers before discharge beyond disturbed areas or discharged into other drainage
- 16. Erosion and sediment control measures shall be inspected and maintained on a daily basis by the O.F.R. to insure that channels, temporary and permanent ditches and pipes are clear of debris, that embankments and berms have not been breached and that all straw bales and silt fences are intact. Any failure of erosion and sediment control measures shall be immediately repaired by the contractor and inspected for approval by the O.F.R. and/or site engineer.
- 17. Dust shall be controlled by sprinkling or other approved methods as necessary, or as directed by the O.F.R.
- 18. Cut and fills shall not endanger adjoining property, nor divert water onto the property of others.
- 19. All fills shall be placed and compacted in 6" lifts to provide stability of material and to prevent settlement.
- 20. The O.F.R. shall inspect downstream conditions for evidence of sedimentation on a weekly basis and after rainstorms.
- 21. As warranted by field conditions, special additional erosion and sediment control measures, as specified by the site engineer and/or the Town Engineer shall be installed by the contractor.
- 22. Erosion and sediment control measures shall remain in place until all disturbed areas are suitably stabilized.

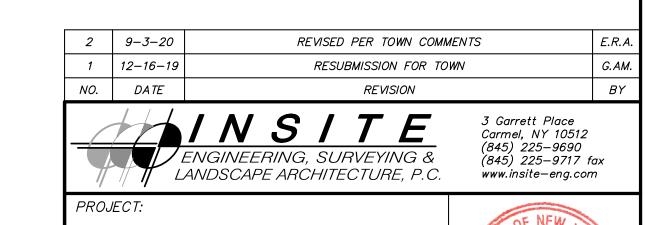


NY FUEL DISTRIBUTORS 3700 BARGER STREET, TOWN OF YORKTOWN, WESTCHESTER COUNTY

EROSION CONTROL PLAN

DRAWING NO. 19195.100 R.D.W. MANAGER s. v. w. SP-J 10-8-19

NUMBER CHECKED 1" = 10'R.D.W.

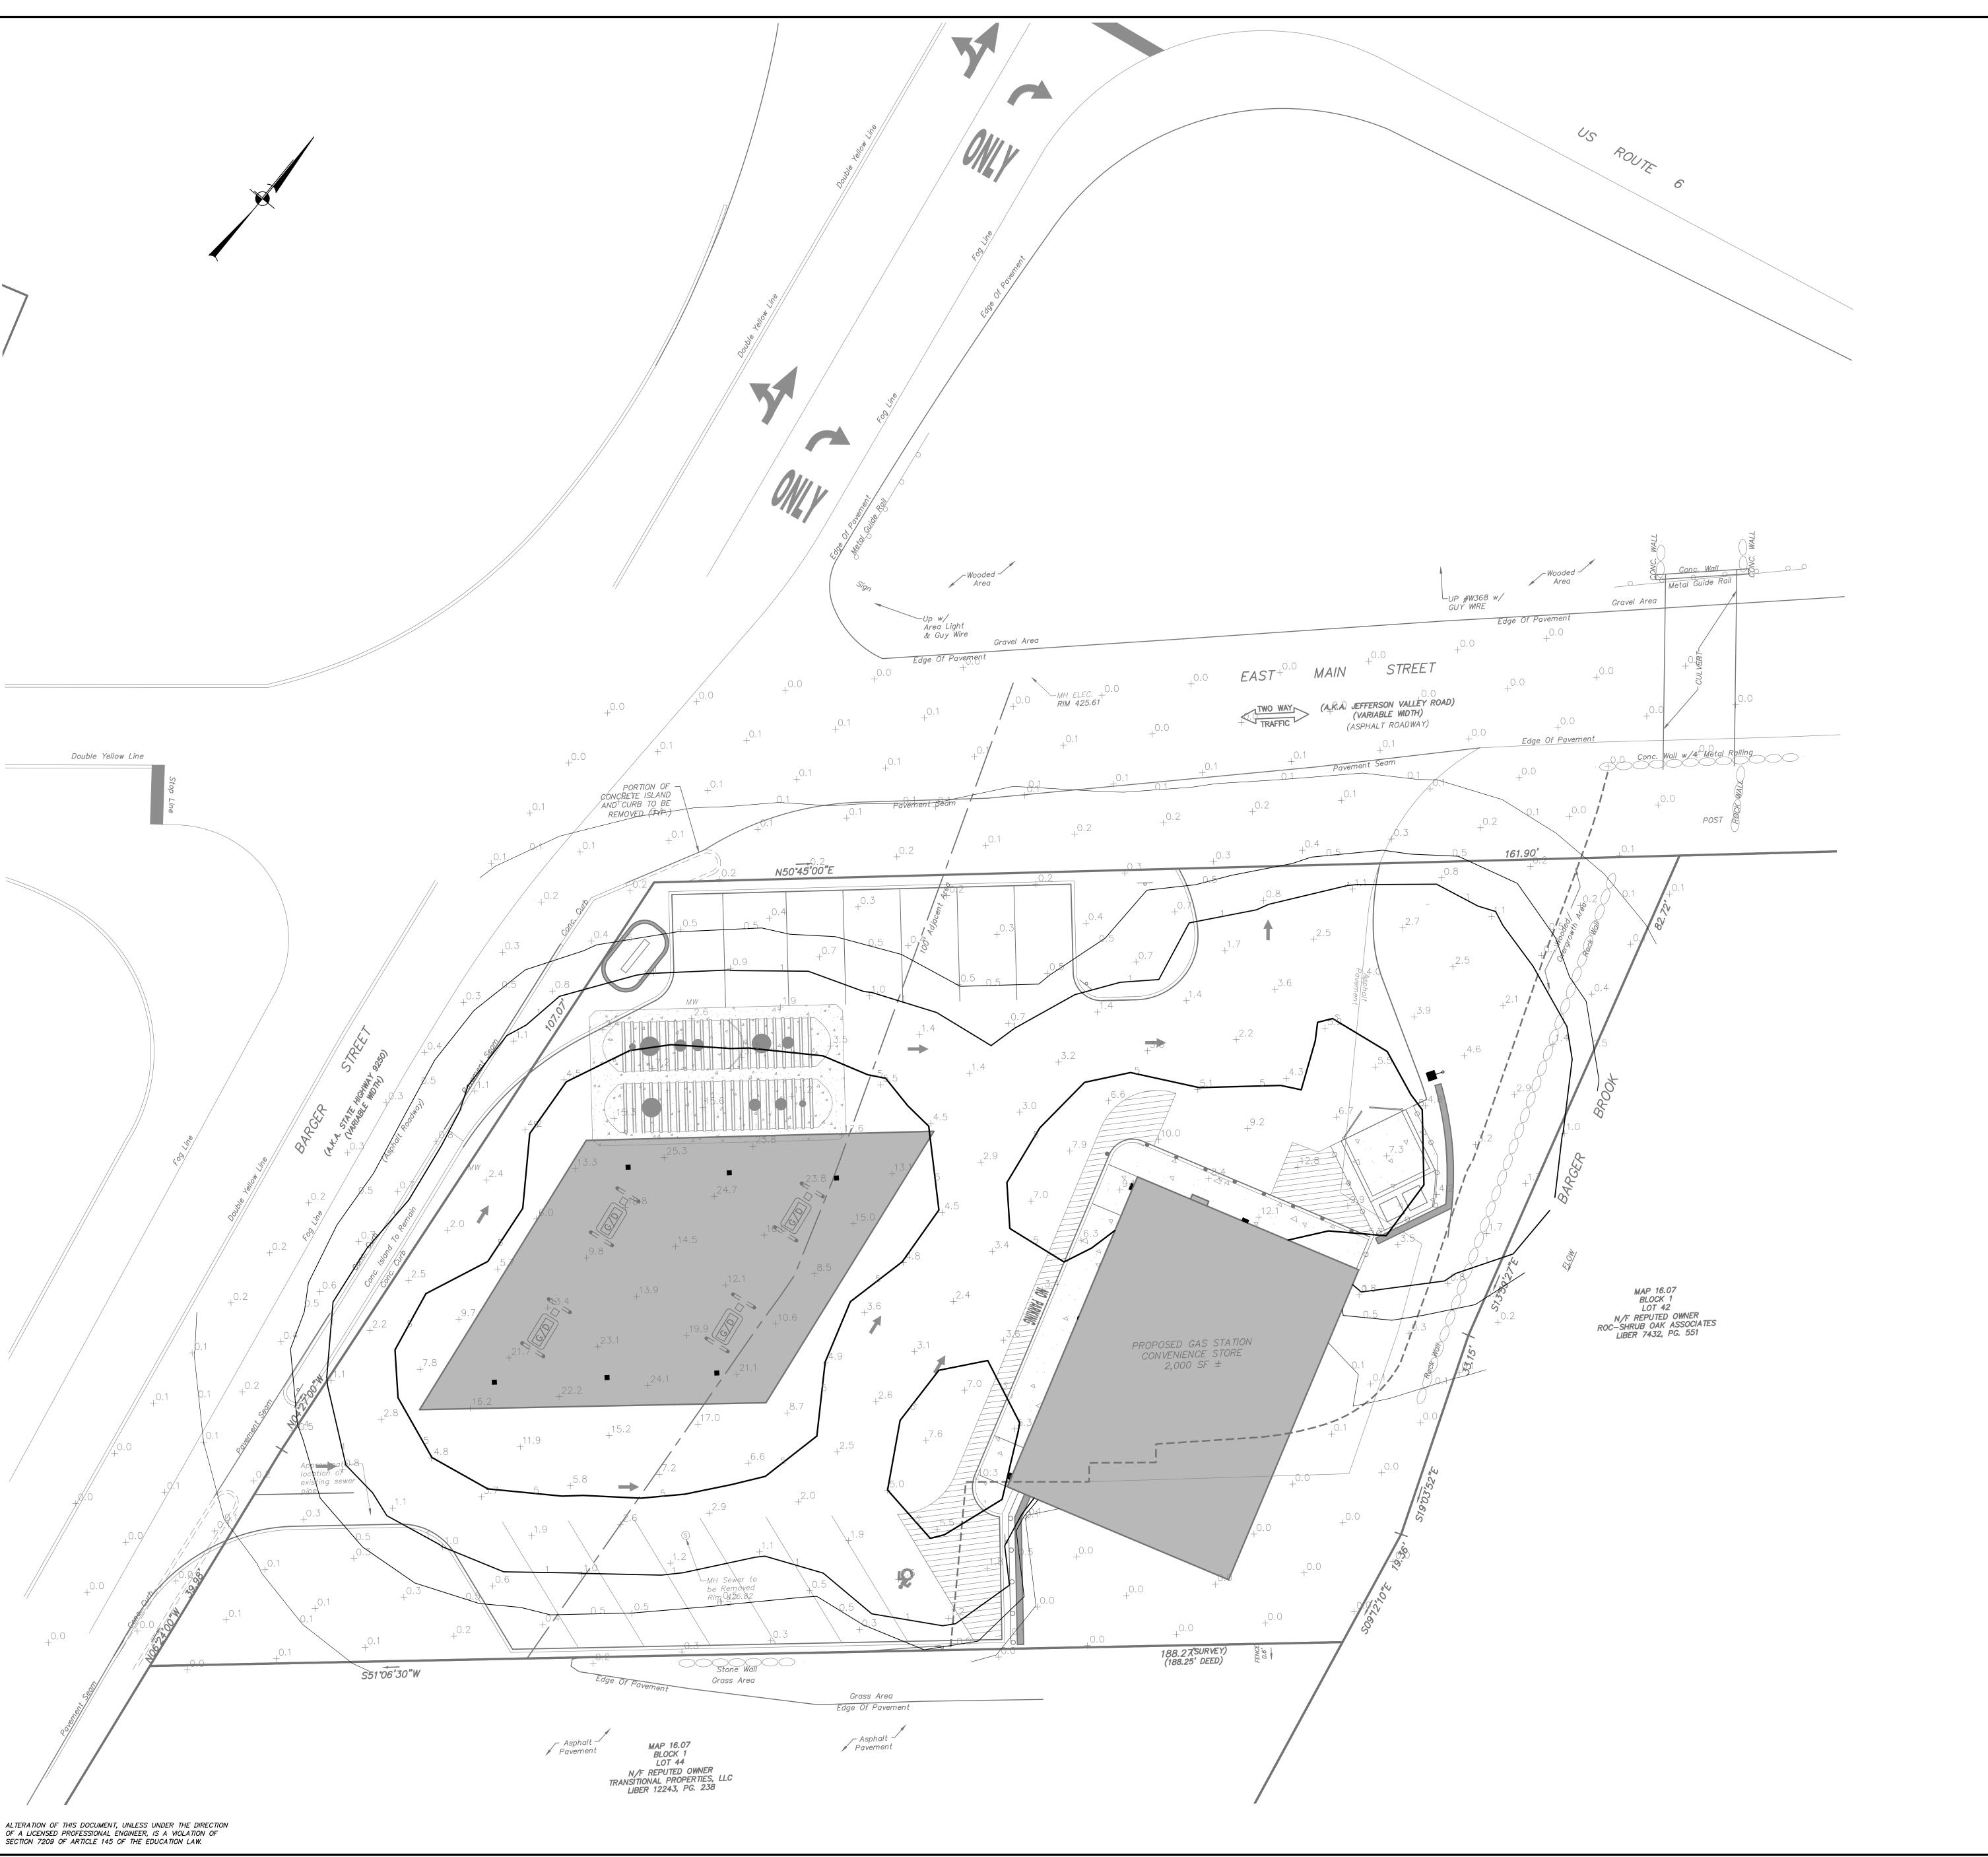


## Cree Edge™ Series LED Area/Flood Luminaire

Performance Summary

CRI: Minimum 70 CRI

**Product Description** 

Slim, low profile design minimizes wind load requirements. Luminaire sides are rugged cast aluminum with integral, weathertight LED driver compartment and high performance aluminum heat sinks. Convenient, interlocking mounting method. Mounting housing is rugged die cast aluminum and mounts to 3–5' (76–152mm) square or round pole. Luminaire is secured by two 5/16-18 UNC bolts spaced on 2" (51 mm) centers.

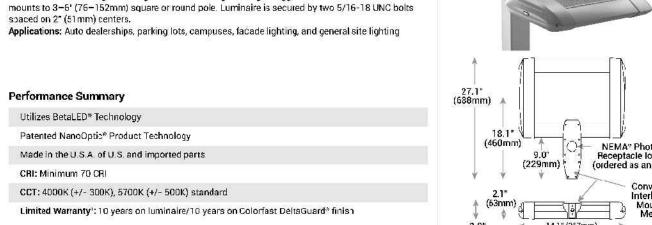

## CPY Series - Version A CFY25C® L∃D Canopy/Soffit Lumina re


**Product Description** 

The CPY250° LED Canopy/Soffit Luminaire has an extremely thin profile constructed of rugged cast aluminum. It can be surface mounted easily from below the canopy cock and can be pendant mounted. Direct imaging of the LEDs is aliminated with a highly efficient patterned flat or 0.71° [23mm] drop glass


Applications: Petroleum canopies, CNG fueling stations, solfits Performance Summary Made in the U.S.A. of U.S. and imported parts Initial Delivered Lumens: Up to 17,470 Efficacy: Up to 125 LPW

CRI: Minimum 70 CRI CCT: 4000K (-/- 300K), 5700K (+/- 500K, Standard Limited Warranty<sup>†</sup>; 10 years on luminaire/10 years on Colorfast DoltaGuard<sup>a</sup> fin sh IF66 Nates [Direct Mount only]

Class I, Division 2 Hazardous Locat on for select models 1556 nttp://tightno.crea.com/warrunty.for warranty terms

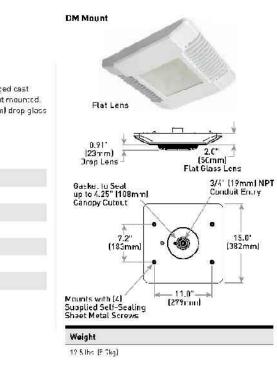

BBW Surface-mounted back box (for conduit entry) 2

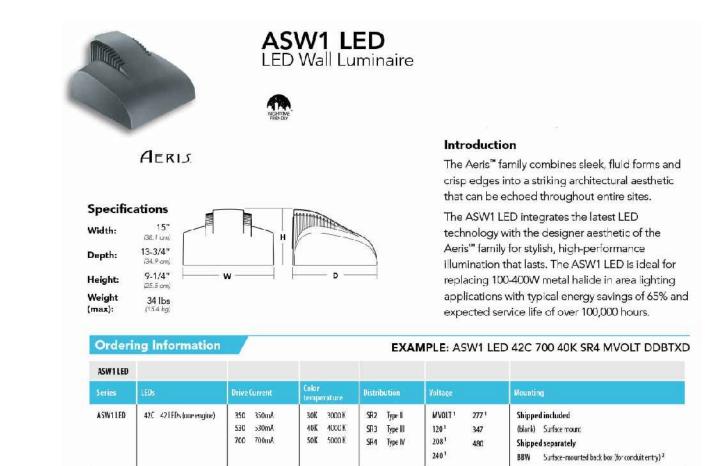

	<u>LEGEND</u>
	= PROPOSED CONCRETE CURB
	— PROPOSED EDGE OF SIDEWALK
$\rightarrow$	PROPOSED PAINTED DIRECTIONAL ARROW
ði	PROPOSED PAINTED HANDICAP PARKING SYMBOL
	PROPOSED LOADING SPACE
•	PROPOSED BOLLARD
0 0	O PROPOSED GUIDE RAIL
<b>———</b>	PROPOSED POLE MOUNTED LIGHT
•	PROPOSED RECESSED CANOPY LIGHT
-	PROPOSED BUILDING MOUNTED LIGHT
	PROPOSED DOOR LOCATION
	■ PROPOSED RETAINING WALL

Symbol	Qty	Catalog Number	Description	Lamp	Mounting Height
Î	1	ARE-EDG-4M-DA- 06-E-UL-WH-700	Cree Post Mounted Area Light	LED	16' - 0"
-	6	CPY250—A—DM—F— B—UL—WH	Cree Recessed Canopy Light	LED	15' - 0"
_	3	ASW1 LED 42C 700 40K SR3 MVOLT	LITHONIA LIGHTING LED WALL LUMINAIRE TYPE 3 DISTRIBUTION	LED	10'-0"

LIGHT CONTOUR LEGEND \_\_\_\_\_ 0.1 \_\_\_\_ 0.10 Foot Candles \_\_\_\_\_ 1 \_\_\_\_\_ 1.00 Foot Candles \_\_\_\_\_ 5 \_\_\_\_ 2.00 Foot Candles

\* Photometric calculations shown on plan are in foot candles.

## LIGHTING NOTES:

1. All lighting shall be as noted on the plan or approved equal. Style and finish of all luminaires to be selected by owner and approved by the Planning Board.

3. Pole mounted lights will be on photocells and will run from dusk to

Light fixtures & lighting layout is preliminary, and is based on a previously approved site plan. Final lighting will be determined with the architectural design of the pump canopy.


	9-3-20	REVISED PER TO	DWN COMMENTS		E.R.A.
1	12-16-19	RESUBMISSION TO TOWN			G.A.M.
NO.	DATE	REVIS	SION		BY
	ENC	NSIT GINEERING, SURVEYII DSCAPE ARCHITECTUR	VG &	3 Garrett Place Carmel, NY 1051 (845) 225–9690 (845) 225–9717 www.insite–eng.c	fax
PROJ		<u> DISTRIBUTORS</u>		OF NEW H	20
3700 I	WING:	WN OF YORKTOWN, WESTCHESTER	COUNTY	OF STATE OF	★ HERVE


GRAPHIC SCALE ( IN FEET )

1 inch = 10 ft.

19195.100 | MANAGER NUMBER A.D.T. CHECKED BY

1" = 10'

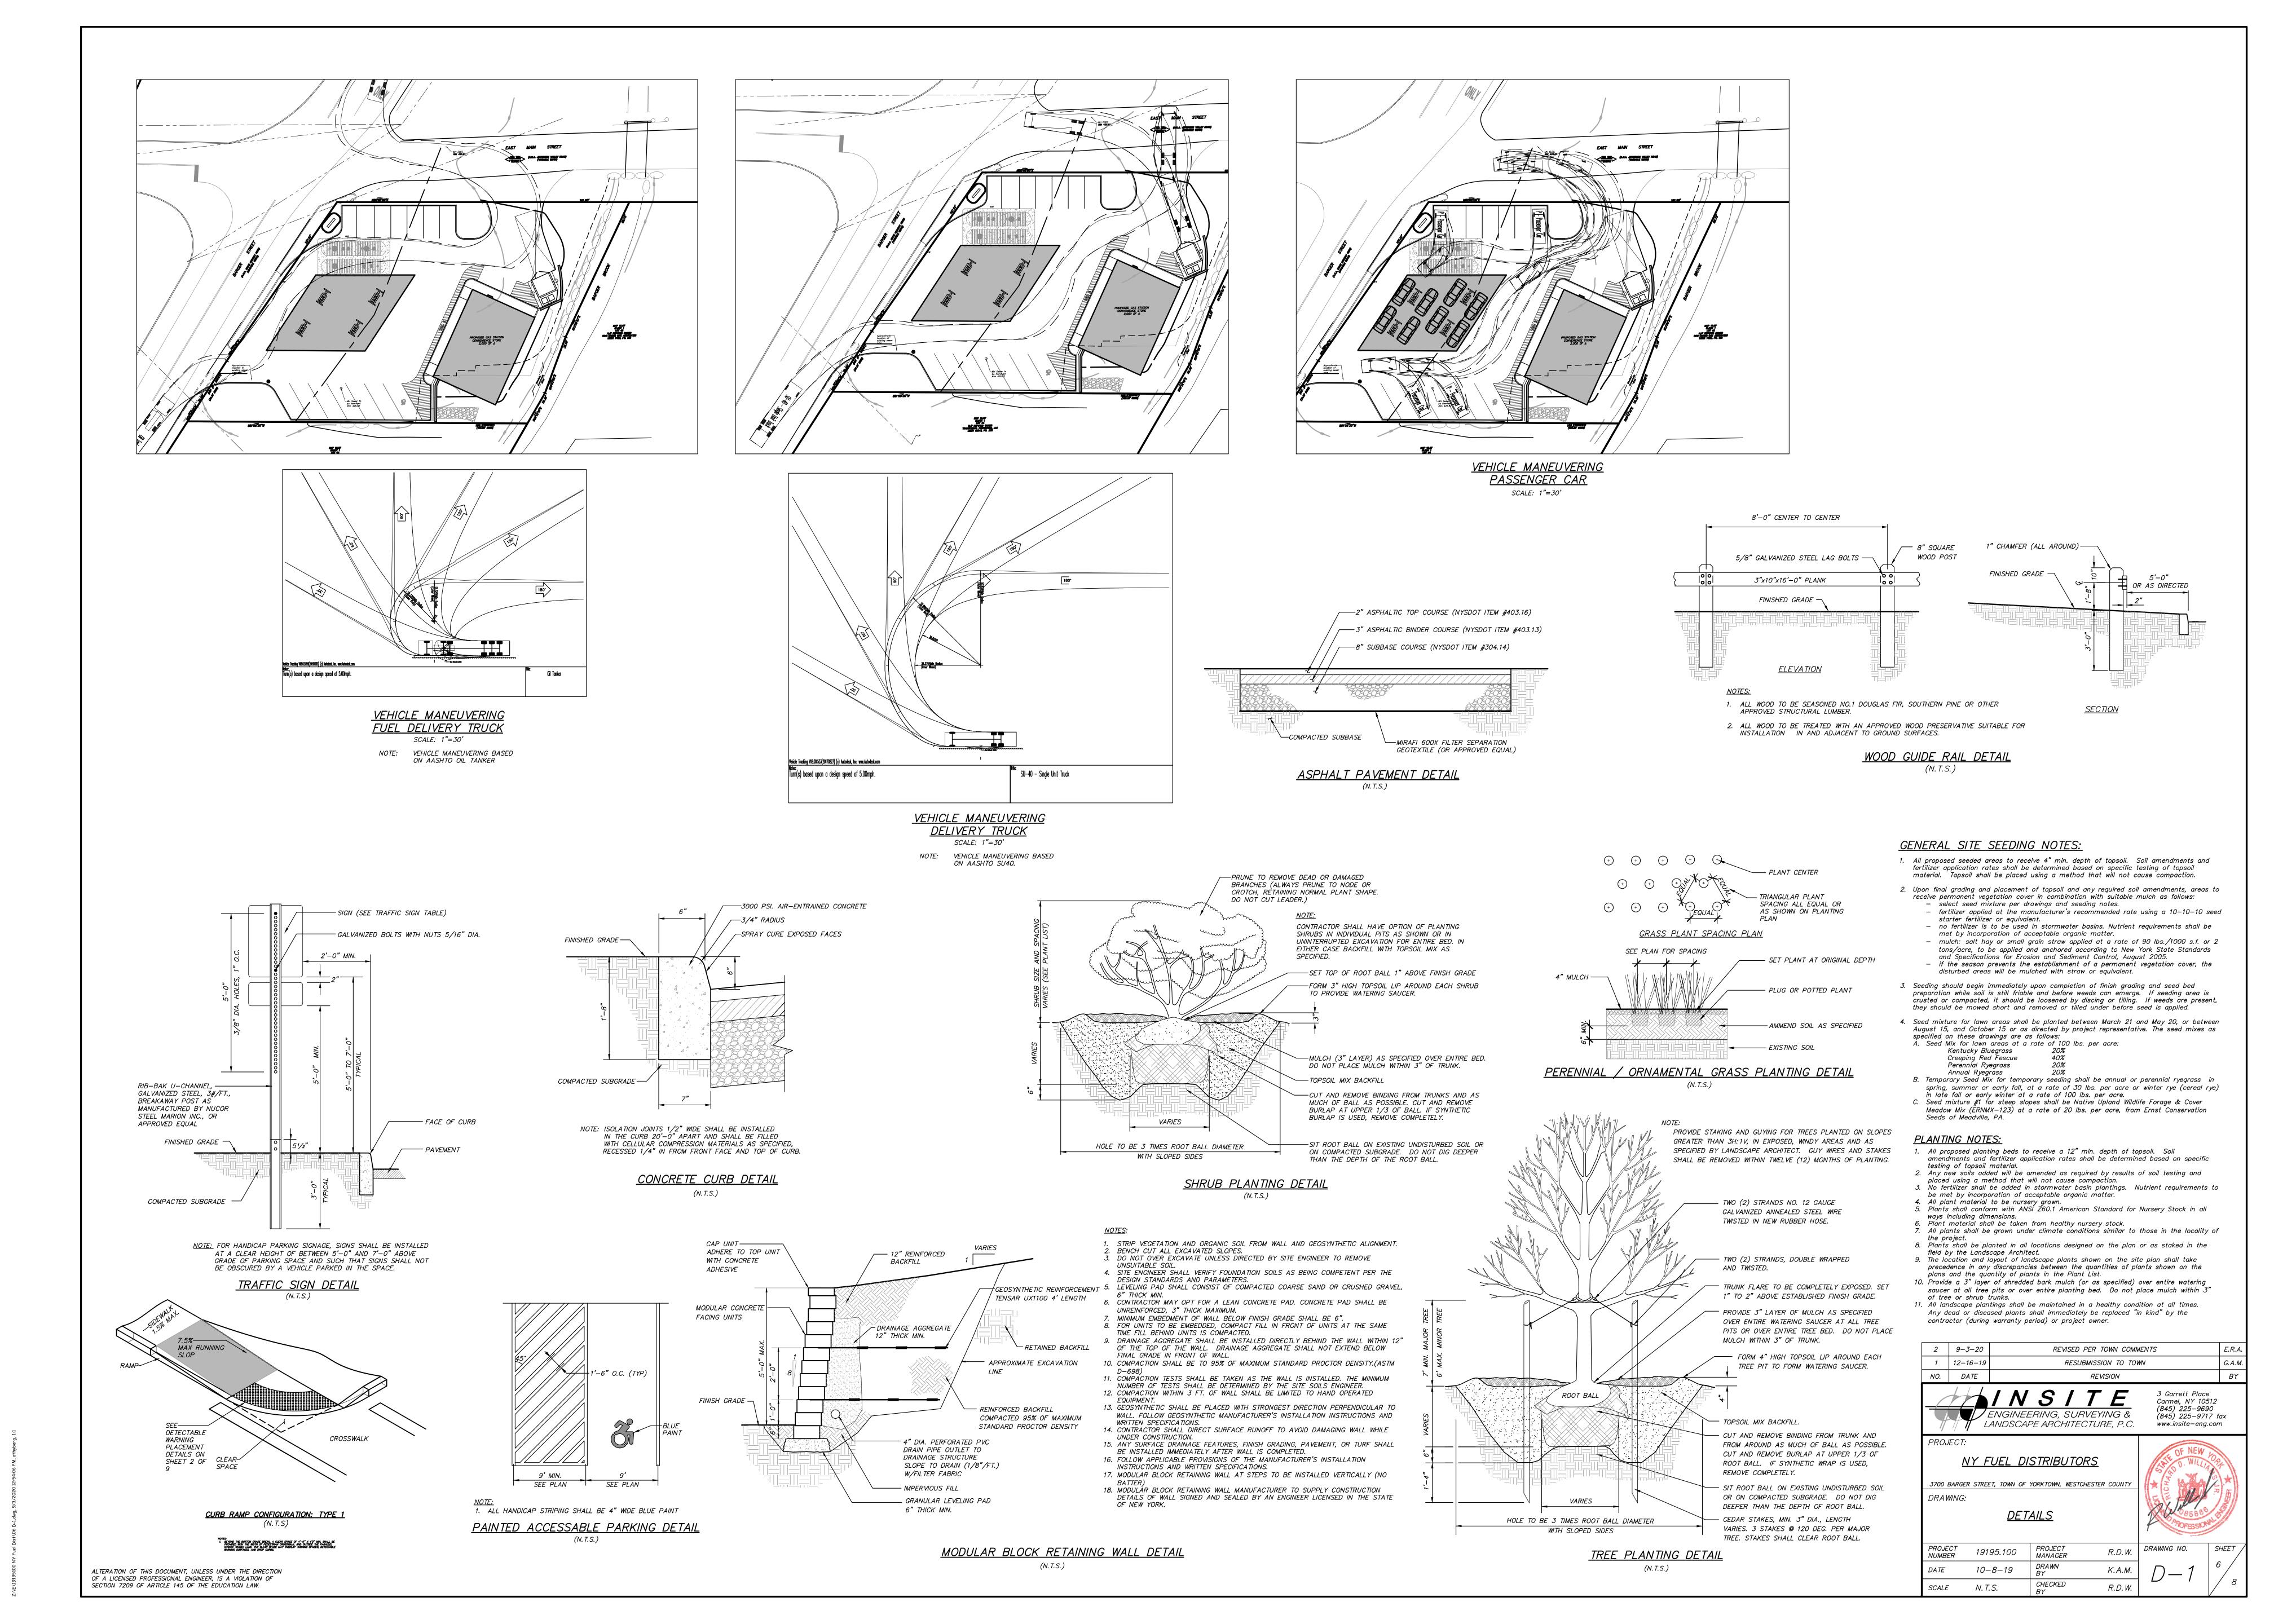

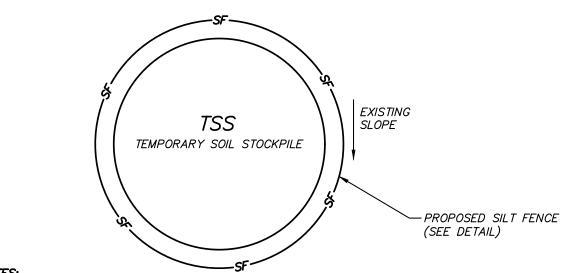



NOTES:


1. AREA CHOSEN FOR STOCKPILE LOCATION SHALL BE DRY AND STABLE.


MAXIMUM SLOPE OF STOCKPILE SHALL BE 2:1.
 UPON COMPLETION OF SOIL STOCKPILING, EACH PILE SHALL BE IMMEDIATELY SEEDED WITH K31 PERENNIAL TALL FESCUE.
 ALL STOCKPILES SHALL BE PROTECTED WITH SILT FENCING INSTALLED ON THE DOWNGRADIENT SIDE.


TEMPORARY SOIL STOCKPILE DETAIL

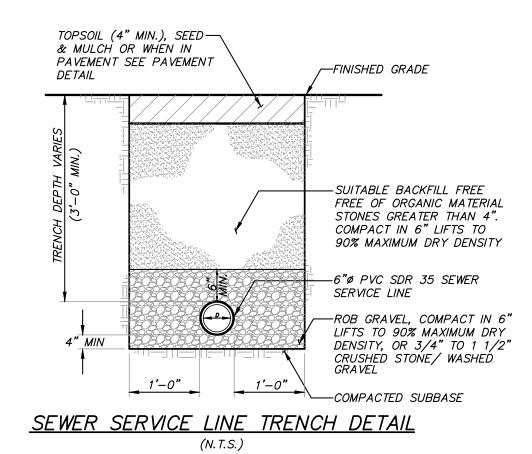


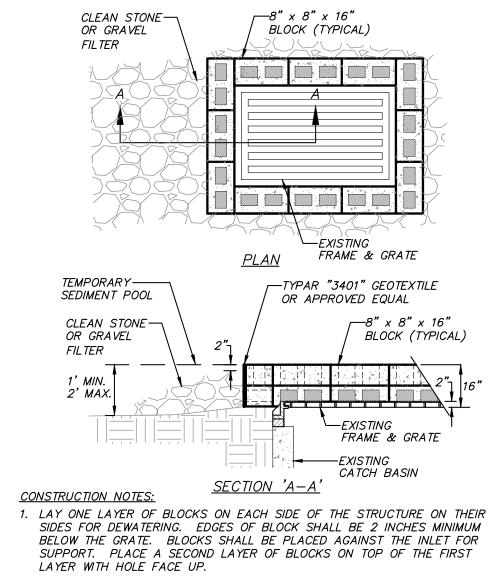

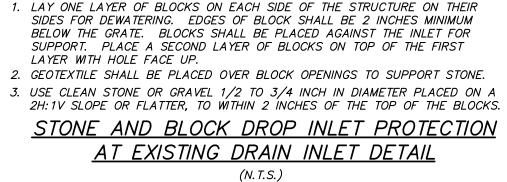

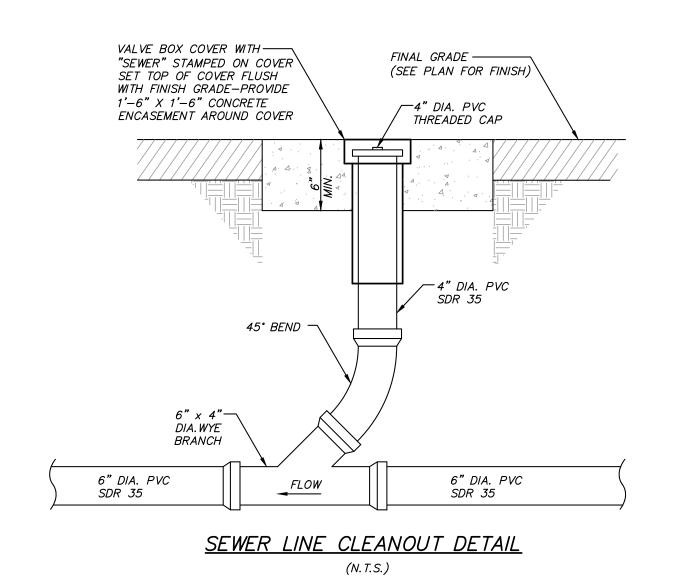


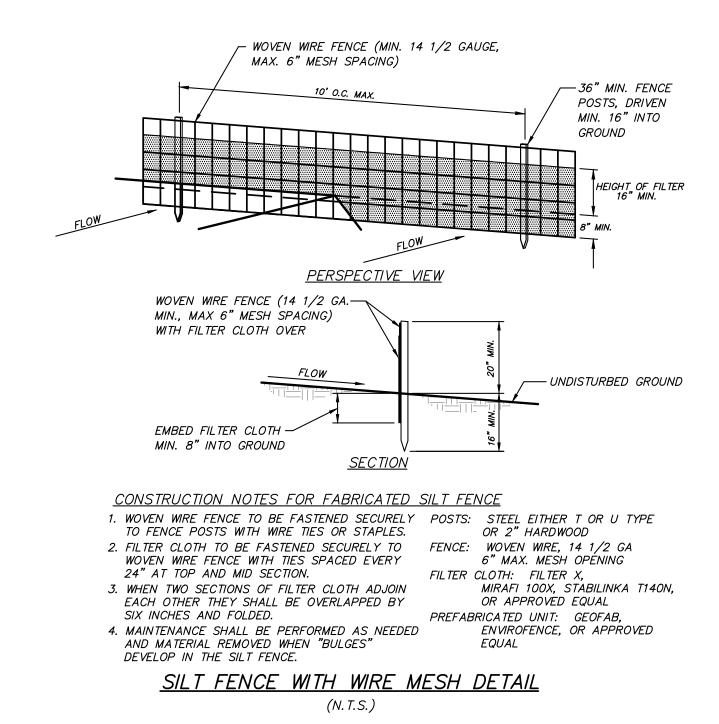

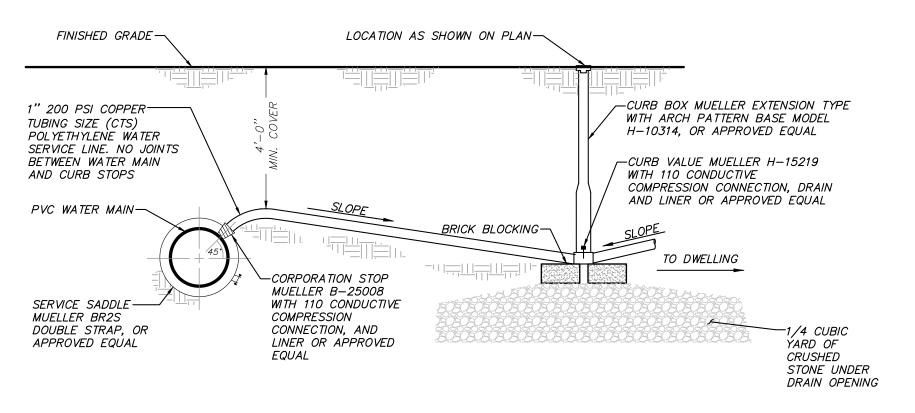


PE WATER SERVICE LINE CONNECTION TO PVC WATER MAIN DETAIL
(N.T.S.)

NOTE:
1. PROVIDE 2' MINIMUM SEPARATION DISTANCE FROM
CORPORATION STOP TO OTHER CORPORATION STOPS,
VALVES, PIPE JOINTS OR FITTINGS.

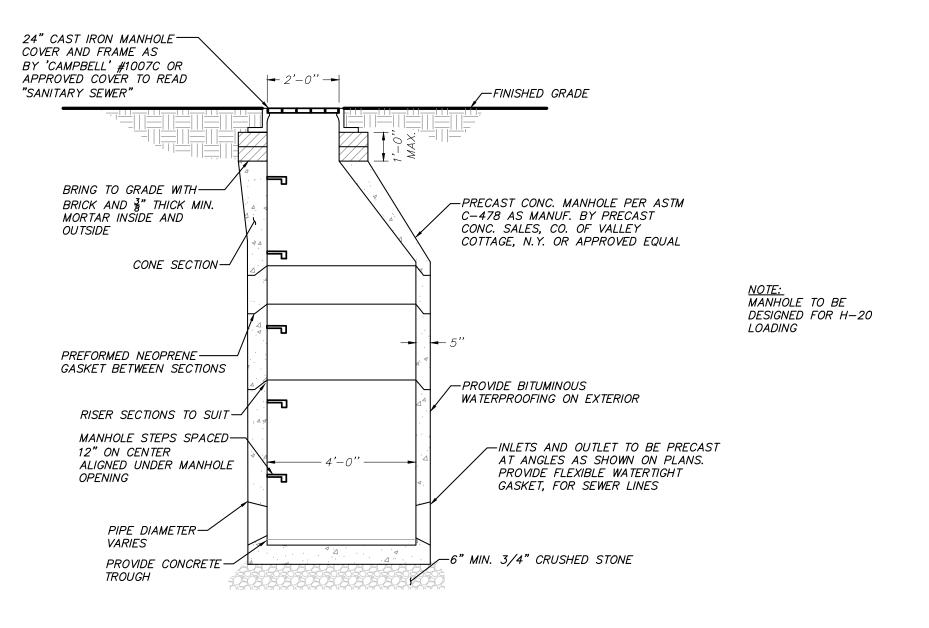

SEWER MANHOLE DETAIL
(N.T.S.)

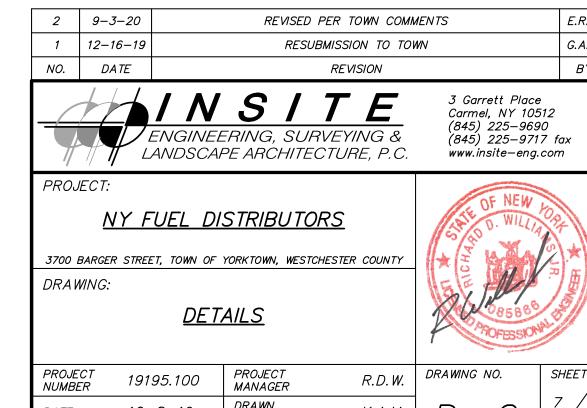


SCALE

ALTERATION OF THIS DOCUMENT, UNLESS UNDER THE DIRECTION OF A LICENSED PROFESSIONAL ENGINEER, IS A VIOLATION OF SECTION 7209 OF ARTICLE 145 OF THE EDUCATION LAW. | SHEET | | 7 | 8


DRAWN
BY


CHECKED
BY


R.D. W.

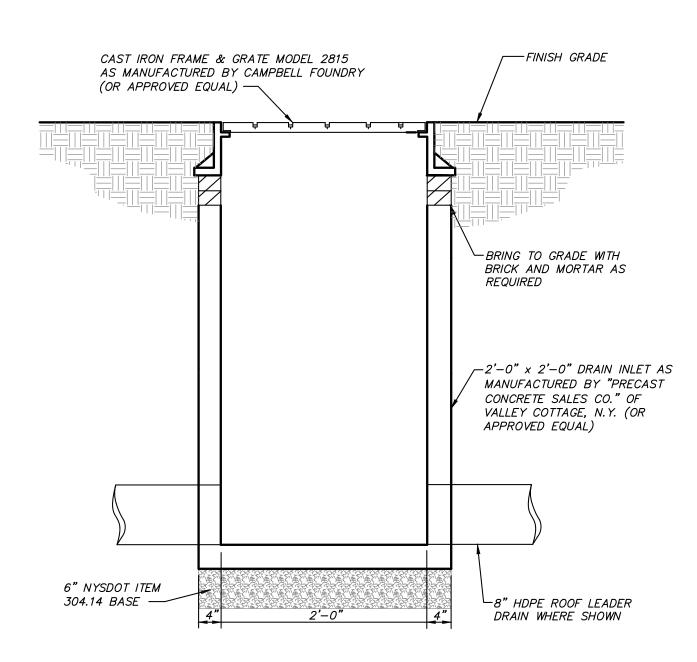



YARD DRAIN DRAIN INLET DETAIL (TO BE DESIGNED FOR H-20 LOADING)

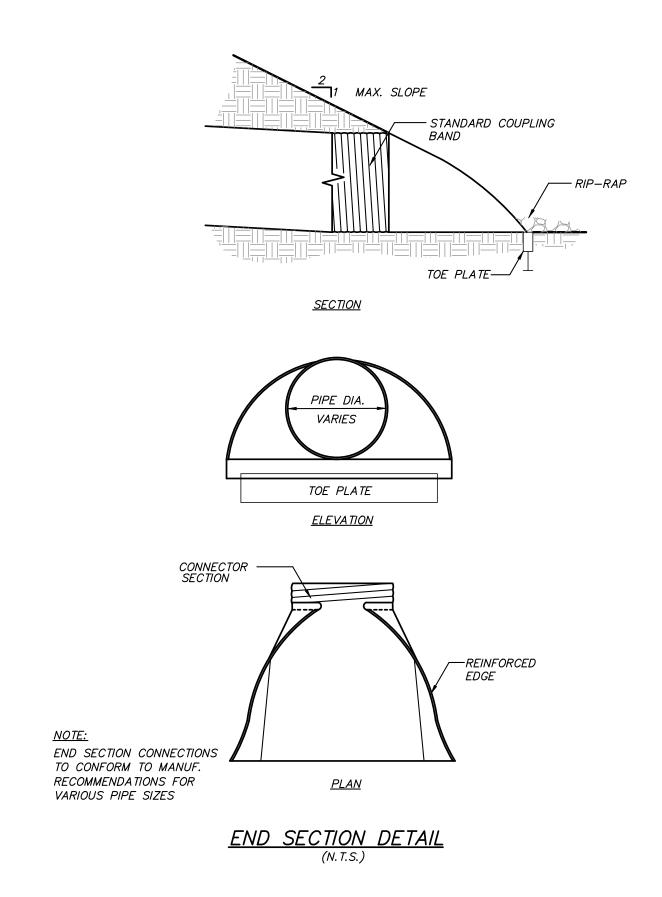


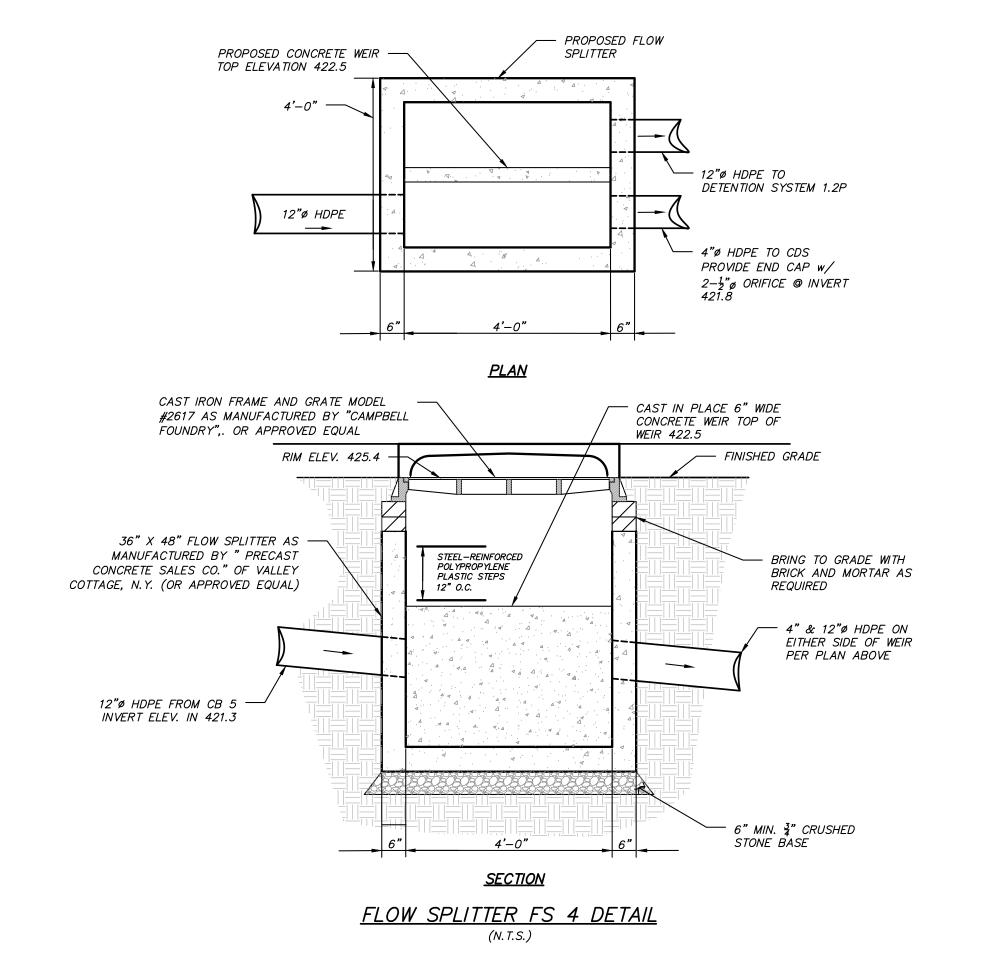

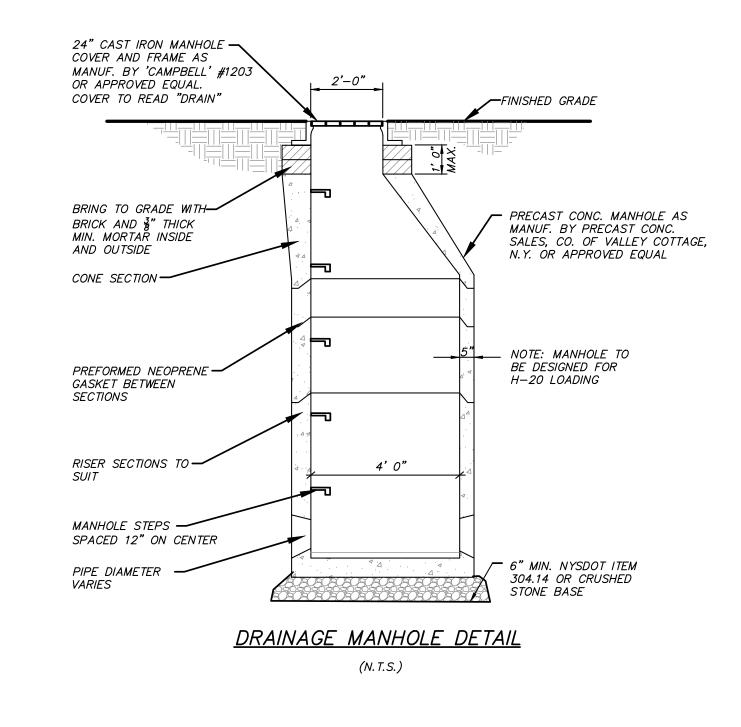

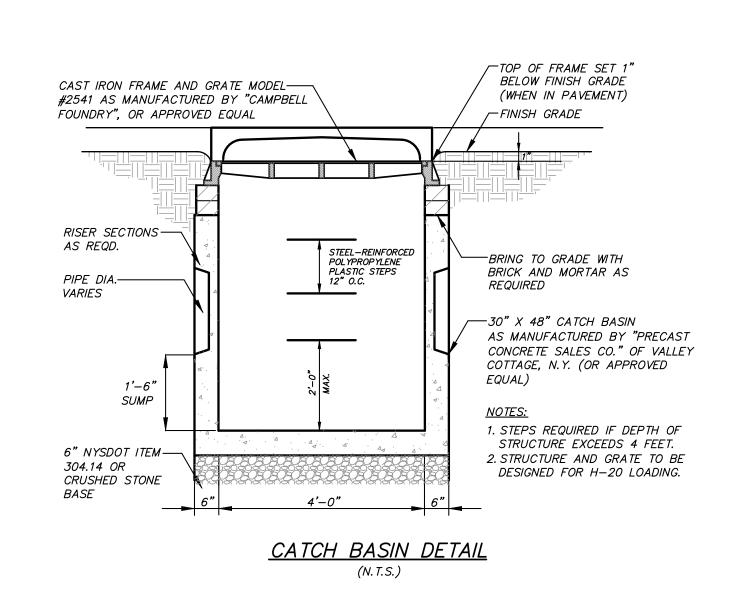

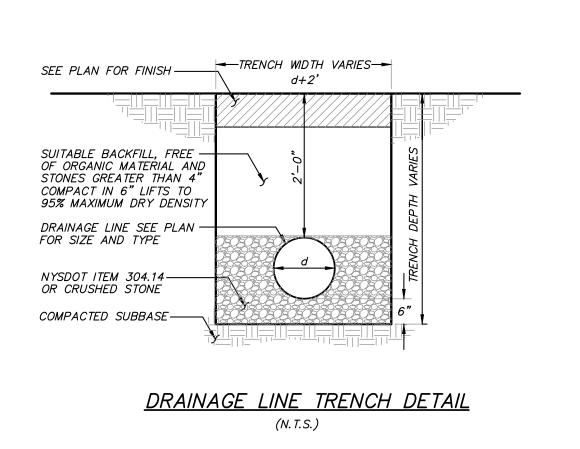

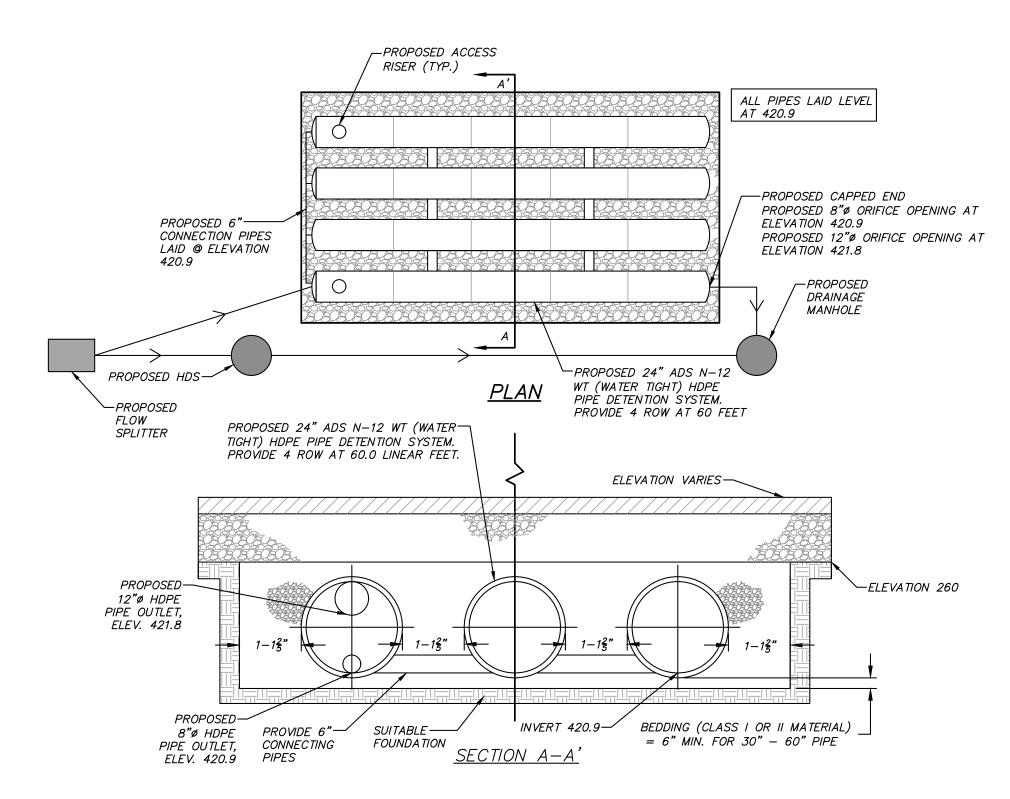

UNDERGROUND PIPE DETENTION SYSTEM PLAN

