HIGHWAY IMPROVEMENT PLANS FOR

UNDERHILL AVENUE IMPROVEMENTS (SEQR # 22-092)

NYS ROUTE 118 (S.H. 148) AT UNDERHILL AVENUE TOWN OF YORKTOWN WESTCHESTER COUNTY NEW YORK STATE

DESIGN TRAFFIC NYS ROUTE	
functional classification	URBAN MINOR ARTERIAL
A.A.D.T.	3,862
POSTED SPEED LIMIT	40 MPH
DESIGN SPEED	45 MPH

DESIGN TRAFFIC UNDERHILL AVENUE (WEST C	
FUNCTIONAL CLASSIFICATION	URBAN MINOR ARTERIAL
A.A.D.T.	9,132
POSTED SPEED LIMIT	40 MPH
DESIGN SPEED	45 MPH

DESIGN TRAFFIC UNDERHILL AVENUE (EAST C	
functional classification	URBAN MINOR ARTERIAL
A.A.D.T.	5,540
POSTED SPEED LIMIT	30 MPH
DESIGN SPEED	35 MPH

132) GIORDANO DR PROJECT LOCATION	BOCES ACC MAPLE HILLST HALYAN RD SHADOW LIN SHADOW LIN SHADOW LIN SHADOW LIN SHADOW LIN THILL AVE
French Hill GLENROCK ST GLENR	Yorktown Heights SUMMITST CENTRAL ST CENTRAL ST CENTRAL ST COMMAND AND COMMAND COMMAN

KEY MAP

SCALE: I" = 1000'

SOURCE: NEW YORK STATE GEOGRAPHIC INFORMATION SYSTEM (GIS)

THE NEW YORK STATE DEPARTMENT OF TRANSPORTATION STANDARD SPECIFICATIONS, LATEST REVISION, TO GOVERN.

STANDARD SPECIFICATION §106-11 BUY AMERICA SHALL APPLY.

NEW YORK STATE DEPARTMENT OF TRANSPORTATION STANDARD SHEETS DATED, LATEST REVISION, ARE APPLICABLE TO THIS PROJECT.

JNAUTHORIZED ALTERATION OR ADDITION TO A SURVEY OR ENGINEERING MAP BEARING A LICENSED LAND SURVEYOR OR PROFESSIONAL ENGINEER IS A VIOLATION OF SECTION 7209, SUB-DIVISION 2, OF THE NEW YORK STATE EDUCATION LAW. ONLY MAPS WITH THE LAND SURVEYOR OR PROFESSIONAL ENGINEER'S SEAL ARE GENUINE TRUE AND CORRECT COPIES OF THE LAND SURVEYOR OR PROFESSIONAL ENGINEER'S ORIGINAL WORK AND OPINION

Colliers

Engineering & Design

	DESCRIPTION	REVISED PER NYSDOT COMMENTS RECEIVED 3/19/24	REVISED PER NYSDOT 4/25/24 COMMENTS.	REVISED PER NYSDOT 5/2/24 COMMENTS.	REVISED TRAFFIC SIGNAL PLAN SHEETS PER NYSDOT SIGNAL GROUP 5/23/24 EMAIL COMMENTS.	REVISED PER NYSDOT 7/1/24 COMMENTS.	REVISED PER NYSDOT 7/31/24 COMMENTS.	REVISED PER QA/QC REVIEW	REVISED PER NYSDOT 8/30/24 COMMENTS.	REVISED PER NYSDOT 9/20/24 COMMENTS. FINAL SET FOR PERMITTING.	
	DRAWN BY	M.J.A.	J.F.M.	M.J.A.	M.J.A.	M.J.A.	M.J.A.	RGD	M.J.A.	M.J.A.	•
	DATE	4/3/24	4/26/24	5/14/24	5/24/24	7/1/24	8/7/24	8/15/24	9/12/24	9/23/24	•
	REV	1	2	3	4	5	9	7	8	6	

INDEX OF SHEETS

COVER SHEET

WZTC-01 TO WZTC-08 WORK ZONE TRAFFIC CONTROL PLAN

GENERAL NOTES

LAYOUT & CONSTRUCTION PLAN

EROSION CONTROL PLANS & DETAILS

ROCHAMBEAU DRIVE INTERSECTION IMPROVEMENTS

GRADING & DRAINAGE PLAN

DESCRIPTION

NUMBER OF

SHEETS

SHEET NUMBERS

GN-01 TO GN-02


DTL-01 TO DTL-05

LP-01 TO LP-03 PP-01 TO PP-03 GD-01 TO GD-03

SP-01 TO SP-03

RD-01

ECP-01 TO ECP-04

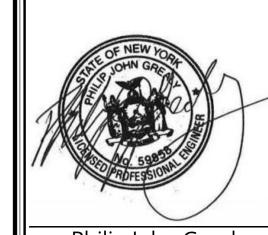

Philip John Grealy LICENSE NUMBER: 059858-1 COLLIERS ENGINEERING & DESIGN CT, P.C. N.Y. C.O.A #: 0017609

HIGHWAY IMPROVEMENT **PLANS**

UNDERHILL AVENUE **IMPROVEMENTS** (SEQR # 22-092)

NYS ROUTE 118 (S.H. 148) AT UNDERHILL AVENUE

TOWN OF YORKTOWN WESTCHESTER COUNTY NEW YORK

& Design

WESTCHESTER 400 Columbus Avenue, Suite 180E

Valhalla, NY 10595 Phone: 914.347.7500

1/8/23 R-PL01-COVR 20006297A

COVER SHEET

CS-01

GENERAL NOTES

- I. TOPOGRAPHIC SURVEY INFORMATION HAS BEEN OBTAINED FROM A SURVEY PREPARED BY COLLIERS ENGINEERING & DESIGN, CT P.C, DATED 11/20/23. NYSDOT RECORD PLANS RC 58-097 MAY ALSO BE MADE AVAILABLE TO THE CONTRACTOR UPON REQUEST.
- 2. MATERIAL AND CONSTRUCTION SPECIFICATIONS: NEW YORK STATE DEPARTMENT OF TRANSPORTATION STANDARD SPECIFICATIONS (US CUSTOMARY) CURRENT REVISION OFFICIALLY ADOPTED AS OF THE EFFECTIVE LETTING DATE, EXCEPT AS MODIFIED IN THE CONTRACT DOCUMENTS.
- 3. CONTRACTOR SHALL FIELD VERIFY EXISTING GRADES, EXISTING STRUCTURE LOCATIONS AND OTHER EXISTING CONDITIONS PRIOR TO CONSTRUCTION AND SHALL REPORT ANY DISCREPANCIES TO THE OWNER'S REPRESENTATIVE FOR FURTHER RESOLUTION.
- 4. THE CONTRACTOR SHALL COMPLETE SURVEY TASKS (I.E., STATION ROADWAY, MARK OUT EXISTING/PROPOSED RIGHT-OF-WAY LINES, MARK OUT UTILITIES, SURVEY MANHOLES, VALVES, AND CATCH BASINS REQUIRING ADJUSTMENT TO PROVIDE A SMOOTH RIDING SURFACE AND PROMOTE PROPER DRAINAGE, ETC.) AS DIRECTED BY THE ENGINEER PRIOR TO BEGINNING ANY CONSTRUCTION WORK. PAYMENT FOR THIS WORK WILL BE MADE UNDER ITEM 625.01. ALL SURVEY NOTES FOR EACH LOCATION SHALL BE SUBMITTED TO THE ENGINEER.
- 5. THE CONTRACTOR SHALL BE AWARE THAT OTHER CONTRACTORS MAY BE WORKING IN THE AREA ON OTHER CONSTRUCTION AT THE SAME TIME THAT WORK IS PERFORMED UNDER THIS CONTRACT. THE CONTRACTOR SHALL BE REQUIRED TO COORDINATE PROJECT WORK WITH OTHER CONTRACTORS AND SHALL SCHEDULE ITS OPERATIONS SO AS TO CAUSE A MINIMUM DISRUPTION TO TRAFFIC.
- 6. THIS PROJECT INVOLVES CONSTRUCTION WITHIN AN ACTIVE ROADWAY. WORK SHALL BE PERFORMED SO AS TO ENSURE THAT PROPER TRAFFIC FLOW IS MAINTAINED DURING CONSTRUCTION. THE CONTRACTOR SHALL PROVIDE WORK ZONE TRAFFIC CONTROL IN ACCORDANCE WITH THE FEDERAL MANUAL ON UNIFORM TRAFFIC CONTROL DEVICES (MUTCD) INCLUDING NEW YORK STATE SUPPLEMENT, THE CONTRACT DOCUMENTS AND AS DIRECTED BY THE ENGINEER.
- 7. THE CONTRACTOR SHALL VERIFY ALL FIELD CONDITIONS AND DIMENSIONS AND SHALL BE RESPONSIBLE FOR FIELD FIT FINISH AND QUALITY OF WORK AND MATERIAL USED IN THE CONSTRUCTION. NO ALLOWANCE SHALL BE MADE ON BEHALF OF THE CONTRACTOR FOR ANY ERROR OR NEGLECT ON HIS PART.
- 8. THE CONTRACTOR IS RESPONSIBLE FOR THE REPLACEMENT AND RESTORATION OF ALL NATURAL AND MANMADE FEATURES WHETHER SHOWN ON THE PLANS OR ENCOUNTERED IN THE FIELD. IT IS THE INTENTION OF THE PLANS TO SHOW ONLY MAJOR FEATURES TO BE PROTECTED, RESTORED, OR REPLACED.
- 9. PROTECTION AND RESTORATION OF PROPERTY SHALL BE IN ACCORDANCE WITH THE NYSDOT STANDARD SPECIFICATIONS.
- 10. TOPSOIL (ITEM 610.1402 TOPSOIL ROADSIDE) SHALL BE PLACED, AND AREAS SHALL BE SEEDED (ITEM 610.1601 TURF ESTABLISHMENT ROADSIDE) AS SOON AS FINAL GRADES ARE ESTABLISHED ON PERMANENT SLOPES. SLOPES SHALL BE MULCHED (ITEM 209.100101 MULCH TEMPORARY).
- II. THE CONTRACTOR SHALL CONTACT ALL THE APPROPRIATE PARTIES WITH JURISDICTION OVER THE UTILITIES ENTERING ON OR NEAR THE PROJECT AREA PRIOR TO INITIATION OF CONSTRUCTION ACTIVITIES AND PROVIDE THOSE AGENCIES 72-HOURS NOTIFICATION.
- 12. THE CONTRACTOR SHALL VERIFY THE LOCATION OF AND SHALL BE RESPONSIBLE FOR THE PRESERVATION OF ALL PUBLIC AND PRIVATE UNDERGROUND AND SURFACE UTILITIES AND STRUCTURES AT OR ADJACENT TO THE SITE OF CONSTRUCTION, IN SO FAR AS THEY MAY BE ENDANGERED BY HIS OPERATIONS. THIS SHALL HOLD TRUE WHETHER OR NOT THEY ARE SHOWN ON THE CONTRACT DRAWINGS. IF THEY ARE SHOWN ON THE DRAWINGS, THEIR LOCATIONS ARE NOT GUARANTEED EVEN THOUGH THE INFORMATION WAS OBTAINED FROM THE BEST AVAILABLE SOURCES, AND IN ANY EVENT, OTHER UTILITIES NOT SHOWN ON THESE PLANS MAY BE ENCOUNTERED IN THE FIELD. THE CONTRACTOR SHALL, AT HIS OWN EXPENSE, REPAIR OR REPLACE ANY STRUCTURES OR UTILITIES THAT HE DAMAGES AND SHALL CONSTANTLY PROCEED WITH CAUTION TO PREVENT UNDUE INTERRUPTION OF UTILITY SERVICES.
- 13. IF TEMPORARY UTILITY SERVICES ARE REQUIRED, AS DETERMINED BY THE ENGINEER, THE CONTRACTOR SHALL FURNISH AND MAINTAIN SUCH SERVICES UNTIL THE ENGINEER DEEMS THEY ARE NO LONGER REQUIRED. THE CONTRACTOR SHALL PROVIDE THE TEMPORARY UTILITY SERVICES AT NO ADDITIONAL COST TO THE STATE/TOWN. ALL PAVEMENT MARKINGS AND SIGNS SHALL BE IN CONFORMANCE WITH THE MUTCD AND THE REQUIREMENTS OF THE CONTRACT DOCUMENTS.
- 14. ALL DISTURBED AREAS WITHIN THE ROW SHALL BE RESTORED AS DIRECTED BY THE ENGINEER. PAYMENT WILL BE MADE UNDER ITEM 610.1402 TOPSOIL ROADSIDE, ITEM 610.1601 TURF ESTABLISHMENT ROADSIDE AND ITEM 209.100101 MULCH TEMPORARY.
- 15. THE CONTRACTOR SHALL INSTALL AND MAINTAIN SOIL EROSION AND SEDIMENT CONTROL MEASURES IN ACCORDANCE WITH §209 OF THE NYSDOT STANDARD SPECIFICATION AND STANDARD SHEETS 209-01 THROUGH 209-07.
- 16. ALL MATERIALS, SHOP, ERECTION, DEMOLITION, TEMPORARY STRUCTURE, PROCEDURAL AND OTHER DRAWINGS WHICH NEED NYSDOT APPROVAL SHALL BE SUBMITTED TO THE ENGINEER FOR DISTRIBUTION TO THE APPROPRIATE APPROVAL OFFICE. THIS INCLUDES DRAWINGS FROM FABRICATORS AND PRE-CASTERS. THE CONTRACTOR IS CAUTIONED NOT TO ORDER EQUIPMENT AND/OR MATERIALS UNTIL THE REQUIRED DRAWINGS ARE APPROVED IN WRITING.

EXCAVATION SPECIAL NOTES

- I. TRANSVERSE UTILITY CROSSINGS UNDER NYSDOT PAVEMENT SHALL BE A MINIMUM OF FIVE (5) FEET BETWEEN THE TOP OF THE PAVEMENT AND THE TOP OF UTILITY.
- 2. LONGITUDINAL UTILITY RUNS, OUTSIDE THE PAVEMENT LIMITS MUST BE A MINIMUM OF THREE (3) FEET FROM TOP OF GRADE TO TOP OF UTILITY. THE PAVEMENT LIMITS ARE 50 FEET FROM THE HIGHWAY CENTER LINE.
- 3. LONGITUDINAL UTILITY RUNS SHOULD BE KEPT AS CLOSE TO THE RIGHT OF WAY LINE OR AS FAR FROM THE PAVEMENT AS POSSIBLE.
- 4. ANY EXCAVATION WHICH EXCEEDS FIVE FEET IN DEPTH AND HAS LIVE TRAFFIC OR UTILITIES WITHIN IV:IH PROJECTION FROM THE BOTTOM EXCAVATION SHALL UTILIZE A SHEETING/SHORING SYSTEM WHICH PROVIDES DIRECT CONTACT AND SUPPORT OF THE EXCAVATION SIDES (A TRENCH BOX DOES NOT MEET THESE REQUIREMENTS). THE CONTRACTOR SHALL PROVIDE VERIFICATION (I.E., MANUFACTURER'S DATA SHEETS AND/OR P.E. DESIGN COMPUTATIONS) TO THE ENGINEER DEMONSTRATING THAT THE SYSTEM CHOSEN CAN ACCOMMODATE THE ANTICIPATED SOIL, WATER, TRAFFIC AND SURCHARGE LOADINGS. PAYMENT SHALL BE MADE UNDER ITEM 552.17 SHIELDS AND SHORING AS SPECIFIED IN THE CONTRACT DOCUMENTS
- 5. DESIGN DOCUMENTS FOR PREFABRICATED "SHEETING BOX," WHERE USED, SHALL BE SIGNED AND SEALED BY A PROFESSIONAL ENGINEER REGISTERED IN THE STATE OF NEW YORK.

EXISTING UTILITIES

I. THE UTILITY LOCATION QUALITY LEVEL LABELING CONVENTION SHOWN ON THE PLANS DOES NOT RELIEVE THE CONTRACTOR OF HIS OBLIGATIONS UNDER SECTIONS 660 THROUGH 680 OF THE STANDARD SPECIFICATIONS.

THE QUALITY LEVEL DEFINITIONS ARE:

QUALITY LEVEL A - THE HIGHEST DEGREE OF ACCURACY; THE UTILITY INFORMATION ON THE CONTRACT PLANS HAS BEEN FIELD LOCATED AND VERIFIED BY EXCAVATION, WHEN APPROPRIATE. (SHOWN AS QLA)

QUALITY LEVEL B - SUBSURFACE GEOPHYSICAL LOCATING TECHNIQUES (THAT IS, UNDERGROUND CAMERAS, RADAR, SONAR, TONE OUTS, ETC.) AND EXISTING RECORD PLANS HAVE BEEN USED TO LOCATE UTILITIES. NO EXCAVATIONS WERE PERFORMED. (SHOWN AS QLB)

QUALITY LEVEL C - RECORD INFORMATION PROVIDED BY UTILITY OWNERS WAS PLOTTED ON THE CONTRACT PLANS. DEPTHS WERE NOT FIELD VERIFIED, PHYSICAL SURFACE FEATURES LIKE MANHOLES, VALVE BOXES AND HYDRANTS HAVE BEEN FIELD LOCATED. (SHOWN AS QLC)

QUALITY LEVEL D - EXISTING NYSDOT AND UTILITY COMPANY RECORDS WERE USED TO LOCATE SUBSURFACE UTILITIES. (SHOWN AS QLD)

THE UTILITY QUALITY LEVELS FOR ALL PLAN SHEETS IN THIS CONTRACT ARE AS FOLLOWS:

<u>UTILITIES</u>	QUALITY LE
ELECTRIC	QLD
GAS	QLD
TELEPHONE	QLD
CABLE TV	QLD
SEWER	QLB
DRAINAGE	QLB
NYSDOT LIGHTING	QLD
WATER	QLB

- 2. IT IS THE RESPONSIBILITY OF THE CONTRACTOR, UNDER PART 753 OF THE NEW YORK STATE INDUSTRIAL CODE, TO DETERMINE THE EXACT LOCATION OF THE UNDERGROUND FACILITIES PRIOR TO WORKING IN THE AREA. ANY DAMAGE CAUSED BY THE CONTRACTOR'S OPERATIONS SHALL BE REPAIRED AT THE CONTRACTOR'S EXPENSE.
- 3. THE CONTRACTOR IS ALERTED TO THE FACT THAT THE PROVISIONS OF NEW YORK STATE INDUSTRIAL CODE, PROTECTION OF UNDERGROUND FACILITIES, APPLY TO THIS PROJECT. NO DIRECT PAYMENT FOR ANY WORK REQUIRED BY THE CODE WILL BE MADE. WHERE EXISTING UTILITIES ARE LOCATED WITHIN THE CONTRACT LIMITS, THE CONTRACTOR SHALL PROVIDE AT LEAST 72 HOURS' NOTICE BEFORE PERFORMING ANY WORK AT OR NEAR UNDERGROUND FACILITIES. THE CONTRACTOR WILL BE RESPONSIBLE FOR ASSERTING THE ACTUAL LOCATION OF ALL UTILITIES NOT MARKED OUT THROUGH THE ONE CALL CENTER.
- 4. ALL EXISTING UTILITIES WITHIN THE LIMITS OF THE WORK ZONE WILL BE SERVICED AND MAINTAINED BY THE UTILITY COMPANY OR ORGANIZATION HAVING CONTROL AND JURISDICTION THEREOF. THE CONTRACTOR SHALL COORDINATE CONSTRUCTION ACTIVITIES TO ACCOMMODATE THESE MAINTENANCE REQUIREMENTS. NO SEPARATE PAYMENT IS MADE FOR THIS WORK. THE COST OF THIS EFFORT IS TO BE INCLUDED UNDER THE VARIOUS ITEMS OF THE CONTRACT.
- 5. THE ENGINEER SHALL BE NOTIFIED A MINIMUM OF 5 WORKING DAYS IN ADVANCE OF ALL COMMUNICATION AND COORDINATION MEETINGS RELATED TO THIS PROJECT BETWEEN THE CONTRACTOR AND ANY UTILITY COMPANY.
- 6. THE CONTRACTOR IS ADVISED THAT DURING THE COURSE OF THIS WORK IT MAY BECOME NECESSARY TO DETERMINE THE PRESENCE OF EXISTING UNDERGROUND UTILITY TYPE, SIZE, PROXIMITY AND/OR CONDITION BY MEANS OF EXCAVATION WHICH IS NON-DESTRUCTIVE AND IS LOCALIZED AND DOES NOT CAUSE ANY DIRECT OR INDIRECT DAMAGE TO THE EXISTING UTILITY IN ANY WAY. AT ALL SUCH LOCATIONS OR AS DIRECTED BY THE ENGINEER, THE CONTRACTOR SHALL EXCAVATE AND BACKFILL TEST PITS OR EXAMINATION PITS BY HAND AND/OR VACUUM EXCAVATION IN A MANNER THAT IS APPROVED BY THE ENGINEER AND PREVENTS DAMAGE TO THE WRAPPING, COATING OR OTHER PROTECTIVE COVERING OF THE UTILITY LINE. THE SIZE OF THE EXCAVATION SHALL BE SUFFICIENT TO DETERMINE THE PRESENCE OF EXISTING UNDERGROUND UTILITY TYPE, SIZE, PROXIMITY AND/OR CONDITION. THE PAYMENT SHALL BE INCLUDED AT A SET QUANTITY OF 2.5 CY PER TEST HOLE REGARDLESS OF THE SIZE OF THE TEST PIT HOLE.

SIGNING NOTES

- I. IF EXISTING SIGNS ARE REMOVED BEFORE THE NEW ONES ARE INSTALLED, TEMPORARY SIGNS SHALL BE PROVIDED AT THESE LOCATIONS. THE REMOVAL OF EXISTING SIGNS THAT ARE BEING REPLACED SHALL BE REMOVED AS DIRECTED BY THE ENGINEER. FURNISHING, MOUNTING AND REMOVAL OF TEMPORARY SIGNS SHALL BE INCLUDED IN THE BASIC WORK ZONE TRAFFIC CONTROL ITEM.
- 2. THE CONTRACTOR SHALL NOT REMOVE EXISTING GROUND-MOUNTED GUIDE SIGNS UNTIL PROPOSED GUIDE SIGNS ARE INSTALLED TO THE SATISFACTION OF THE ENGINEER.

	Та	able of Maintenance Jurisdiction			
Highway	Limits	Features to Be Maintained	CL Miles	Agency	Jurisdiction
NYS ROUTE 118 (S.H. 148)	STA 124+07.18 to STA 128+71.97	Sidewalks, landscaped areas & sidewalk snow removal	0.09	Town of Yorktown	Section 140 of Highway Law
NYS ROUTE 118 (S.H. 148)	STA 123+61.63	Traffic Signal No. W-213	-	New York State	Sections 340 of Highway Law
NYS ROUTE 118 (S.H. 148)	STA 124+07.18 to STA 128+71.97	All other features including pavement snow removal, curbing, pavement markings, and signs	0.09	New York State	Sections 340 of Highway Law
NYS ROUTE 118 (S.H. 148)	STA 127+52.30 to STA 128+89.83	Drainage Structures DMH-10 its inlet and outlet pipes, and the end section terminus ES-2	0.03	370 Underhill Avenue Property Owner	-
Underhill Avenue	STA P119+12.55 to STA P124+12.87 and STA P125+86.49 to STA P+127+83.45	Sidewalks, landscaped areas & sidewalk snow removal, pavement snow removal, curbing, pavement markings, signs and drainage.	0.13	Town of Yorktown	Section 10 of Highway Law

OTES:

- 1) Intersecting roads or driveways not on the State Highway system shall be maintained by the owning agency, municipality, or private individual(s) from the extension of the outside edge of shoulder, or curb line, or back of ditch of the state highway to the limit of work as shown on the contract plans.
- 2) All existing sanitary sewers and other sewers not deemed to be part of the project by the commissioner, water mains, hydrants and other municipally or privately owned facilities within the limits of the highway Right-of-Way which remain in service unchanged and all such facilities relocated or protected as part of the work performed under this project, whether crossing, located within or adjacent to the R.O.W., shall be maintained, as the case may be, by the municipality or by the agency or unit owning or having control and jurisdiction thereof at no cost or expense to the State.

Colliers

Engineering & Design

www.colliersengineering.com

Copyright © 2024. Colliers Engineering & Design All Rights Reserved. This draw and all the information contained herein is authorized for use only by the party whom the services were contracted or to whom it is certified. This drawing may be copied, reused, disclosed, distributed or relied upon for any other purp without the express written consent of Colliers Engineering & Design



PROTECT YOURSELF

ALL STATES REQUIRE NOTIFICATION OF EXCAVATORS, DESIGNERS, OR ANY PERSON PREPARING TO DISTURB THE EARTH'S SURFACE ANYWHERE IN ANY STATE

FOR STATE SPECIFIC DIRECT PHONE NUMBERS
VISIT: WWW.CALL811.COM

REV	DATE	DRAWN BY	DESCRIPTION
1	4/3/24	M.J.A.	REVISED PER NYSDOT COMMENTS RECEIVED 3/19/24
2	4/26/24	J.F.M.	REVISED PER NYSDOT 4/25/24 COMMENTS.
3	5/14/24	M.J.A.	REVISED PER NYSDOT 5/2/24 COMMENTS.
4	5/24/24	M.J.A.	REVISED TRAFFIC SIGNAL PLAN SHEETS PER NYSDOT SIGNAL GROUP 5/23/24 EMAIL COMMENTS.
2	7/1/24	M.J.A.	REVISED PER NYSDOT 7/1/24 COMMENTS.
9	8/7/24	M.J.A.	REVISED PER NYSDOT 7/31/24 COMMENTS.
	8/15/24	RGD	REVISED PER QA/QC REVIEW
8	9/12/24	M.J.A.	REVISED PER NYSDOT 8/30/24 COMMENTS.
6	9/23/24	M.J.A.	REVISED PER NYSDOT 9/20/24 COMMENTS. FINAL SET FOR PERMITTING.



Philip John Grealy
NEW YORK LICENSED PROFESSIONAL ENGINEER
LICENSE NUMBER: 059858-1
COLLIERS ENGINEERING & DESIGN CT, P.C.
N.Y. C.O.A #: 0017609

HIGHWAY IMPROVEMENT PLANS

FOR

UNDERHILL AVENUE
IMPROVEMENTS
(SEQR # 22-092)

NYS ROUTE 118 (S.H. 148) AT UNDERHILL AVENUE

TOWN OF YORKTOWN
WESTCHESTER COUNTY
NEW YORK

Colliers

Engineering
& Design

WESTCHESTER

400 Columbus Avenue,
Suite 180E
Valhalla, NY 10595
Phone: 914.347.7500
COLLIERS ENGINEERING & DESIGN,
ARCHITECTURE, LANDSCAPE ARCHITECTL
SURVEYING CT, P.C.

SCALE: DATE: DRAWN BY: CHECKED BY:

AS SHOWN 1/8/23 M.J.A. R.G.D.

PROJECT NUMBER: DRAWING NAME:
20006297A R-PL02-NOTE

CHEET TITLE:

GENERAL NOTES

SHEET NUMBER:

GN-01

I. GENERAL

THE CONTRACTOR SHALL MAINTAIN TRAFFIC THROUGHOUT THE LENGTH OF THE CONTRACT IN ACCORDANCE WITH THE REQUIREMENTS OF SECTION 619 OF THE NYSDOT STANDARD SPECIFICATIONS, MUTCD AND THE CONTRACT DOCUMENTS, WHERE PROVIDED, OR AS ORDERED BY ENGINEER (A.O.B.E.)

2. CONSTRUCTION EQUIPMENT & MATERIALS

CONTRACTOR EQUIPMENT, WHEN NOT IN USE, AND MATERIALS AWAITING INSTALLATION SHALL BE PROPERLY STORED, STOCKPILED, AND SITED IN A PROTECTED LOCATION (I.E., BEHIND A PHYSICAL BARRIER OR IN SUCH A MANNER THAT HORIZONTAL CLEARANCE OF AT LEAST 30 FEET IS PROVIDED FROM THE OUTSIDE EDGE OF THE TRAVELED WAY) AND SHALL NOT CONSTITUTE A TRAFFIC HAZARD NOR INTERFERE WITH DRAINAGE COURSES. MATERIALS OR EQUIPMENT SHALL NOT BE LEFT IN FRONT OF OR WITHIN THE DEFLECTION DISTANCE BEHIND GUIDE RAIL AND SAFETY APPURTENANCES SO AS TO COMPROMISE THEIR PERFORMANCE.

3. PARKING VEHICLES

PRIVATE VEHICLES OWNED BY THE CONTRACTOR AND ITS EMPLOYEES SHALL NOT BE PARKED ON THE PAVEMENT OR SHOULDERS, OR ANY OTHER AREAS DEEMED BY THE ENGINEER TO BE HAZARDOUS LOCATIONS.

4. WORK ZONES

WORK ZONES SHALL BE LIMITED TO ONE SIDE OF THE TRAVELED WAY AT A TIME, UNLESS APPROVED BY THE ENGINEER. WORK ZONES ON OPPOSITE SIDES OF THE ROAD SHALL NOT OVERLAP. A WORK ZONE IS DEFINED AS THE AREA IN WHICH TRAFFIC IS RESTRICTED BECAUSE OF CONSTRUCTION ACTIVITIES OR THAT AREA WHICH INVOLVES A DROP-OFF NEXT TO THE PAVEMENT. IN SPECIAL CASES THE LONGITUDINAL DISTANCE BETWEEN WORK ZONES OR THE LENGTH OF THE WORK ZONE MAY BE LIMITED BY THE ENGINEER.

5. OVERLAPPING WORK AREAS

THE CONTRACTOR SHALL COORDINATE HIS WORK SO THERE IS NO CONFLICT IN CONSTRUCTION SIGNING IN OVERLAPPING WORK AREAS AND SO THAT LANE CONTINUITY IS MAINTAINED BETWEEN WORK AREAS. THE CONTRACTOR SHALL COORDINATE HIS WORK WITH ANY OTHER CONTRACTORS, PUBLIC MAINTENANCE, OR UTILITIES COMPANY'S OPERATIONS IN THE AREA TO ENSURE PROPER WORK ZONE TRAFFIC CONTROL.

6. CONES, DRUMS, BARRICADES AND MARKERS

CHANNELIZING DEVICES AND THEIR PLACEMENT SHALL CONFORM WITH THE REQUIREMENTS OF NYSDOT STANDARD SPECIFICATION §619-3.02J AND THE CONTRACT DOCUMENTS. THE CONTRACTOR SHALL MAKE CERTAIN PLACEMENT OF THE CONES, DRUMS, AND MARKERS OR BARRICADES SHALL NOT INTERFERE WITH SIGHT DISTANCE.

7. VEHICLE RESTRICTIONS

WHENEVER CONSTRUCTION CONDITIONS RESTRICT PASSAGE BY OVERSIZED VEHICLES, THE CONTRACTOR SHALL GIVE WRITTEN NOTICE TO THE REGIONAL PERMIT ENGINEER. THE NOTICE SHALL INCLUDE THE EXACT LOCATION, NATURE AND MAXIMUM ALLOWABLE WIDTH, WEIGHT, AND OTHER FACTORS. THIS WRITTEN NOTICE SHALL BE GIVEN ONE WEEK PRIOR TO THE BEGINNING OF THE RESTRICTION. VERBAL NOTICE SHALL BE GIVEN UPON TERMINATION OF THE RESTRICTION.

8. TAPER LENGTHS

TAPER LENGTHS FOR CLOSURES AND LATERAL SHIFTS OF TRAVEL LANES SHALL CONFORM TO STANDARD SHEET 619-011 TABLE 011-02 BASED ON THE PRECONSTRUCTION POSTED SPEED LIMIT AS IDENTIFIED ON SHEET NO. CS-01 OR AS DIRECTED BY THE ENGINEER.

9. TEMPORARY PAVEMENT MARKINGS

THE CONTRACTOR SHALL INSTALL AND MAINTAIN TEMPORARY PAVEMENT MARKINGS IN ACCORDANCE WITH THE CONTRACT DOCUMENTS, USING PATTERNS AND COLORS SHOWN IN THE MUTCD TO ESTABLISH TEMPORARY TRAFFIC PATTERN(S) DURING CONSTRUCTION ON ANY PAVEMENT, INCLUDING MILLED OR GROOVED SURFACE, RESURFACED, NEW PAVEMENT, OR OTHER PAVED SURFACE WITHOUT PAVEMENT MARKINGS, FOR A MAXIMUM OF 14 CALENDAR DAYS. THIS SHALL INCLUDE AT ALL APPROPRIATE LOCATIONS, EDGE LINES, LANE LINES, (SOLID OR BROKEN), CHANNELIZING LINES, DOTTED LINES, PLUS ANY MARKINGS ORDERED BY THE ENGINEER. ALL MARKINGS SHALL BE APPLIED IN ACCORDANCE WITH THE NYSDOT STANDARD SPECIFICATION §619-3.06 AND THE MUTCD AND SHALL INDICATE ACTUAL CONDITIONS AT ALL TIMES.

TRAFFIC PAINT NEED NOT BE REMOVED BEFORE PLACING A SUBSEQUENT PAVEMENT COURSE. REMOVABLE PAVEMENT TAPE. REMOVABLE WET-NIGHT REFLECTIVE TAPE. TEMPORARY OVERLAY MARKERS AND REMOVABLE RAISED PAVEMENT MARKERS SHALL BE REMOVED BEFORE PLACING A SUBSEQUENT PAVEMENT COURSE AT NO ADDITIONAL COST TO THE STATE.

TEMPORARY PAVEMENT MARKING STRIPES SHALL BE A MINIMUM OF 4 INCHES IN WIDTH. TEMPORARY PAVEMENT MARKINGS SHALL BE APPLIED TO A CLEAN, DRY PAVEMENT IN ACCORDANCE WITH THE MANUFACTURER'S RECOMMENDATIONS. HATCH LINES AND SYMBOLS WILL NOT BE REQUIRED AS TEMPORARY PAVEMENT MARKINGS UNLESS REQUIRED BY THE CONTRACT DOCUMENTS.

10. SIGNS

THE CONTRACTOR SHALL INSTALL AND MAINTAIN CONSTRUCTION SIGNS IN GOOD CONDITION TO ADEQUATELY AND SAFELY INFORM AND DIRECT MOTORISTS, BICYCLISTS, AND PEDESTRIANS. EXISTING AND CONSTRUCTION SIGNS SHALL INDICATE ACTUAL ROADWAY CONDITIONS, AND SHALL BE COVERED, UNCOVERED, CHANGED, RELOCATED, OR REMOVED IMMEDIATELY TO REFLECT CURRENT CONDITIONS AT ALL TIMES AND AT THE DIRECTION OF THE ENGINEER. CONSTRUCTION SIGNS SHALL BE COVERED OR REMOVED WHEN THEY NO LONGER INDICATE ACTUAL CONDITIONS. THE CONTRACTOR SHALL PROVIDE MEASURES TO PROTECT WORKERS DURING PLACEMENT AND REMOVAL OF CONSTRUCTION SIGNS ADEQUATE FOR THE PREVAILING SPEED, VOLUME OF TRAFFIC AND ROADWAY GEOMETRY WHERE THE WORK IS TO OCCUR. SUCH PROTECTION MAY INCLUDE, BUT IS NOT LIMITED TO, THE USE OF FLAGGERS, SPOTTERS, AND SHADOW VEHICLES EQUIPPED WITH TRUCK-MOUNTED OR TRAILER MOUNTED ATTENUATORS. WHERE PEDESTRIAN ACCESS IS PROHIBITED, WORKERS SHALL NOT CROSS OR ENTER TRAVEL LANES OPEN TO TRAFFIC.

ALL SIGNS SHALL BE KEPT CLEAN, MOUNTED AT THE REQUIRED HEIGHT ON ACCEPTABLE SUPPORTS AND INSTALLED IN THE PROPER POSITION, ALIGNMENT, AND ORIENTATION SO AS TO GIVE MAXIMUM VISIBILITY. CONSTRUCTION SIGNS WILL BE EVALUATED FOR ACCEPTABILITY IN ACCORDANCE WITH THE AMERICAN TRAFFIC SAFETY SERVICES ASSOCIATION (ATSSA) QUALITY GUIDELINES FOR WORK ZONE TRAFFIC CONTROL DEVICES. WHEN AUXILIARY PANELS ARE MOUNTED ABOVE OR BELOW A WARNING OR REGULATORY SIGN, THEY SHALL NOT COVER ANY PART OF THE WARNING OR REGULATORY SIGN. SIGNS SHALL BE PLACED SO THAT EACH SIGN IS VISIBLE AT NIGHT, AT THE DESIRED DISTANCE, WITHOUT BEING OBSCURED BY ANOTHER SIGN, EXISTING FEATURES ON THE HIGHWAY, OR FOLIAGE. THE FACES OF STORED SIGNS SHALL NOT BE VISIBLE TO TRAFFIC IN ANY DIRECTION, REGARDLESS OF THE ORIENTATION OF THE SIGN. SIGN PANELS, MOUNTINGS, AND SIGN COVERINGS SHALL BE IN ACCORDANCE WITH NYSDOT STANDARD SPECIFICATIONS §619-3.02H.

11. GUIDE RAIL WORK

ANY FREE ENDS OF GUIDE RAIL SHALL BE PROTECTED FROM IMPACT AT THE DIRECTION OF THE ENGINEER. THE COST OF TEMPORARILY TERMINATING GUIDE RAIL SHALL BE INCLUDED IN THE BASIC WORK ZONE TRAFFIC CONTROL ITEM. WHEN CONSTRUCTION OPERATIONS REQUIRE THE TEMPORARY REMOVAL OF GUIDE RAIL OR MEDIAN BARRIER, OR WHEN EXISTING RAIL WILL BE REMOVED AND REPLACED WITH NEW RAIL, THE CONTRACTOR SHALL SCHEDULE OPERATIONS TO MINIMIZE THE TIME PERIOD THAT RAIL IS NOT INSTALLED. GUIDE RAIL OR MEDIAN BARRIER SHALL BE REPLACED, OR THE LOCATION OTHERWISE PROTECTED WITHIN 14 CALENDAR DAYS.

DURING NON-WORK HOURS WHEN TRAFFIC IS BEING MAINTAINED ON THE FACILITY, ALL TEMPORARY ENDS (FREE ENDS) OF GUIDE RAIL AND MEDIAN BARRIER SHALL BE TEMPORARILY TERMINATED AND MARKED WITH A CHANNELIZING DRUM OR OBJECT MARKER EQUIPPED WITH A TYPE A FLASHING WARNING LIGHT. CORRUGATED BEAM GUIDE RAIL AND MEDIAN BARRIER, AND HEAVY-POST, BLOCKED-OUT, CORRUGATED BEAM GUIDE RAIL AND MEDIAN BARRIER SHALL BE TEMPORARILY TERMINATED BY HAVING THE EXPOSED ENDS (FREE ENDS) DROPPED TO THE GROUND AND PINNED. THE APPROACH ENDS OF BOX BEAM GUIDE RAIL AND MEDIAN BARRIER SHALL BE TEMPORARILY TERMINATED WITH BOX BEAM GUIDE RAIL END ASSEMBLIES UTILIZING TWO SPLICE PLATES AND THE PROPER NUMBER OF BOLTS PER CONNECTION. NO POSTS FOR ANCHORAGES WILL BE REQUIRED. SPECIAL TEMPORARY SPLICE PLATES ARE REQUIRED TO ADAPT BOX BEAM GUIDE RAIL END ASSEMBLIES TO BOX BEAM MEDIAN BARRIERS.

DURING ANY OVERNIGHT PERIOD WHEN EXISTING GUIDE RAIL OR MEDIAN BARRIER IS TEMPORARILY REMOVED, THE CONTRACTOR SHALL INSTALL CHANNELIZING DEVICES IN THE LOCATION WHERE THE GUIDE RAIL OR MEDIAN BARRIER WAS REMOVED IN ACCORDANCE WITH NYSDOT STANDARD SPECIFICATIONS §619-3.02J.6.

FOR EACH CALENDAR DAY WHICH THERE ARE SUBSTANTIAL DEFICIENCIES IN COMPLIANCE WITH THE REQUIREMENTS OF THIS SECTION, NO PAYMENT WILL BE MADE UNDER THE BASIC WORK ZONE TRAFFIC CONTROL ITEM.

12. PRELIMINARY WORK

PRIOR TO THE START OF ANY CONSTRUCTION PHASE, ALL PROPOSED WORK ZONE TRAFFIC CONTROL RELATED WORK FOR THAT PHASE, AS DETERMINED BY THE ENGINEER, SHALL BE COMPLETE. THIS INCLUDES WHERE APPLICABLE, ALL SIGNS, SIGNALS, PAVEMENT MARKINGS, BARRIERS, DELINEATION (CONES, DRUMS, ETC.) PAVEMENT MODIFICATION AND ANY OTHER RELATED WORK

IN THE EVENT THE CONTRACTOR SHUTS DOWN HIS OPERATION FOR THE WINTER MONTHS, THE ENTIRE HIGHWAY SYSTEM SHALL BE OPENED TO TRAFFIC. ALL EXISTING SIGNS SHALL BE RESTORED TO THEIR ORIGINAL CONDITION AND/OR LOCATION AT THE DIRECTION OF THE ENGINEER. ALL CONSTRUCTION SIGNS SHALL BE REMOVED OR COVERED.

ROADWAY AREAS TEMPORARILY CLOSED FOR TRENCH, CULVERT OR CONDUIT EXCAVATION SHALL BE REOPENED AT THE END OF THE WORK SHIFT. WHEN WORK IS NOT IN PROGRESS ALL OPENINGS IN THE ROADWAY SHALL BE COVERED WITH ANCHORED STEEL PLATES OR SHALL BE BACKFILLED IN ACCORDANCE WITH § 680-3.09 TO A DEPTH OF 3 INCHES BELOW THE ADJACENT UNEXCAVATED AREA OR TO A DEPTH AS DIRECTED BY THE ENGINEER. THE TEMPORARY RESTORATION SHALL BE COMPLETED WITH A LAYER OF PLANT BITUMINOUS MATERIAL UP TO THE LEVEL OF THE ADJACENT UNEXCAVATED AREA TO THE SATISFACTION OF THE ENGINEER. THE TEMPORARY RESTORATION SHALL BE MAINTAINED UNTIL ITS REMOVAL AT NO ADDITIONAL COST TO THE STATE/TOWN. ANY RE-EXCAVATION OF TEMPORARY RESTORATION AREAS SHALL BE INCLUDED IN THE PRICE BID FOR RESPECTIVE EXCAVATION ITEM WITH NO EXTRA PAYMENT.

IF STEEL PLATES ARE USE, THE CONTRACTOR SHALL SUBMIT THE PROPOSED METHOD OF ANCHORING THE STEEL PLATES TO THE ENGINEER FOR HIS APPROVAL PRIOR TO THE STARTING OF ANY ROADWAY EXCAVATION. THE STEEL PLATES SHALL BE RAMPED WITH A BITUMINOUS MATERIAL PRIOR TO OPENING

THE CONTRACTOR MUST NOTIFY PROPERTY OWNERS AT LEAST ONE DAY IN ADVANCE OF CLOSING DRIVEWAYS AND HAS THE RESPONSIBILITY TO MAINTAIN SAFE AND PROPER ACCESS TO BUILDINGS IN THE VICINITY OF CONSTRUCTION. THE CONTRACTOR SHALL MAINTAIN ACCESS TO AND FROM FIRE HOUSES AT ALL TIMES.

THE CONTRACTOR SHALL PROVIDE FLAGGERS WHERE SIGHT DISTANCES ARE IMPAIRED BY HIS OPERATION OR AS DIRECTED BY THE ENGINEER.

THE CONTRACTOR SHALL NOT WORK ON BOTH SIDES OF THE ROADWAY AT THE SAME TIMES.

THE CONTRACTOR SHALL SCHEDULE HIS OPERATIONS TO MINIMIZE THE INTERRUPTION OF PEDESTRIAN TRAFFIC. ANY CLOSURE OF PEDESTRIAN ROUTES SHALL BE ACCOMPANIED BY A PEDESTRIAN DETOUR IN ACCORDANCE WITH THE CONTRACT DOCUMENTS OR AS DIRECTED BY THE ENGINEER.

IN ACCORDANCE WITH NYSDOT STANDARD SPECIFICATION §107-05.F THE CONTRACTOR SHALL IDENTIFY, GUARD AND PROTECT RESTRICTED AREAS SUCH AS OPEN AND UNATTENDED EXCAVATIONS, AREAS SUBJECT TO FALLING DEBRIS AND OTHER POTENTIALLY HAZARDOUS LOCATIONS IN AND ADJACENT TO AREAS LAWFULLY FREQUENTED BY ANY PERSON IN ACCORDANCE WITH THE REQUIREMENTS OF 29 CFR 1926 SUBPART G. PAYMENT FOR INSTALLATION AND REMOVAL OF THIS ITEM SHALL BE INCLUDED THE BASIC WORK ZONE TRAFFIC CONTROL ITEM.

14. FLAGGER

FLAGGING, INCLUDING FLAGGER TRAINING, FLAGGER EOUIPMENT, AND OPERATIONAL CONTROL. SHALL BE PROVIDED IN ACCORDANCE WITH STANDARD SPECIFICATION §619-3.02L. ALL COSTS ASSOCIATED WITH FLAGGING SHALL BE INCLUDED IN THE BASIC WORK ZONE TRAFFIC CONTROL

15. LANE CLOSURES

THE CONTRACTOR SHALL MAINTAIN AT LEAST ONE LANE OF TRAFFIC IN EACH DIRECTION AND SHALL PROVIDE FLAGGERS AS NECESSARY AS DIRECTED BY THE ENGINEER. THE MINIMUM WIDTH OF A TRAVELED LANE SHALL BE 10 FEET UNLESS OTHERWISE SHOWN IN THE CONTRACT DOCUMENTS.

AT THE SITE OF PAVING OR OTHER WORK OPERATION REQUIRING TEMPORARY CLOSURE OF PORTIONS OF THE TRAVELED WAY, THE CONTRACTOR SHALL MAINTAIN AT LEAST ONE LANE OF TRAFFIC AND SHALL PROVIDE FLAGGERS TO CONTROL TRAFFIC MOVEMENT.

THE CONTRACTOR SHALL SCHEDULE HIS WORK SO THAT ALL TRAVEL LANES IN EACH DIRECTION ARE OPEN WHEN THE CONTRACTOR'S OPERATIONS ARE CLOSED DOWN OR SUBSTANTIALLY CLOSED DOWN, AND DURING WEEKDAY HOURS OF 6:30 AM TO 9:00 AM AND 3:30 PM TO 6:00 PM. THE CONTRACTOR SHALL CONTACT THE TRANSPORTATION MANAGEMENT CENTER AT 914-742-6100 ONE WEEK PRIOR TO ANY POSSIBLE LANE CLOSURE.

THE CONTRACTOR SHALL ALSO BE AWARE OF THE STATE'S LANE CLOSURE RESTRICTIONS FOR MAJOR HOLIDAYS. CONSTRUCTION ACTIVITIES THAT WILL RESULT IN TEMPORARY LANE CLOSURES SHALL BE SUSPENDED TO MINIMIZE TRAVEL DELAYS ASSOCIATED WITH ROAD WORK FOR MAJOR HOLIDAYS AS

HOLIDAY	FALLS ON	TEMPORARY LANE CLOSURES ARE NOT ALLOWED FROM
NEW YEAR'S DAY INDEPENDENCE DAY	SUNDAY OR MONDAY	6:00 AM FRIDAY BEFORE TO 10:00 AM TUESDAY AFTER
MEMORIAL DAY	TUESDAY	6:00 AM SATURDAY BEFORE TO 10:00 AM WEDNESDAY AFTER
LABOR DAY	WEDNESDAY	6:00 AM TUESDAY BEFORE TO 10:00 AM THURSDAY AFTER
	THURSDAY	6:00 AM WEDNESDAY TO 10:00 AM MONDAY AFTER
	FRIDAY OR SATURDAY	6:00 AM THURSDAY BEFORE TO 10:00 AM MONDAY AFTER
CHRISTMAS DAY	SUNDAY OR MONDAY	6:00 AM FRIDAY BEFORE TO 10:00 AM TUESDAY AFTER
	TUESDAY	6:00 AM FRIDAY BEFORE TO 10:00 AM WEDNESDAY AFTER
	WEDNESDAY	6:00 AM SATURDAY BEFORE TO 10:00 AM THURSDAY AFTER
	THURSDAY	6:00 AM WEDNESDAY TO 10:00 AM MONDAY AFTER
	FRIDAY OR SATURDAY	6:00 AM THURSDAY BEFORE TO 10:00 AM MONDAY AFTER
THANKSGIVING DAY	THURSDAY	6:00 AM WEDNESDAY BEFORE TO 10:00 AM MONDAY AFTER

16. PUBLIC INGRESS AND EGRESS

AS SPECIFIED IN THE CONTRACT DOCUMENTS, THE CONTRACTOR SHALL PROVIDE PROPERTY OWNERS WITH PROPER ACCESS TO AND MINIMUM WIDTHS FOR THEIR DRIVEWAYS AND SHALL MAINTAIN THEM THROUGH ALL PHASES OF WORK. DRIVEWAYS SHALL BE DELINEATED IN ACCORDANCE WITH NYSDOT STANDARD SPECIFICATIONS §619-3.02] OR AS DIRECTED BY THE ENGINEER.

WHERE DIRECT ACCESS TO DRIVEWAYS IS NOT POSSIBLE DUE TO NECESSARY CONSTRUCTION OPERATIONS, THE CONTRACTOR SHALL PLAN ALTERNATE MEANS OF ACCESS AND SUBMIT SUCH A PLAN TO THE ENGINEER FOR APPROVAL BEFORE OPERATIONS COMMENCE. COST FOR THIS WORK SHALL BE INCLUDED IN THE BASIC WORK ZONE TRAFFIC CONTROL ITEM. ACCESS SHALL BE PROVIDED TO ALL DRIVEWAYS BEHIND TEMPORARY CONCRETE BARRIER WHEN USED AS DIRECTED BY THE ENGINEER. SIGNS DENOTING COMMERCIAL ESTABLISHMENTS SHALL BE PROVIDED AND PLACED NEXT TO THESE DRIVEWAYS. SIGNS SHALL BE AS APPROVED BY THE ENGINEER.

THE COST FOR ALL DELINEATION AND CHANNELIZING DEVICES (CONES, DRUMS, ETC.) SHALL BE IN THE BASIC WORK ZONE TRAFFIC CONTROL ITEM.

17. CONSTRUCTION INGRESS AND EGRESS

THE CONTRACTOR SHALL KEEP TO A MINIMUM MOVEMENT IN AND OUT OF DESIGNATED TRAVEL LANES WITH CONSTRUCTION VEHICLES AND EQUIPMENT. SEE ALSO NYSDOT STANDARD SPECIFICATION §619-3.02F.

18. DELINEATORS

SINGLE UNIT LARGE DELINEATORS AT 40-FOOT SPACING SHALL BE INSTALLED WITHIN THE LIMITS OF THE WORK ZONE WHERE EXISTING TRAVEL LANE WIDTHS ARE REDUCED AND TRAFFIC IS ADJACENT TO TEMPORARY POSITIVE BARRIER, GUIDE RAILING, OR BOTH. WHITE DELINEATORS SHALL BE DISPLAYED ON THE RIGHT SIDE OF THE TRAVELED WAY AND YELLOW SHALL BE DISPLAYED ON THE LEFT. TEMPORARY POSITIVE BARRIER SECTIONS SEPARATING TWO-WAY TRAFFIC SHALL HAVE YELLOW DELINEATORS INSTALLED BACK-TO-BACK. DELINEATORS, POSTS, AND BRACKETS SHALL BE FURNISHED AND INSTALLED IN ACCORDANCE WITH THE NYSDOT STANDARD SPECIFICATIONS AND CURRENT 646 STANDARD SHEETS. PAYMENT WILL BE MADE UNDER ITEM 646.23, ITEM 646.31, AND ITEM 646.50. UPON COMPLETION OF WORK. THE CONTRACTOR SHALL REMOVE AND DISPOSE OF ALL POSTS INSTALLED FOR THE WORK ZONE AT NO ADDITIONAL COST TO THE STATE/TOWN. REMOVED POSTS SHALL BECOME THE PROPERTY OF THE CONTRACTOR AND SHALL BE REMOVED FROM THE WORK SITE IN A NEAT MANNER.

19. CHANGES TO WORK ZONE TRAFFIC CONTROL PLAN

THE CONTRACTOR MUST SUBMIT TO THE ENGINEER. IN WRITING, PROPOSED REVISIONS TO THE WORK ZONE TRAFFIC CONTROL PLAN FOR REVIEW AND APPROVAL A MINIMUM OF SEVEN (7) CALENDAR DAYS PRIOR TO THE PLANNED IMPLEMENTATION OF SUCH PROPOSED REVISIONS, EXCEPT FOR CHANGES THAT ALTER THE BASIC CONCEPT OR SCOPE OF THE WORK ZONE TRAFFIC CONTROL PLAN. SUCH CHANGES TO THE BASIC CONCEPT OR SCOPE MUST BE SUBMITTED TO THE ENGINEER FOR APPROVAL A MINIMUM OF THIRTY (30) CALENDAR DAYS PRIOR TO IMPLEMENTATION OF SUCH REVISIONS.

20. REQUIREMENTS FOR PORTABLE VARIABLE MESSAGE SIGNS

WHERE TRAFFIC WILL BE RIDING ON MILLED OR GROOVED PAVEMENT AND THE POSTED SPEED LIMIT I 40 MPH OR GREATER, THE CONTRACTOR SHALL PLACE A PORTABLE VARIABLE MESSAGE SIGN IN ADVANCE OF THE MILLED OR GROOVED PAVEMENT WARNING MOTORCYCLE RIDERS TO USE CAUTION. PAYMENT SHALL BE MADE UNDER ITEM 619.110512.

21. ENFORCEABLE REDUCED REGULATORY SPEED LIMIT AND ADVISORY SPEED SIGNS ALL REDUCTIONS IN REGULATORY SPEED LIMITS AND ADVISORY SPEEDS ASSOCIATED WITH WORK ZONES MUST BE APPROVED, IN WRITING AND IN ADVANCE, BY THE REGIONAL TRAFFIC ENGINEER OR HIS/HER DESIGNEE.

THE CONTRACTOR MAY REQUEST APPROVAL OF REDUCED REGULATORY SPEED LIMITS AND ADVISORY SPEEDS FOR SHORT-TERM STATIONARY WORK ZONE WHERE SUCH PROVISIONS ARE NOT OTHERWISE SPECIFIED IN THE CONTRACT DOCUMENTS. REQUEST MUST BE SUBMITTED THROUGH THE ENGINEER TO THE REGIONAL TRAFFIC ENGINEER A MINIMUM OF FOURTEEN (14) CALENDAR DAYS IN ADVANCE OF THE SCHEDULED IMPLEMENTATION OF ANY WORK ZONE CONTAINING THE REQUESTED REDUCED REGULATORY SPEED LIMITS AND/OR ADVISORY SPEEDS.

GENERALLY, TO QUALIFY FOR A REDUCTION IN REGULATORY SPEED LIMIT AT A SHORT-TERM STATIONARY WORK ZONE, THE WORK ZONE MUST CONTAIN AN ACTIVITY AREA THAT IS GREATER THAN 1/2 MILE ON A HIGHWAY WITH A PRECONSTRUCTION POST SPEED LIMIT OF 55 MPH OR GREATER AND BE OF A DURATION EXCEEDING FOUR (4) HOURS WHERE WORKERS ARE ON FOOT IN THE ACTIVITY AREA AND ARE NOT PREDOMINANTLY SEPARATED FROM TRAFFIC BY A POSITIVE BARRIER. IF APPROVED, THE REDUCED REGULATORY SPEED SHALL BE NO MORE THAN 10 MPH BELOW THE PRECONSTRUCTION POSTED SPEED LIMIT. IN LONG WORK ZONES WITH SEVERAL INTERMITTENT ACTIVITY AREAS. THE PRECONSTRUCTION POSTED SPEED LIMIT SHALL BE RESTORED BETWEEN ACTIVITY AREAS THAT ARE SEPARATED BY TWO (2) OR MORE MILES.

TO QUALIFY FOR AN ADVISORY SPEED AT A SHORT-TERM STATIONARY WORK ZONE, HAZARDOUS WORK ZONE CONDITIONS MUST EXIST THAT WARRANT A LOCALIZED REDUCTION IN SPEED. SUCH CONDITIONS INCLUDE, BUT ARE NOT LIMITED TO, NARROW LANES, BUMPS, GROOVED PAVEMENT, LOW OR NO SHOULDERS, ROADWAY DROP-OFFS, POOR ROADWAY SURFACE, POOR SIGHT DISTANCE, GEOMETRIC CONSTRAINTS AND EXPOSED WORKERS ADJACENT TO ACTIVE TRAFFIC.

IF A REDUCTION IN REGULATORY SPEED LIMIT AND/OR ADVISORY SPEED IS APPROVED, THE CONTRACTOR SHALL FURNISH, INSTALL AND MAINTAIN REGULATORY SPEED LIMIT AND/OR ADVISORY SPEED SIGNS IN ACCORDANCE WITH NYSDOT STANDARD SPECIFICATION §619-3.02.H.4 & 5 AND THE MUTCD, AND AS DIRECTED BY THE ENGINEER. THESE SIGNS SHALL BE USED IN CONJUNCTION WITH THE LANE CLOSURE OR OTHER WORK ZONE TRAFFIC CONTROL SIGNS AND SHALL BE COVERED OR REMOVED WHEN WORK ZONE TRAFFIC CONTROL PATTERN IS REMOVED EACH DAY. ANY EXISTING REGULATORY SPEED LIMIT SIGNS WITHIN THE WORK ZONE SHALL BE COVERED DURING THE TIME THE WORK ZONE TRAFFIC CONTROL IS IN PLACE AND UNCOVERED WHEN THE WORK ZONE TRAFFIC CONTROL PATTERN IS REMOVED.

REDUCTIONS IN REGULATORY SPEED LIMITS AND ADVISORY SPEEDS SHALL NOT BE PERMITTED FOR MOBILE OR SHORT DURATION WORK ZONES.

THE COST OF UTILIZING APPROVED REGULATORY OR ADVISORY SPEED ZONE SIGNS, AND COVERING EXISTING SIGNS, SHALL BE INCLUDED IN THE PRICE BID FOR BASIC WORK ZONE TRAFFIC CONTROL.

SPECIAL NOTES

I. WORK ZONE TRAFFIC CONTROL IS THE RESPONSIBILITY OF THE CONTRACTOR. ALL SUBCONTRACTORS WORKING FOR THE CONTRACTOR MUST HAVE A COPY OF THE HIGHWAY WORK PERMIT ON THE SITE AND MUST BE FAMILIAR WITH THE TRAFFIC CONTROL REQUIREMENTS. IT IS STRONGLY ADVISED THAT A "TAILGATE" SAFETY MEETING WITH EACH WORK CREW BE INITIATED BEFORE THE START OF ALL WORK

- 2. WORK ZONE TRAFFIC CONTROL SCHEMES MUST BE IN PLACE AND MAINTAINED THROUGHOUT THE DURATION OF WORK.
- ALL WORKERS WITHIN THE HIGHWAY ROW SHALL WEAR HIGH-VISIBILITY APPAREL MEETING THE ANSI 107 CLASS II STANDARDS AND AN OSHA APPROVED HARD HAT AS SPECIFIED IN NYSDOT STANDARD SPECIFICATIONS §107-05.A.
- 4. AT THE START OF WORK ON THE PROJECT ALL WORK ZONE TRAFFIC CONTROL DEVICES WILL BE EVALUATED BY THE ENGINEER FOR ACCEPTABILITY IN ACCORDANCE WITH THE AMERICAN TRAFFIC SAFETY SERVICES ASSOCIATION (ATSSA) QUALITY GUIDELINES FOR WORK ZONE TRAFFIC CONTROL DEVICES. THESE DEVICES SHALL NOT BE ALLOWED TO FALL BELOW THE "MARGINAL" CONDITION AT ANY TIME DURING THE LIFE OF THE PROJECT. FADED AND DETERIORATED PANELS AND NON-STANDARD LEGENDS ARE NOT ACCEPTABLE
- . FLAGGER SIGNS ARE TO BE USED ONLY WHEN A FLAGGER IS ACTUALLY PRESENT AND VISIBLE TC THE MOTORIST. THEY SHALL BE COVERED OR REMOVED AT ALL OTHER TIMES. STOP/SLOW PADDLES ARE REQUIRED. THE COST OF FLAGGER SIGNS AND STOP/SLOW PADDLES SHALL BE INCLUDED IN THE WORK ZONE TRAFFIC CONTROL ITEM.
- FLEXIBLE PANEL AND LIGHTWEIGHT RIGID PANEL SIGNS SHALL BE MOUNTED AT THE SAME HEIGHT AS RIGID PANEL SIGNS, EXCEPT THEY MAY BE MOUNTED, WHEN APPROVED BY THE ENGINEER, AS LOW AS I FOOT WHEN ALL CONDITIONS OF NYSDOT STANDARD SPECIFICATION §619-302H.I ARE
- . NO WORK WITHIN THE STATE R.O.W. SHALL COMMENCE WITHOUT A PRE-CONSTRUCTION MEETING, WITH NYSDOT REPRESENTATIVES PRESENT.
- 8. AS-BUILT PLANS SHALL BE SENT TO THE NYSDOT IN HARD COPY AND ELECTRONIC FORMAT COMPATIBLE WITH THE SYSTEM CURRENTLY USED BY NYSDOT.
- 9. The permittee is responsible for hiring an inspector to be onsite during all CONSTRUCTION OPERATIONS ON THE STATE R.O.W. TO ENSURE ALL WORK IS PERFORMED IN ACCORDANCE WITH NYSDOT SPECIFICATIONS. THE INSPECTOR MUST BE EXPERIENCED IN NYSDOT WORK AND SHALL BE APPROVED BY THE STATE PRIOR TO HIRING. THE PERMITTEE IS RESPONSIBLE FOR REIMBURSING THE COST OF SITE VISITS BY A NYSDOT REPRESENTATIVE (RESIDING PERMIT ENGINEER) AS NEEDED.

PAVEMENT EDGE DROP-OFF PROTECTION

A DROP-OFF IS AN ABRUPT DIFFERENCE IN SURFACE ELEVATION OF MORE THAN 2 INCHES AT APPROXIMATELY IV:3H OR STEEPER. IN THE ABSENCE OF ADEQUATE TRAFFIC CONTROL PLANS IN THE CONTRACT DOCUMENTS, THE CONTRACTOR SHALL SUBMIT ALTERNATE TRAFFIC CONTROL PLANS TO THE ENGINEER FOR APPROVAL AT LEAST 30 CALENDAR DAYS PRIOR TO PROPOSED WORK WHICH WILL CREATE A DROP-OFF OF OVER 24 INCHES WITHIN 10 FEET FROM THE EDGE OF THE TRAVELED WAY FOR DURATIONS LONGER THAN ONE SHIFT.

THE CONTRACTOR SHALL PROVIDE PAVEMENT EDGE DROP-OFF PROTECTION IN ACCORDANCE WITH TABLE 619-3 PAVEMENT EDGE DROP-OFF PROTECTION. CHANNELIZING DEVICES USED TO MARK DROP-OFFS SHALL BE PLACED, AS PRACTICABLE, TO NOT REDUCE THE AVAILABLE TRAVEL LANE WIDTH, AT THE ELEVATION OF THE OPEN TRAVEL LANE IN ORDER TO PROVIDE MAXIMUM TARGET VALUE AND VISIBILITY FOR MOTORISTS.

A DROP-OFF OF GREATER THAN 24 INCHES WITHIN 10 FEET FROM THE EDGE OF THE TRAVELED WAY TO REMAIN AT THE END OF THE WORK SHIFT SHALL BE SEPARATED FROM TRAFFIC WITH TEMPORARY OR PERMANENT BARRIER. FOR POSTED SPEED LIMIT OF 45 MPH AND LESS, A DROP-OFF OF GREATER THAN 24 INCHES WITHIN 10 FEET FROM THE EDGE OF THE TRAVELED WAY THAT IS 100 FEET OR LESS IN LENGTH WILL BE ALLOWED WITH CHANNELIZING DEVICES CONSISTING OF DRUMS, EXTRA TALL CONES, OR OVERSIZED VERTICAL PANELS ONLY AT A MAXIMUM SPACING OF 20 FEET FOR SHORT DURATIONS NOT TO EXCEED ONE WORK SHIFT.

UNLESS OTHERWISE NOTED IN THE CONTRACT DOCUMENTS, THE CONTRACTOR SHALL BEGIN WORK TO ELIMINATE UNPROTECTED DROP-OFFS CREATED BY CONTRACT WORK WITHIN 7 CALENDAR DAYS OF THE COMPLETION OF THE WORK CREATING THE DROP-OFF. WORK SHALL CONTINUE IN A TIMELY MANNER UNTIL SUCH TIME AS THE UNPROTECTED DROP-OFF CONDITION IS ELIMINATED. WHERE PAVEMENT EDGE LINES ARE NOT PROVIDED, CHANNELIZING DEVICES SHALL BE PRECEDED BY A NO SHOULDER (W8-23) SIGN, REPEATED AT ALL RAMPS AND ROADWAY INTERSECTIONS. SIGNS SHALL BE REPEATED EVERY 1/2 MILE AND SUPPLEMENTED WITH A NEXT [X] MILES (W7-3AP) PLAQUE WHERE APPLICABLE.

WHERE PAVEMENT EDGE LINES ARE PROVIDED, CHANNELIZING DEVICES SHALL BE PRECEDED BY SHOULDER DROP-OFF (W8-17) SIGNS, REPEATED AT ALL RAMPS AND ROADWAY INTERSECTIONS SIGNING SHALL BE REPEATED EVERY 1/2 MILE AND SUPPLEMENTED WITH NEXT [X] MILES (W7-3AP) PLAQUE WHERE APPLICABLE.

TABLE 619-3 PAVEMENT EDGE DROP-OFF PROTECTION

DROP-OFF HEIGHT BODGE LINE PAVEMENT MARKINGS DRUM SPACING PANEL SPACING (FT.)		TUBULAR MARKER SPACING (FT.)	TALL CONE SPACING (FT.)	SIGNS		
	OR WITHIN SH					
2 - 6 IN.	YES YES	100	100	N/A	N/A	SHOULDER DROP-OFF
2 - 6 IIN.	NO	40	40	N/A	N/A	NO SHOULDER
6 - 24 IN.	YES	40	40	N/A	N/A	SHOULDER DROP-OFF
0 - 2 1 IIV.	NO	20	20	N/A	N/A	no shoulder
1ORE THAN 4 F	T. FROM TRAVEL	LANE				
2 - 6 IN.	YES	200	200	100	100	SHOULDER DROP-OFF
2 - 0 IIV.	NO	100	100	40	40	no shoulder
6 - 24 IN.	YES	40	40	N/A	N/A	SHOULDER DROP-OFF
0 - 2 1 IIV.	NO	40	40	N/A	N/A	no shoulder
ROP-OFF OU	TSIDE OF SHOU	JLDER AREA		1	1	1
HOULDER WID)TH ≤ 4 FT.					
2 - 6 IN.	YES	100	100	N/A	N/A	SHOULDER DROP-OFF
2 - 0 IIN.	NO	100	100	N/A	N/A	NO SHOULDER
6 - 24 IN.	YES	40	40	N/A	N/A	SHOULDER DROP-OFF
0 - 2 1 IIV.	NO	40	40	N/A	N/A	NO SHOULDER
HOULDER WID	TH > 4 FT.	•				
2 - 6 IN.	YES	200	200	100	100	SHOULDER DROP-OFF
Z - O IIV.	NO	100	100	40	40	NO SHOULDER
6 - 24 IN.	YES	100	100	40	40	SHOULDER DROP-OFF
6 - 4 1 IIN.	NO	40	40	N/A	N/A	NO SHOULDER

Colliers

Engineering & Design

www.colliersengineering.con

nom the services were contracted or to whom it is certified. This drawing ma copied, reused, disclosed, distributed or relied upon for any other puri



EXCAVATORS, DESIGNERS, OR ANY PERS PREPARING TO DISTURB THE EARTH SURFACE ANYWHERE IN ANY STATE

FOR STATE SPECIFIC DIRECT PHONE NUMBERS VISIT: WWW.CALL811.COM

	REVISED PER NYSDOT COMMENTS RECEIVED 3/19/24	REVISED PER NYSDOT 4/25/24 COMMENTS.	REVISED PER NYSDOT 5/2/24 COMMENTS.	REVISED TRAFFIC SIGNAL PLAN SHEETS PER NYSDOT SIGNAL GROUP 5/23/24 EMAIL COMMENTS.	REVISED PER NYSDOT 7/1/24 COMMENTS.	REVISED PER NYSDOT 7/31/24 COMMENTS.	QC REVIEW	REVISED PER NYSDOT 8/30/24 COMMENTS.	REVISED PER NYSDOT 9/20/24 COMMENTS. FINAL SET FOR PERMITTING.	
DESCRIPTION	REVISED PER NYS	REVISED PER NYS	REVISED PER NYS	REVISED TRAFFIC SIGNAL GROUP 5	REVISED PER NYS	REVISED PER NYS	REVISED PER QA/QC REVIEW	REVISED PER NYS	REVISED PER NYSDOT 9/20/7 FINAL SET FOR PERMITTING.	•
DRAWN BY	M.J.A.	J.F.M.	M.J.A.	M.J.A.	M.J.A.	M.J.A.	RGD	M.J.A.	M.J.A.	
DATE	4/3/24	4/26/24	5/14/24	5/24/24	7/1/24	8/7/24	8/15/24	9/12/24	9/23/24	
REV	1	2	3	4	5	9	7	8	6	



Philip John Grealy NEW YORK LICENSED PROFESSIONAL ENGINEER LICENSE NUMBER: 059858-1 COLLIERS ENGINEERING & DESIGN CT, P.C. N.Y. C.O.A #: 0017609

HIGHWAY IMPROVEMENT PLANS

UNDERHILL AVENUE **IMPROVEMENTS** (SEQR # 22-092)

NYS ROUTE 118 (S.H. 148) AT UNDERHILL AVENUE

TOWN OF YORKTOWN WESTCHESTER COUNTY **NEW YORK**

Colliers Engineering & Design

400 Columbus Avenue, Suite 180E Valhalla, NY 10595 Phone: 914.347.7500 ARCHITECTURE, LANDSCAPE ARCHITECT SURVEYING CT, P.C.


WESTCHESTER

M.J.A. RAWING NAME R-PL02-NOTE 20006297A

GENERAL NOTES

GN-02

INAUTHORIZED ALTERATION OR ADDITION TO A SURVEY OR ENGINEERING MAP BEARING A LICENSED LAND SURVEYOR OR PROFESSIONAL ENGINEER IS A VIOLATION OF SECTION 7209, SUB-DIVISION 2, OF THE NEW YORK STATE EDUCATION LAW. INLY MAPS WITH THE LAND SURVEYOR OR PROFESSIONAL ENGINEER'S SEAL ARE GENUINE TRUE AND CORRECT COPIES OF THE LAND SURVEYOR OR PROFESSIONAL ENGINEER'S ORIGINAL WORK AND OPINION

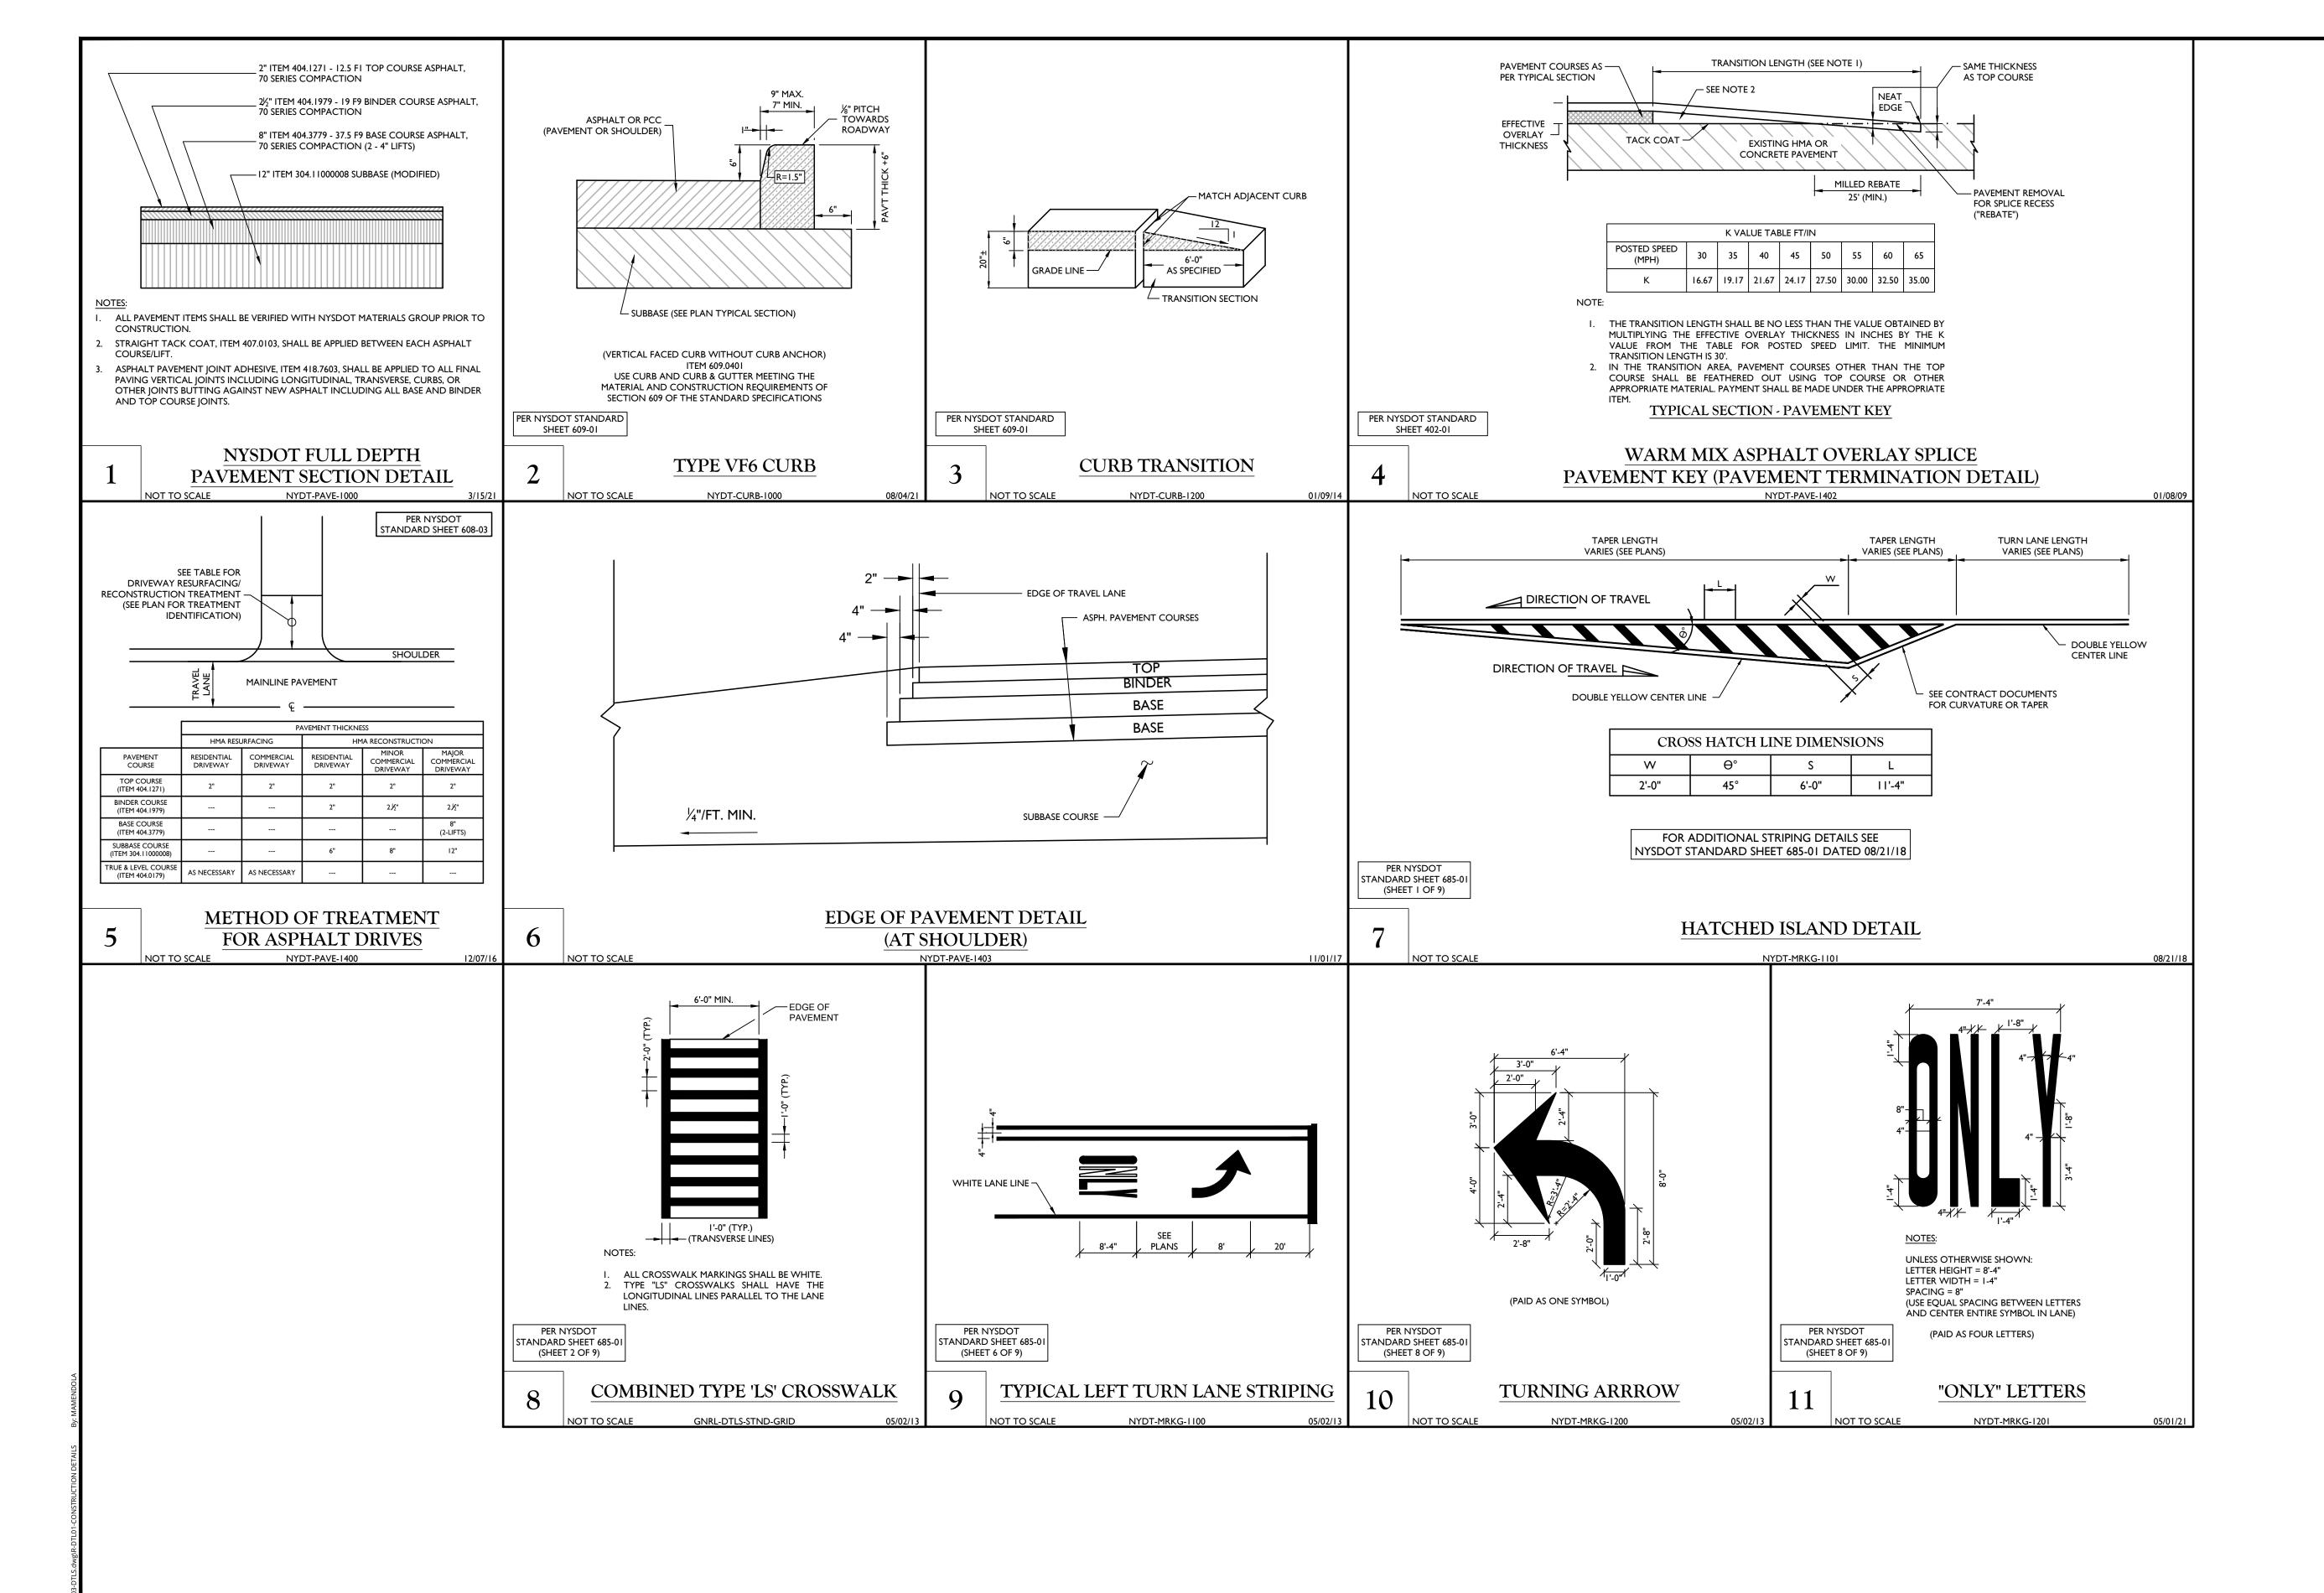

Engineering & Design


www.colliersengineering.com

ppyright © 2024. Colliers Engineering & Design All Rights Reserved. This drawi and all the information contained herein is authorized for use only by the party whom the services were contracted or to whom it is certified. This drawing may r be copied, reused, disclosed, distributed or relied upon for any other purpo without the express written consent of Colliers Engineering & Design.

PROTECT YOURSELF

EXCAVATORS, DESIGNERS, OR ANY PERSO PREPARING TO DISTURB THE EARTH'S SURFACE ANYWHERE IN ANY STATE

FOR STATE SPECIFIC DIRECT PHONE NUMBERS VISIT: WWW.CALL811.COM

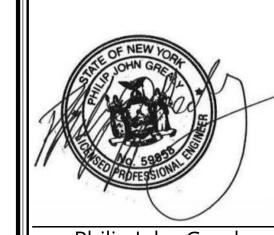

Philip John Grealy NEW YORK LICENSED PROFESSIONAL ENGINEER LICENSE NUMBER: 059858-1 COLLIERS ENGINEERING & DESIGN CT, P.C. N.Y. C.O.A #: 0017609

HIGHWAY IMPROVEMENT PLANS

FOR

UNDERHILL AVENUE **IMPROVEMENTS** (SEQR # 22-092)

NYS ROUTE 118 (S.H. 148) AT UNDERHILL AVENUE

TOWN OF YORKTOWN WESTCHESTER COUNTY **NEW YORK**

Colliers Engineering

WESTCHESTER 400 Columbus Avenue, Suite 180E Valhalla, NY 10595

Phone: 914.347.7500


1/8/23 AS SHOWN R-PL03-DTLS 20006297A


& Design

CONSTRUCTION DETAILS

DTL-01

JNAUTHORIZED ALTERATION OR ADDITION TO A SURVEY OR ENGINEERING MAP BEARING A LICENSED LAND SURVEYOR OR PROFESSIONAL ENGINEER IS A VIOLATION OF SECTION 7209, SUB-DIVISION 2, OF THE NEW YORK STATE EDUCATION LAW. ONLY MAPS WITH THE LAND SURVEYOR OR PROFESSIONAL ENGINEER'S SEAL ARE GENUINE TRUE AND CORRECT COPIES OF THE LAND SURVEYOR OR PROFESSIONAL ENGINEER'S ORIGINAL WORK AND OPINION.

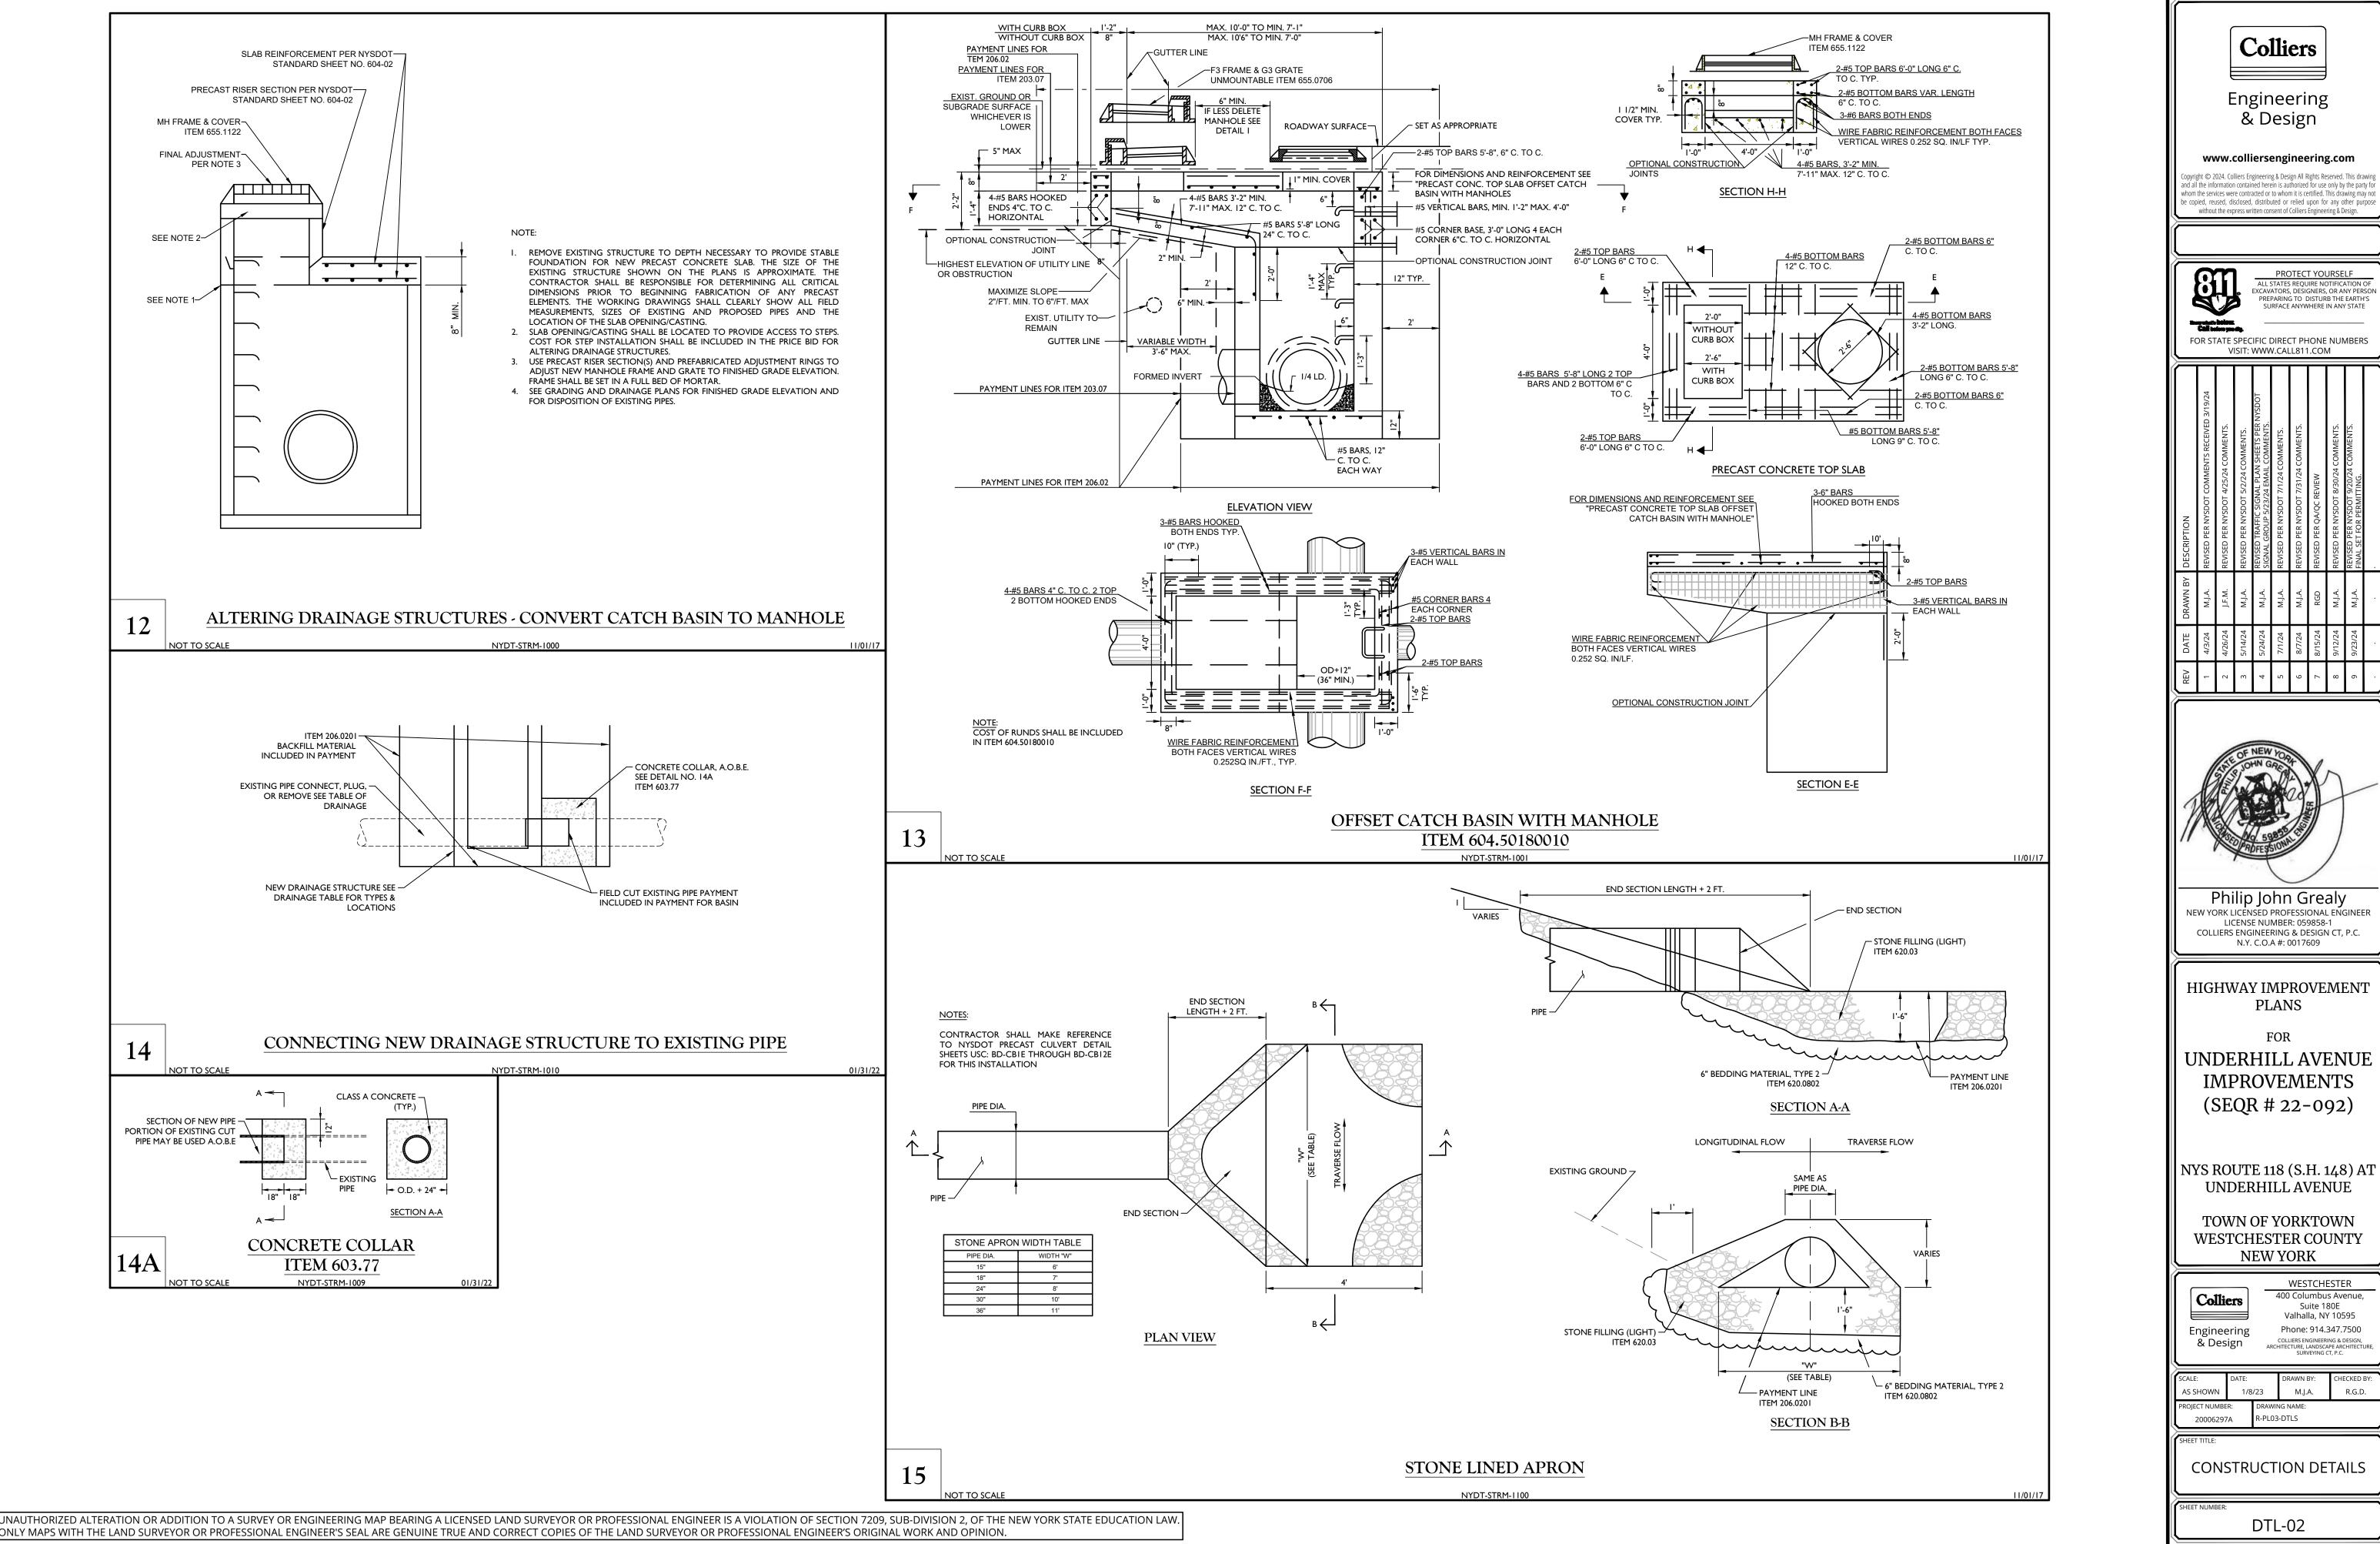

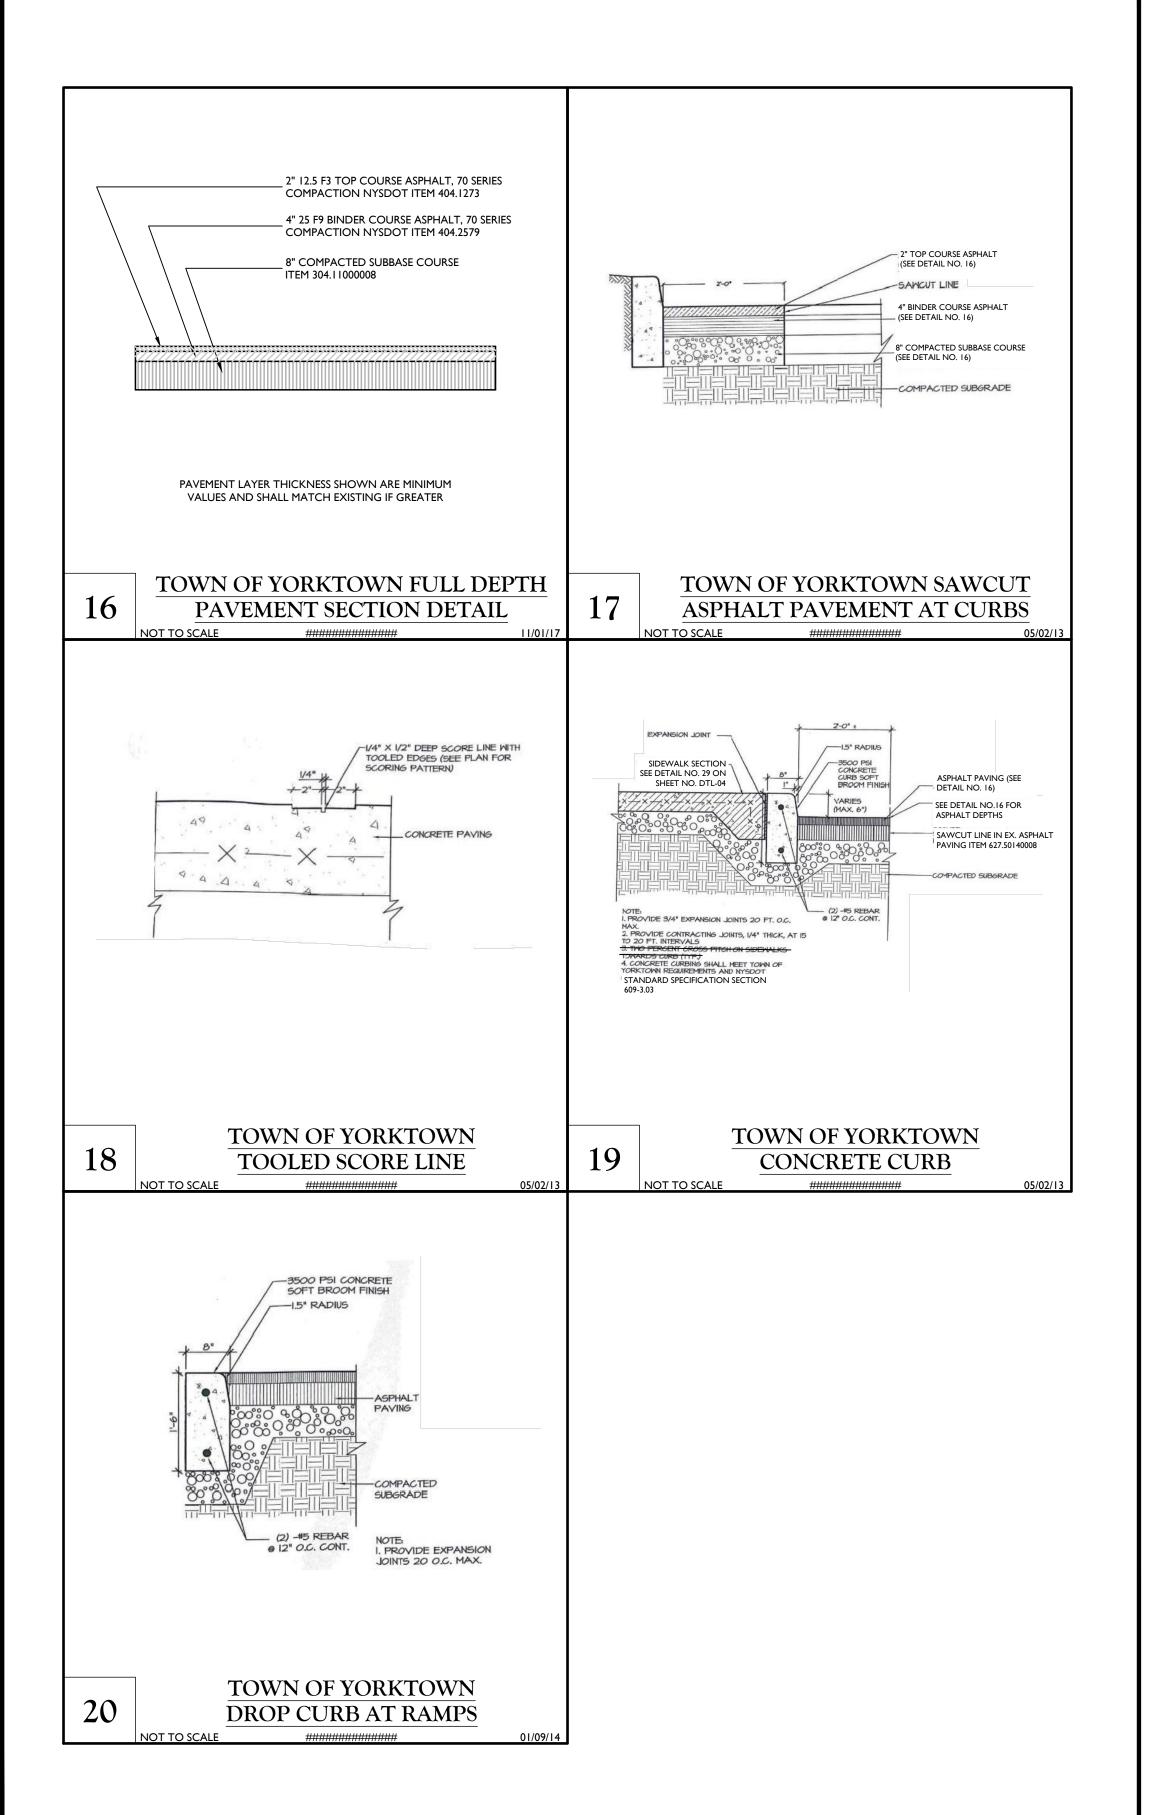

SIDEWALK CURB RAMP NOTES

GNRL-NOTE-STND-GRID

GENERAL NOTES:

- 1) THESE SHEETS ARE IN ACCORDANCE WITH THE AMERICANS WITH DISABILITIES ACT (ADA), AND THE REQUIREMENTS OF THE 2013 PROPOSED ACCESSIBILITY GUIDELINES FOR PEDESTRIAN FACILITIES IN THE PUBLIC RIGHT OF WAY (PROWAG).
- 2) THE DIMENSIONS SHOWN IN THE DETAILS AS MINIMUMS AND MAXIMUMS ARE THE LIMITS FOR DESIGN AND FIELD LAYOUT. FOR WORK ACCEPTANCE VALUES SEE "CRITICAL ELEMENTS FOR THE DESIGN, LAYOUT, AND ACCEPTANCE OF PEDESTRIAN FACILITIES" ON SHEET 11 OF 12 AND SHEET 12 OF 12.
- A) THE CONTRACTOR SHALL BE RESPONSIBLE FOR FIELD VERIFYING ALL ELEVATIONS AND DIMENSIONS TO ENSURE THAT THE FINAL LAYOUT OF PEDESTRIAN FACILITIES MEETS ADA REQUIREMENTS. ANY SURVEY WORK NECESSARY TO MEET THESE REQUIREMENTS SHALL BE PAID FOR UNDER ITEM 625.01 - SURVEY OPERATIONS. A CONTRACT CONTROL PLAN IS NOT NECESSARY FOR WORK LIMITED TO SIDEWALKS AND CURB
- 3) FACILITIES THAT CANNOT BE CONSTRUCTED TO MEET THE DESIGN STANDARDS, DUE TO DESIGN CONSTRAINTS, SHALL BE CONSTRUCTED TO MEET THE STANDARDS TO THE GREATEST EXTENT PRACTICABLE. FEATURES THAT CANNOT MEET THE VALUES FOR WORK ACCEPTANCE SHALL BE JUSTIFIED AS NONSTANDARD PER HIGHWAY DESIGN MANUAL CHAPTER 2.
- 4) TO CHECK FIELD LAYOUT AND TO VERIEY WORK ACCEPTANCE, ALL MEASUREMENTS SHALL BE MADE IN ACCORDANCE WITH THE "NOTES ON INSPECTION METHODS (MEASUREMENT)" ON SHEET 11 OF 12.
- 5) JOINTS BETWEEN SIDEWALKS, CURB RAMPS, TURNING SPACES AND ROADWAYS SHALL BE FLUSH AND FREE FROM ABRUPT VERTICAL CHANGES GREATER THAN. 1/4". VERTICAL SURFACE DISCONTINUITIES BETWEEN, ¼" AND ½" SHALL BE BEVELED WITH A SLOPE NOT STEEPER THAN 1:2. THE BEVEL SHALL BE APPLIED ACROSS THE ENTIRE JOINT. SEE "VERTICAL SURFACE DISCONTINUITIES" DETAIL ON SHEET 2 OF 12.
- 6) SIDEWALKS ARE CONNECTED TO ROADWAYS BY BLENDED TRANSITIONS OR CURB RAMPS. BLENDED TRANSITIONS ARE CONNECTIONS BETWEEN THE SIDEWALK LEVEL AND THE ROADWAY LEVEL THAT HAVE A MAXIMUM GRADE (RUNNING SLOPE) OF 5%. CONNECTIONS WITH A MAXIMUM GRADE (RUNNING SLOPE) GREATER THAN 5% ARE CONSIDERED CURB
- 7) CURB RAMPS AND BLENDED TRANSITIONS MAY REQUIRE THE INSTALLATION OF DETECTABLE WARNINGS. SEE ADDITIONAL "DETECTABLE WARNING NOTES" AND THE DETAILS ON DIMENSIONS AND ORIENTATION ON SHEET 2 OF 12.
- 8) GRADE BREAKS WITHIN THE PEDESTRIAN ACCESS ROUTE SHOULD BE PERPENDICULAR TO THE DIRECTION OF TRAVEL AND SHALL NOT BE ROUNDED. VERTICAL ALIGNMENT SHALL BE GENERALLY PLANAR.
- 9) MATERIAL DEPTHS SHOWN ON THESE SHEETS ARE TYPICAL MINIMUM VALUES AND MAY BE DIFFERENT IN THE CONTRACT DOCUMENTS.
- 10) SIDEWALK GRADE (RUNNING SLOPE) SHALL NOT EXCEED 4.5% FOR DESIGN AND LAYOUT OR 5% FOR WORK ACCEPTANCE, EXCEPT WHEN MATCHING INTO EXISTING SIDEWALK OR WHEN THE ADJACENT HIGHWAY GRADE IS STEEPER THAN 5%, WHEN THE ADJACENT HIGHWAY GRADE IS GREATER THAN 5%, THE SIDEWALK GRADE SHALL NOT EXCEED THE
- 11) THE CROSS SLOPE OF PEDESTRIAN ACCESS ROUTE SHALL BE 1.5% MAXIMUM FOR DESIGN AND LAYOUT, AND 2% MAXIMUM FOR WORK ACCEPTANCE. THE FOLLOWING EXCEPTIONS
- THERE IS NO YIELD OR STOP SIGN, OR WHERE THERE IS A TRAFFIC SIGNAL THAT IS DESIGNED FOR THE GREEN PHASE, THE CROSS SLOPE OF A PEDESTRIAN ACCESS ROUTE CONTAINED WITHIN A STREET CROSSING (CROSSWALK) SHALL BE 4.5% MAXIMUM FOR DESIGN AND LAYOUT. AND 5% MAXIMUM FOR WORK ACCEPTANCE

A) WHERE PEDESTRIAN STREET CROSSINGS ARE PROVIDED AT INTERSECTIONS WHERE

- B) WHERE MIDBLOCK PEDESTRIAN STREET CROSSINGS ARE PROVIDED. THE CROSS SLOPE OF A PEDESTRIAN ACCESS ROUTE CONTAINED WITHIN A MIDBLOCK STREET CROSSING SHALL BE PERMITTED TO EQUAL THE STREET OR HIGHWAY GRADE.
- 12) THE MINIMUM CLEAR WIDTH FOR PEDESTRIAN ACCESS ROUTES IS 4'-0", EXCLUSIVE OF THE CURB. THE DEPARTMENT'S PREFERRED CLEAR WIDTH IS 5'-0". WHEN WALKWAY WIDTHS ARE LESS THAN 5'-0", 5'-0" x 5'-0" PASSING SPACES (SHOWN IN DETAIL A OR B ON THIS SHEET), OR A FEATURE OF EQUAL OR GREATER DIMENSIONS THAT MEETS THE SLOPE AND SURFACE CRITERIA. SHALL BE PROVIDED AT A MAXIMUM INTERVAL OF 200'. EXISTING DRIVEWAYS AND STREET CROSSINGS MAY SERVE AS PASSING SPACES. PROVIDED THEY MEET SLOPE AND SURFACE REQUIREMENTS FOR A PEDESTRIAN ACCESS ROUTE.
- 13) THE BUFFER ZONE IS A PHYSICAL DISTANCE SEPARATING THE PEDESTRIAN ACCESS ROUTE FROM THE VEHICLE TRAVELED WAY. THE BUFFER ZONE MAY BE PLANTED OR PAVED. WHERE THE BUFFER ZONE WIDTH, EXCLUSIVE OF CURB, IS LESS THAN 3'-0", THE SURFACE SHOULD BE PAVED OR CONSTRUCTED WITH HARDSCAPE MATERIALS.
- 14) THE MAXIMUM RECOMMENDED CROSS SLOPE OF A TURE BUFFER ZONE OR SLOPE TRANSITION BEHIND SIDEWALK IS 25%. BUFFER ZONES WITH A CROSS SLOPE GREATER THAN 25% SHOULD BE PAVED, PLANTED OR CONSTRUCTED WITH HARDSCAPE MATERIALS. 15) WHEN CROSSING DRIVEWAYS, THE WORK SHALL BE IN CONFORMANCE WITH STANDARD
- 16) FOR PEDESTRIAN SIGNALS AND PEDESTRIAN PUSH BUTTONS, REFER TO SHEET 12 OF 12 AND STANDARD SHEET 680-10 FOR DETAILS.
- 17) WHERE EXISTING ROADWAYS ARE SAWCUT TO INSTALL CURBING AND/OR SIDEWALK, THE ROADWAY SHOULD BE SAWCUT AT LEAST 2'-0" FROM THE PROPOSED CURB LINE TO ALLOW FOR ADEQUATE COMPACTION OF ASPHALT. IF THE SAWCUT IS LESS THAN 2'-0" D CONCRETE. SEE DETAILS ON SHEET 9 OF 12.

CURB RAMP NOTES

SHEET 608-03.

- 18) THE MINIMUM CLEAR WIDTH OF A CURB RAMP SHALL BE 4'-0". THE DEPARTMENT'S
- PREFERRED CLEAR WIDTH IS 5'-0". 19) THE MAXIMUM GRADE (RUNNING SLOPE) FOR DESIGN AND LAYOUT OF A CURB RAMP SHALL BE 7.5%. THE GRADE FOR WORK ACCEPTANCE SHALL BE A MAXIMUM OF 8.3%.
- 20) WHERE THE TERRAIN DOES NOT ALLOW CONSTRUCTION OF A CURB RAMP WITH A GRADE (RUNNING SLOPE) OF 8.3%. OR LESS WITHIN 15'-0", THE RAMP LENGTH SHALL NOT BE REQUIRED TO EXCEED 15'-1" FOR DESIGN AND LAYOUT OR 15'-0" FOR WORK ACCEPTANCE

21) THE CROSS SLOPE OF THE CURB RAMP SHALL BE AS FLAT AS POSSIBLE AND STILL PROVIDE POSITIVE DRAINAGE. THE CROSS SLOPE OF A CURB RAMP SHALL BE 1.5% MAXIMUM FOR DESIGN AND LAYOUT. AND 2% MAXIMUM FOR WORK ACCEPTANCE. THE FOLLOWING EXCEPTIONS ARE ALLOWED:

08/18/21

- A) WHERE PEDESTRIAN STREET CROSSINGS ARE PROVIDED AT INTERSECTIONS WHERE THERE IS NO YIELD OR STOP SIGN. OR WHERE THERE IS A TRAFFIC SIGNAL THAT IS DESIGNED FOR THE GREEN PHASE, AND AT MIDRI OCK, CROSSINGS, THE CROSS SLOPE OF THE CURB RAMP SHALL BE PERMITTED TO EQUAL THE STREET OR HIGHWAY GRADE
- 22) WHERE THE EXISTING ROADWAY GRADE EXCEEDS THE MAXIMUM ALLOWABLE CROSS SLOPE FOR A CURB RAMP, AND CANNOT BE CORRECTED WITHIN THE SCOPE OF THE PROJECT. THE RAMP SHOULD BE DESIGNED AND CONSTRUCTED IN ACCORDANCE WITH THE "CURB RAMP CROSS SLOPE TRANSITION" DETAIL ON SHEET 8 OF 12. THE RAMP MAY NEED TO BE JUSTIFIED AS A NONSTANDARD FEATURE. SEE NOTE 3 ON THIS SHEET
- 23) RAMP SIDE OPTIONS ARE DETAILED ON SHEET 3 OF 12. WHERE A PEDESTRIAN CIRCULATION PATH CROSSES THE CURB RAMP, FLARED SIDES SHALL BE INSTALLED WITH A MAXIMUM SLOPE OF 9.5% FOR DESIGN AND LAYOUT, AND 10% MAXIMUM FOR WORK ACCEPTANCE. A PEDESTRIAN CIRCULATION PATH IS ASSUMED TO CROSS THE CURB RAMP WHEN AREA ADJACENT TO THE RAMP IS PAVED AND FREE OF VERTICAL OBSTRUCTIONS THAT WOULD PREVENT PEDESTRIAN PASSAGE. THERE IS NO MAXIMUM FLARE SLOPE FOR A RAMP THAT IS NOT CROSSED BY A PEDESTRIAN CIRCULATION PATH.
- 24) THE BACK SIDE OF A PARALLEL RAMP SHOULD BE GRADED TO A MAXIMUM SLOPE OF 25% TO MATCH EXISTING TERRAIN, UNLESS OTHERWISE SHOWN IN THE CONTRACT DOCUMENTS. WHERE GRADING IS NOT FEASIBLE DUE TO LIMITED ROW OR PHYSICAL CONSTRAINTS, A BACK CURB MAY BE INSTALLED. SEE DETAILS ON SHEET 3 OF 12 AND SHEFT 9 OF 12.
- 25) THE DEPARTMENT'S PREFERENCE IS TO INSTALL TWO SEPARATE CURB RAMPS AT A STREET CORNER THAT SERVES TWO SEPARATE PEDESTRIAN CROSSINGS, WITH EACH RAMP ALIGNED TO THE CROSSING THAT IT SERVES. WHERE EXISTING PHYSICAL CONSTRAINTS PREVENT SEPARATE RAMPS, A SINGLE CURB RAMP (I.E., A DIAGONAL CURB RAMP) IS PERMITTED TO SERVE BOTH PEDESTRIAN CROSSINGS. TURNING SPACE AND CLEAR SPACE NOTES:
- 26) WHERE A CHANGE IN DIRECTION IS REQUIRED TO UTILIZE A CURB RAMP. A TURNING SPACE SHALL BE PROVIDED AT THE BASE OR THE TOP OF CURB RAMP, AS APPLICABLE. TURNING

SPACES SHALL BE PERMITTED TO OVERLAP CLEAR SPACES.

- 27) WHERE THERE ARE NO VERTICAL CONSTRAINTS AT THE BACK OF SIDEWALK, (E.G., VERTICAL CURBS, BUILDINGS FENCES) THE TURNING SPACE DIMENSIONS SHALL BE 4'-0" x 4'-0" MINIMUM. WHERE THE TURNING SPACE IS CONSTRAINED AT THE BACK OF SIDEWALK, THE TURNING SPACE SHALL BE 4'-0" X 5'-0" MINIMUM. THE 5'-0" DIMENSION SHALL BE IN THE DIRECTION OF THE RAMP RUN.
- 28) TURNING SPACES SHALL NOT BE DESIGNED WITH A SLOPE GREATER THAN 1.5% IN ANY DIRECTION. WHILE PROVIDING POSITIVE DRAINAGE. THE MAXIMUM SLOPE FOR WORK ACCEPTANCE IS 2.0%. THE FOLLOWING EXCEPTIONS ARE ALLOWED:
- A) WHERE PEDESTRIAN STREET CROSSINGS ARE PROVIDED AT INTERSECTIONS WHERE THERE IS NO YIELD OR STOP SIGN. OR WHERE THERE IS A TRAFFIC SIGNAL THAT IS DESIGNED FOR THE GREEN PHASE, AND AT MIDBLOCK CROSSINGS, THE CROSS SLOPE OF THE TURNING SPACE SHALL BE PERMITTED TO EQUAL THE STREET OR HIGHWAY GRADE, WHEN A RAMP EXISTS BETWEEN THE TURNING SPACE AND THE CURB. THE CROSS SLOPE OF THE TURNING SPACE SHOULD BE LESS STEEP THAN THE ROADWAY GRADE AND AS FLAT AS PRACTICABLE WHENEVER POSSIBLE.
- 29) BELOW THE BOTTOM GRADE BREAK OF A CURB RAMP, A CLEAR SPACE OF 4'-0" x 4'-0" MINIMUM SHALL BE PROVIDED WITHIN THE WIDTH OF THE PEDESTRIAN CROSSWALK, AND OUTSIDE THE PARALLEL VEHICLE TRAVEL LANE. THE CLEAR SPACE MAY OVERLAP TURNING SPACES, DETECTABLE WARNING SURFACES, AND DROP CURBS. **DEFINITION OF TERMS:**

ACCESSIBLE ROUTE. SEE "PEDESTRIAN ACCESS ROUTE", BELOW.

CLEAR SPACE. AN UNOBSTRUCTED FLOOR OR GROUND SPACE THAT WILL ACCOMMODATE A SINGLE, STATIONARY WHEELCHAIR AND OCCUPANT.

CROSS SLOPE. THE GRADE THAT IS PERPENDICULAR TO THE DIRECTION OF PEDESTRIAN TRAVEL. IN REGARDS TO NOTES 21 AND 28, CROSS SLOPE PERMITTED TO FOLIAL STREET OR HIGHWAY GRADE IS THE SLOPE PARALLEL TO THE HIGHWAY. THE SLOPE PERPENDICULAR TO THE HIGHWAY SHALL BE 1.5% MAXIMUM FOR DESIGN AND 2% MAXIMUM FOR WORK ACCEPTANCE.

PARALLEL CURB RAMP. A CURB RAMP WITH THE RAMP SLOPE ORIENTED PARALLEL TO THE CURB OR EDGE OF PAVEMENT.

PEDESTRIAN ACCESS ROLITE (PAR) A CONTINUOUS AND LINORSTRUCTED PATH OF TRAVEL PROVIDED FOR PEDESTRIANS WITH DISABILITIES WITHIN OR COINCIDING WITH A PEDESTRIAN

PEDESTRIAN CIRCULATION PATH. A PREPARED EXTERIOR OR INTERIOR SURFACE PROVIDED FOR PEDESTRIAN TRAVEL IN THE PUBLIC RIGHT-OF WAY.

PERPENDICULAR CURB RAMP. A CURB RAMP WITH THE RAMP SLOPE ORIENTED PERPENDICULAR TO THE CURB OR EDGE OF PAVEMENT

YIELD-CONTROLLED LOCATION WITHOUT STOPPING OR SLOWING

RUNNING SLOPE. THE GRADE THAT IS PARALLEL TO THE DIRECTION OF PEDESTRIAN TRAVEL.

STOP- OR VIELD-CONTROLLED LOCATION, AN INTERSECTION, DRIVEWAY OR PEDESTRIAN CROSSING WHERE VEHICULAR TRAFFIC IS CONTROLLED BY A YIELD SIGN, A STOP SIGN, OR A

TRAFFIC SIGNAL THAT FLASHES RED. VEHICULAR TRAFFIC DOES NOT PASS THROUGH A STOP- OR

TRAFFIC SIGNAL THAT IS DESIGNED FOR THE GREEN PHASE. A TRAFFIC SIGNAL OTHER THAN A FLASHING RED OR FLASHING YELLOW.

TURNING SPACE. A RELATIVELY LEVEL SPACE PROVIDED WHERE A TURNING MANEUVER IS REQUIRED FOR A PEDESTRIAN TO ORIENT TO A CURB RAMP OR STREET CROSSING.

DETECTABLE WARNING NOTES:

1) DETECTABLE WARNING SURFACES (DWS) SHALL BE PROVIDED AT THE FOLLOWING

ACROSS THE REFUGE ISLAND IS GREATER THAN OR EQUAL TO 6').

A. CURB RAMPS AND BLENDED TRANSITIONS AT PEDESTRIAN STREET CROSSINGS.

PEDESTRIAN AT-GRADE RAIL CROSSINGS NOT LOCATED WITHIN A STREET OR

ROUTE CROSSES DRIVEWAYS WITH SIGNAL, YIELD OR STOP CONTROL. DETECTABLE

WARNING SURFACES SHALL NOT BE PROVIDED AT CROSSINGS OF UNCONTROLLED

WITH THE EXCEPTION OF THE "DETECTABLE WARNING SURFACE TRUNCATED DOME

DETECTABLE WARNING FIELDS SHALL EXTEND 24" MINIMUM IN THE DIRECTION OF

5) SOME DETECTABLE WARNING PRODUCTS REQUIRE A CONCRETE BORDER FOR PROPER

INSTALLATION. BORDERS CANNOT BE INCLUDED AS PART OF THE 24" MINIMUM

A. WHEN PLACED AT THE BACK OF CURB, DETECTABLE WARNING FIELDS SHOULD BE

BACK OF CURB. WHERE THE BACK OF THE CURB EDGE IS TOOLED TO PROVIDE A

RADIUS. THE BORDER DIMENSION SHALL BE MEASURED FROM THE INSIDE EDGE OF

THE CURB RADIUS. WHERE CURB IS NOT USED, THE EDGE OF PAVEMENT SHALL BE

WHEN PLACED ABOVE THE LOWER GRADE BREAK OF A CURB RAMP, DETECTABLE

FRONT CORNERS OF RECTILINEAR DETECTABLE WARNING FIELDS SHALL NOT BE

SUBSTITUTED FOR THE BACK OF CURB FOR PLACEMENT OF DETECTABLE WARNINGS.

WARNING UNITS SHOULD BE PLACED AS CLOSE TO THE JOINT AS PRACTICABLE. BOTH

WHEN RADIAL DWS UNITS ARE PLACED AT THE BACK OF CURB, THE FRONT EDGE OF

THE DWS FIELD SHOULD BE AS CLOSE AS POSSIBLE TO THE BACK OF CURB, I.E., THE

RADIUS OF THE FRONT OF THE DWS FIFLD SHOULD MATCH THE RADIUS ALONG THE BACK OF CURB AS CLOSELY AS POSSIBLE. THE OUTSIDE CORNERS OF THE DWS FIELD

MUST BE LOCATED NO MORE THAN 2 INCHES FROM THE BACK OF CURB.

PERPENDICULAR OR RADIAL TO THE LOWER GRADE BREAK ON THE RAMP RUN. WHERE

SPACING WITHIN THE RANGES SPECIFIED ON THIS SHEET. DOME ALIGNMENT THAT IS

THE DETECTABLE WARNING FIELD SHALL BE THE COLOR SPECIFIED IN THE CONTRACT

OR HIGHWAY, OR PEDESTRIAN ACCESS ROUTE SURFACE, EITHER LIGHT-ON-DARK OR

DOCUMENTS OR MEET THE REQUIREMENTS OF THE STANDARD SPECIFICATIONS.

DOMES ARE ARRAYED RADIALLY, THEY MAY DIFFER IN DIAMETER AND CENTER-TO-CENTER

PERPENDICULAR OR RADIAL TO THE LOWER GRADE BREAK IS NOT REQUIRED ON SLOPES OF

DETECTABLE WARNING SURFACES CONTRAST VISUALLY WITH ADJACENT GUTTER, STREET

6) ON SLOPES OF 5% OR GREATER. THE ROWS OF DOMES SHALL BE ALIGNED TO BE

PLACED AS CLOSE TO THE BACK OF CURB AS PRACTICABLE. BOTH FRONT CORNERS OF

THE DETECTABLE WARNING FIELD SHALL NOT BE LOCATED MORE THAN 2" FROM THE

DETAILS" DETECTABLE WARNING DOMES ON THIS SHEET ARE NOT DEPICTED TO SCALE.

PEDESTRIAN TRAVEL ACROSS THE FULL WIDTH OF THE CURB RAMP OR FLUSH SURFACE,

DETECTABLE WARNING SURFACES SHALL BE PROVIDED WHERE THE PEDESTRIAN ACCESS

B. PEDESTRIAN REFUGE ISLANDS (WHERE LENGTH OF THE PEDESTRIAN ACCESS ROUTE

LOCATIONS ON PEDESTRIAN ACCESS ROUTES

EXCLUDING ANY FLARED SIDES.

LESS THAN 5%.

DIMENSION DESCRIBED IN NOTE 4.

LOCATED MORE THAN 2" FROM THE JOINT.

GNRL-NOTE-STND-DTWS

Engineering

08/18/21

& Design

www.colliersengineering.com

Colliers

pyright © 2024. Colliers Engineering & Design All Rights Reserved. This draw and all the information contained herein is authorized for use only by the party: hom the services were contracted or to whom it is certified. This drawing may n e copied, reused, disclosed, distributed or relied upon for any other purpose without the express written consent of Colliers Engineering & Design



FOR STATE SPECIFIC DIRECT PHONE NUMBERS VISIT: WWW.CALL811.COM



Philip John Grealy NEW YORK LICENSED PROFESSIONAL ENGINEER LICENSE NUMBER: 059858-1 COLLIERS ENGINEERING & DESIGN CT, P.C. N.Y. C.O.A #: 0017609

HIGHWAY IMPROVEMENT

FOR

PLANS

UNDERHILL AVENUE **IMPROVEMENTS** (SEQR # 22-092)

NYS ROUTE 118 (S.H. 148) AT

TOWN OF YORKTOWN WESTCHESTER COUNTY

Colliers Engineering

400 Columbus Avenue, Suite 180E Valhalla, NY 10595 Phone: 914.347.7500

1/8/23 AS SHOWN R-PL03-DTLS 20006297A

CONSTRUCTION DETAILS

DTL-03

SEE SIDEWALK **CURB RAMP NOTE 5** PER NYSDOT STANDARD SHEET 608-01 (SHEET 2 OF 12) VERTICAL SURFACE DISCONTINUITIES

GRADE BREAK TO BACK OF CURB — CURB (TYP.) **GREATER THAN 5'-0"** GRADE BREAK AT BOTTOM OF RAMP -24" MIN IN DIRECTION -OF TRAVEL (SEE NOTE 4) RAMP SLOPE " MAX. DISTANCE FROM FRONT CORNER OF DETECTABLE WARNING FIELD TO BACK OF CURB (TYP.) DETECTABLE WARNING SURFACE — LOCATED ABOVE LOWER GRADE BREAK (SEE NOTES 5B AND 6) OPTION I 24" MIN. IN DIRECTION — OF TRAVEL (SEE NOTE 4) GRADE BREAK TO BACK OF CURB LESS THAN 5'-0" GRADE BREAK TO BACK OF CURB – CURB (TYP.) 24" MIN IN DIRECTION OF TRAVEL — GRADE BREAK AT **GREATER THAN 5'-0"** (SEE NOTE 4) BOTTOM OF RAMP **RECTANGULAR UNITS -**PER NYSDOT STANDARD CUT TO FIT DETECTABLE CURB (TYP.) WARNING SURFACE (TYP. SHEET 608-01 (SHEET 2 OF 12) " MAX. DISTANCE FROM FRONT CORNER OF DETECTABLE WARNING FIELD TO BACK OF CURB (TYP.) (SEE NOTE 5A) DETECTABLE WARNING SURFACE - CUT EDGE TO CUT EDGE JOINTS (TYP.) LOCATED ABOVE LOWER GRADE BREAK (SEE NOTES 5B & 6) UDROP CURB BOTTOM OF RAMP 24" MIN. IN DIRECTION -OPTION 2 OF TRAVEL (SEE NOTE 4)

TRUNCATED DOME DIMENSIONS DIM. MIN. (IN) MAX. (IN) A 1.6"

DETECTABLE WARNING SURFACE (DWS) PLACEMENT OPTION DETAILS

JNAUTHORIZED ALTERATION OR ADDITION TO A SURVEY OR ENGINEERING MAP BEARING A LICENSED LAND SURVEYOR OR PROFESSIONAL ENGINEER IS A VIOLATION OF SECTION 7209, SUB-DIVISION 2, OF THE NEW YORK STATE EDUCATION LAW. INLY MAPS WITH THE LAND SURVEYOR OR PROFESSIONAL ENGINEER'S SEAL ARE GENUINE TRUE AND CORRECT COPIES OF THE LAND SURVEYOR OR PROFESSIONAL ENGINEER'S ORIGINAL WORK AND OPINION

NOTE: DO NOT SCALE DRAWINGS FOR CONSTRUCTION.

0.65"

0.9"

50% - 65% OF D DIM.

DETECTABLE WARNING SURFACE

(DWS) TRUNCATED DOME DETAILS

1.5"

1.**4**"

PER NYSDOT STANDARD


SHEET 608-01


UNDERHILL AVENUE

NEW YORK

WESTCHESTER

& Design

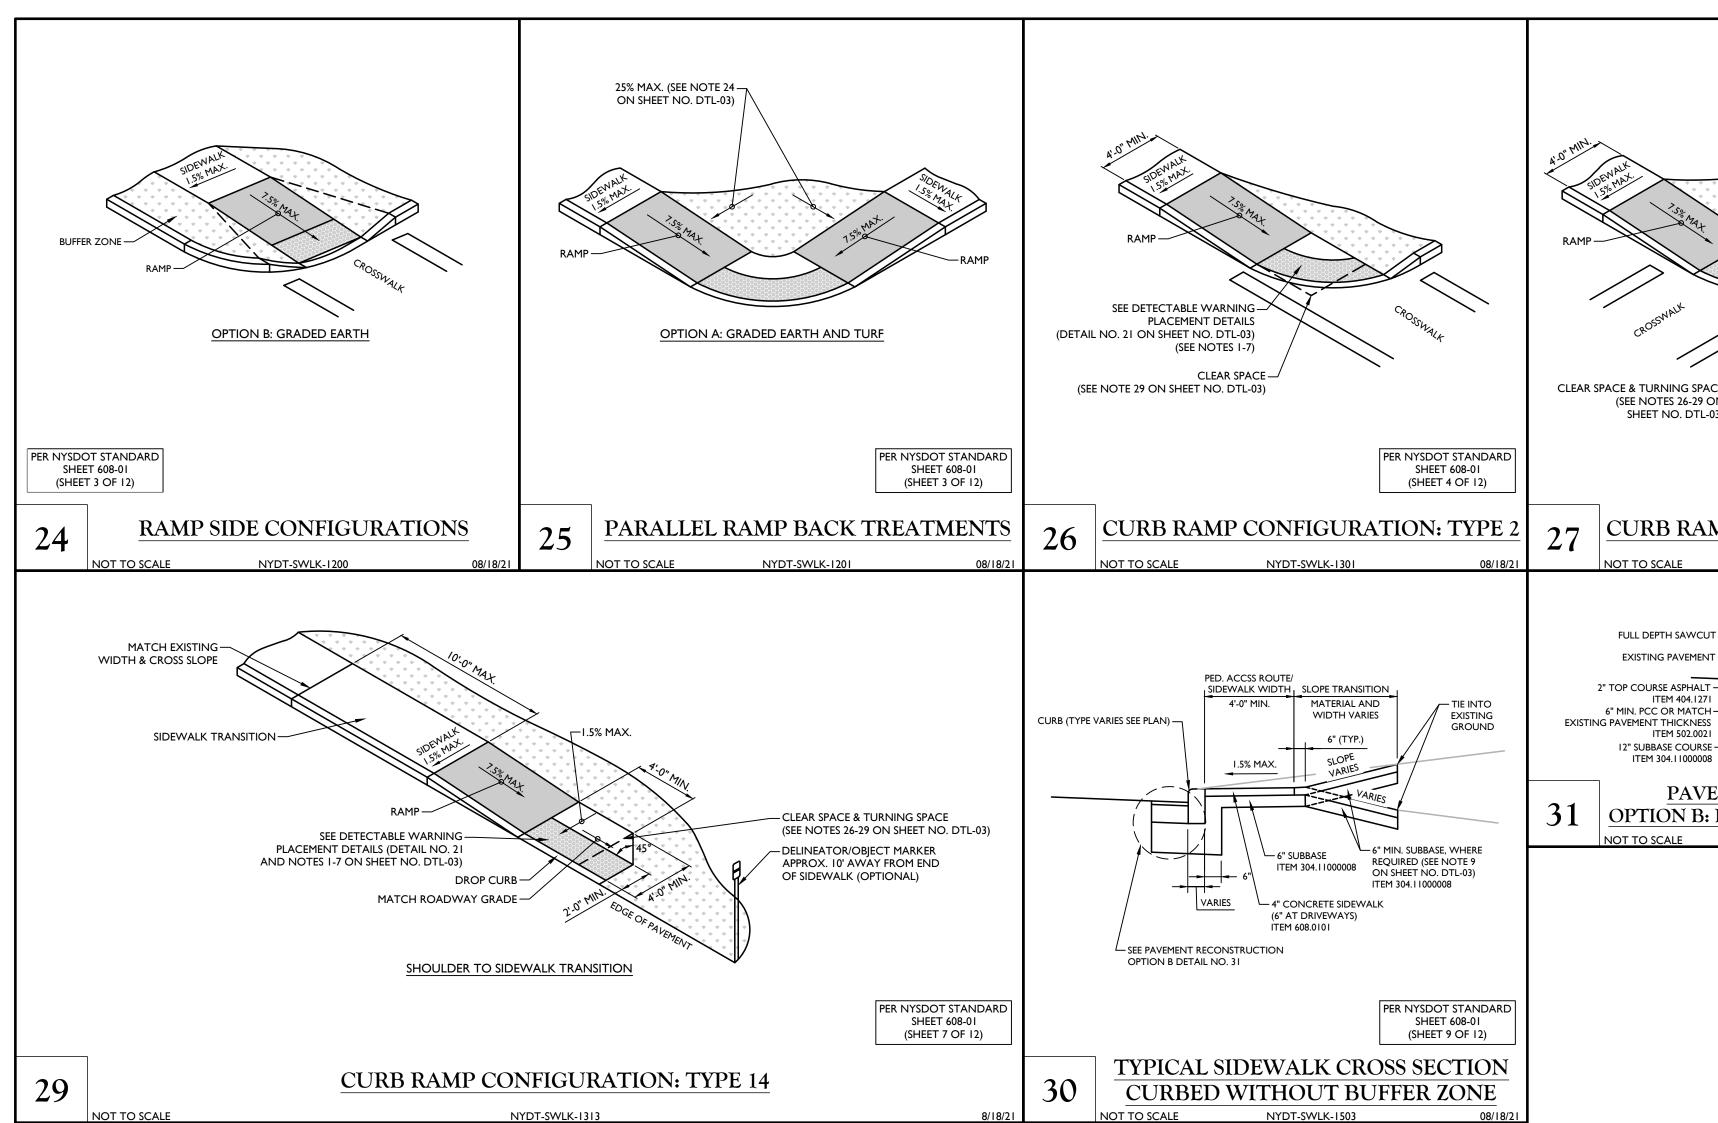

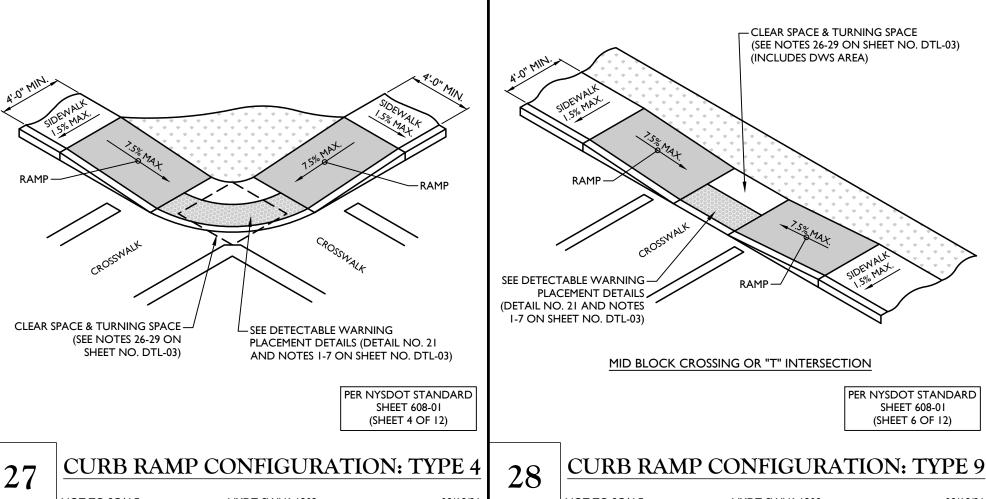

- PROPOSED CURB

ER NYSDOT STANDARD

SHEET 608-01

(SHEET 9 OF 12)

FULL DEPTH SAWCUT -EXISTING PAVEMENT -

ITEM 502.0021

ITEM 304.11000008 (SEE NOTE 17)

PAVEMENT RECONSTRUCTION

OPTION B: PORTLAND CEMENT CONCRETE

NYDT-SWLK-1505

12" SUBBASE COURSE -



Engineering & Design

www.colliersengineering.com

and all the information contained herein is authorized for use only by the party be copied, reused, disclosed, distributed or relied upon for any other purpo



FOR STATE SPECIFIC DIRECT PHONE NUMBERS VISIT: WWW.CALL811.COM

DESCRIPTION
REVISED PER NYSDOT COMMENTS RECEIVED 3/19/24
REVISED PER NYSDOT 4/25/24 COMMENTS.
REVISED PER NYSDOT 5/2/24 COMMENTS.
REVISED TRAFFIC SIGNAL PLAN SHEETS PER NYSDOT SIGNAL GROUP 5/23/24 EMAIL COMMENTS.
REVISED PER NYSDOT 7/1/24 COMMENTS.
REVISED PER NYSDOT 7/31/24 COMMENTS.
REVISED PER QA/QC REVIEW
REVISED PER NYSDOT 8/30/24 COMMENTS.
REVISED PER NYSDOT 9/20/24 COMMENTS. FINAL SET FOR PERMITTING.

Philip John Grealy
NEW YORK LICENSED PROFESSIONAL ENGINEER
LICENSE NUMBER: 059858-1 COLLIERS ENGINEERING & DESIGN CT, P.C. N.Y. C.O.A #: 0017609

HIGHWAY IMPROVEMENT **PLANS**

FOR

UNDERHILL AVENUE **IMPROVEMENTS** (SEQR # 22-092)

NYS ROUTE 118 (S.H. 148) AT UNDERHILL AVENUE

TOWN OF YORKTOWN WESTCHESTER COUNTY **NEW YORK**

Colliers

Engineering & Design

WESTCHESTER 400 Columbus Avenue, Suite 180E Valhalla, NY 10595


Phone: 914.347.7500


AS SHOWN 1/8/23 M.J.A. R-PL03-DTLS 20006297A

CONSTRUCTION DETAILS

DTL-04

UNAUTHORIZED ALTERATION OR ADDITION TO A SURVEY OR ENGINEERING MAP BEARING A LICENSED LAND SURVEYOR OR PROFESSIONAL ENGINEER IS A VIOLATION OF SECTION 7209, SUB-DIVISION 2, OF THE NEW YORK STATE EDUCATION LAW. ONLY MAPS WITH THE LAND SURVEYOR OR PROFESSIONAL ENGINEER'S SEAL ARE GENUINE TRUE AND CORRECT COPIES OF THE LAND SURVEYOR OR PROFESSIONAL ENGINEER'S ORIGINAL WORK AND OPINION.

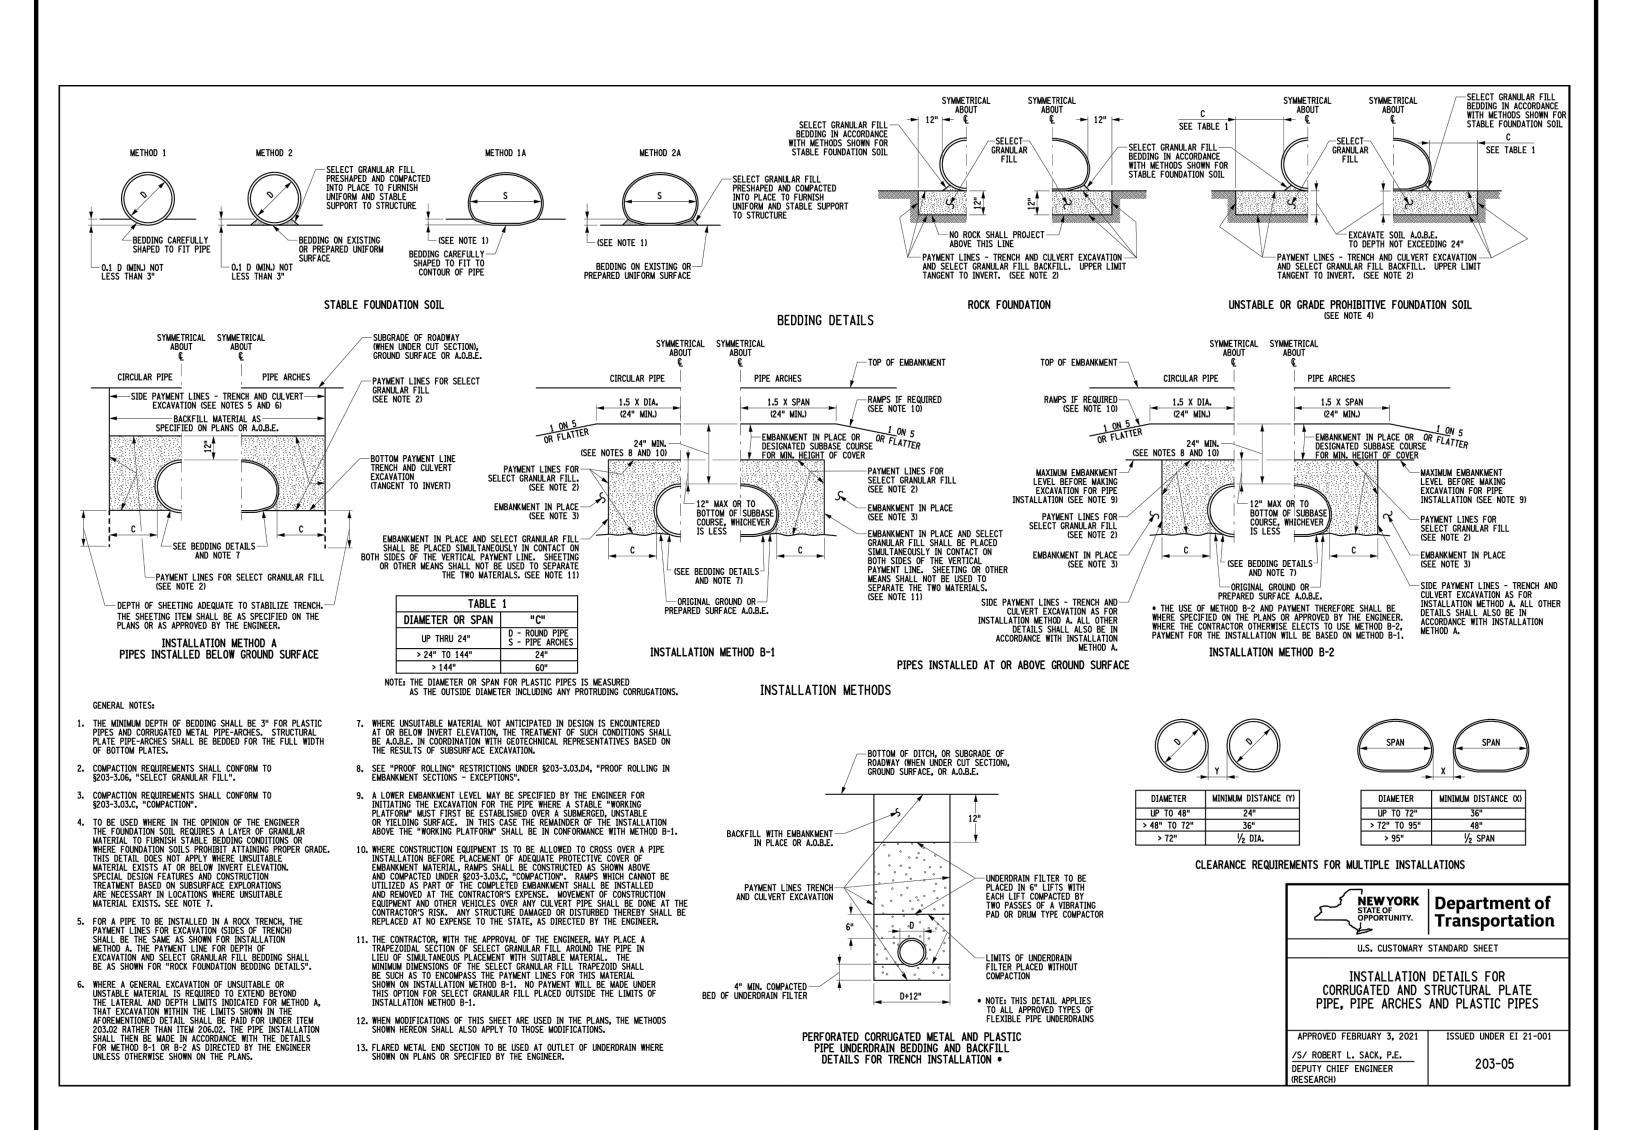

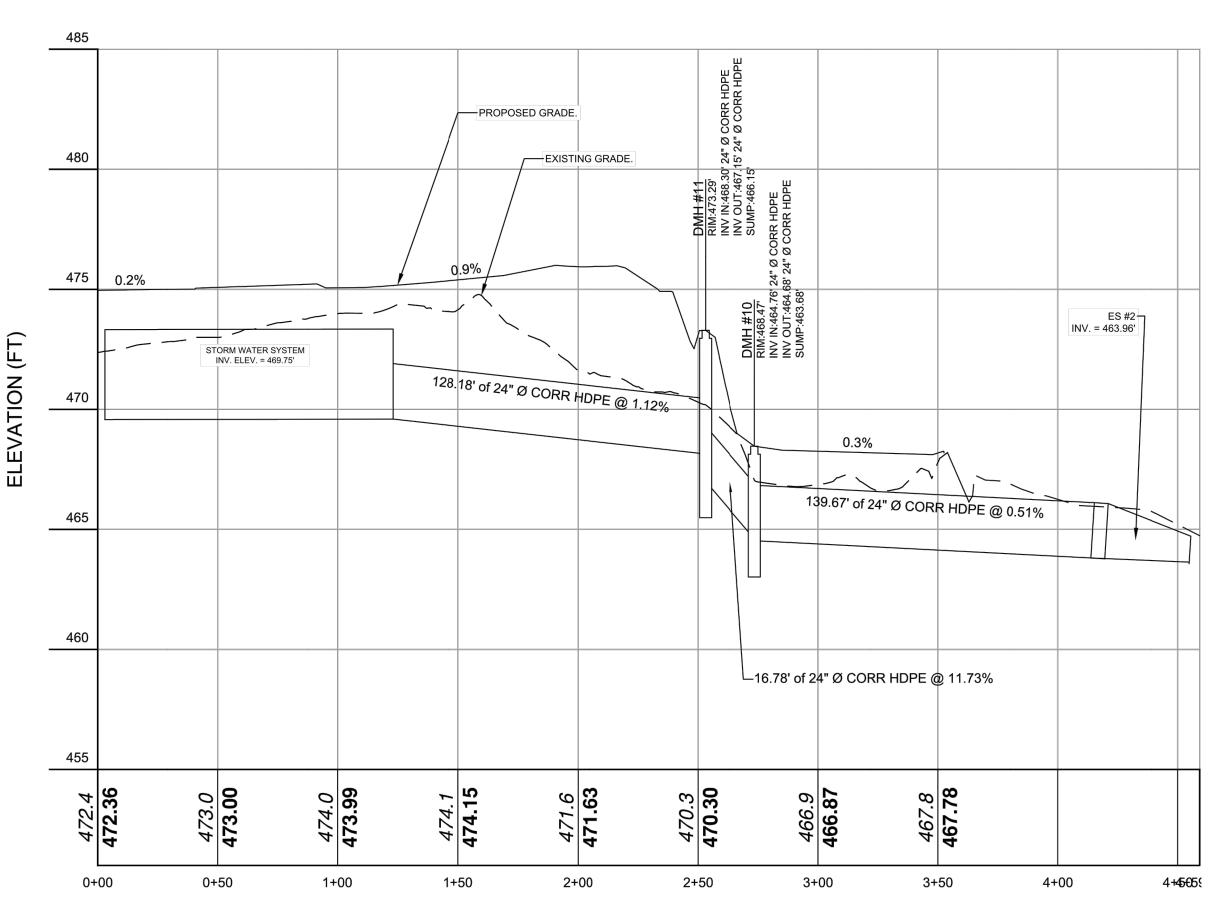

DISTANCE ALONG BASELINE (FT)

DETENTION CHAMBERS TO ES#2 **VERT. SCALE: 1" = 4** HORIZ. SCALE: 1" = 40

Colliers

Engineering & Design

www.colliersengineering.com

ind all the information contained herein is authorized for use only by the party

ALL STATES REQUIRE NOTIFICATION OF EXCAVATORS, DESIGNERS, OR ANY PERSO PREPARING TO DISTURB THE EARTH'S SURFACE ANYWHERE IN ANY STATE

FOR STATE SPECIFIC DIRECT PHONE NUMBERS VISIT: WWW.CALL811.COM

1/											
	DRAWN BY DESCRIPTION	REVISED PER NYSDOT COMMENTS RECEIVED 3/19/24	REVISED PER NYSDOT 4/25/24 COMMENTS.	REVISED PER NYSDOT 5/2/24 COMMENTS.	REVISED TRAFFIC SIGNAL PLAN SHEETS PER NYSDOT SIGNAL GROUP 5/23/24 EMAIL COMMENTS.	REVISED PER NYSDOT 7/1/24 COMMENTS.	REVISED PER NYSDOT 7/31/24 COMMENTS.	REVISED PER QA/QC REVIEW	REVISED PER NYSDOT 8/30/24 COMMENTS.	REVISED PER NYSDOT 9/20/24 COMMENTS. FINAL SET FOR PERMITTING.	
	DRAWN BY	M.J.A.	J.F.M.	M.J.A.	M.J.A.	M.J.A.	M.J.A.	RGD	M.J.A.	M.J.A.	
	DATE	4/3/24	4/26/24	5/14/24	5/24/24	7/1/24	8/7/24	8/15/24	9/12/24	9/23/24	•
ļ	REV	1	2	3	4	5	9	7	8	6	



Philip John Grealy NEW YORK LICENSED PROFESSIONAL ENGINEER LICENSE NUMBER: 059858-1 COLLIERS ENGINEERING & DESIGN CT, P.C. N.Y. C.O.A #: 0017609

HIGHWAY IMPROVEMENT PLANS

FOR UNDERHILL AVENUE **IMPROVEMENTS** (SEQR # 22-092)

NYS ROUTE 118 (S.H. 148) AT UNDERHILL AVENUE

TOWN OF YORKTOWN WESTCHESTER COUNTY **NEW YORK**

Colliers

& Design

WESTCHESTER 400 Columbus Avenue, Suite 180E Engineering

Valhalla, NY 10595 Phone: 914.347.7500 COLLIERS ENGINEERING & DESIGN, ARCHITECTURE, LANDSCAPE ARCHITECTU SURVEYING CT, P.C.


1/8/23 M.J.A. AS SHOWN RAWING NAME R-PL03-DTLS 20006297A

CONSTRUCTION DETAILS


DTL-05

UNAUTHORIZED ALTERATION OR ADDITION TO A SURVEY OR ENGINEERING MAP BEARING A LICENSED LAND SURVEYOR OR PROFESSIONAL ENGINEER IS A VIOLATION OF SECTION 7209, SUB-DIVISION 2, OF THE NEW YORK STATE EDUCATION LAW. ONLY MAPS WITH THE LAND SURVEYOR OR PROFESSIONAL ENGINEER'S SEAL ARE GENUINE TRUE AND CORRECT COPIES OF THE LAND SURVEYOR OR PROFESSIONAL ENGINEER'S ORIGINAL WORK AND OPINION

NYS ROUTE 118 STA: 125+56.97 TO STA: 128+71.97

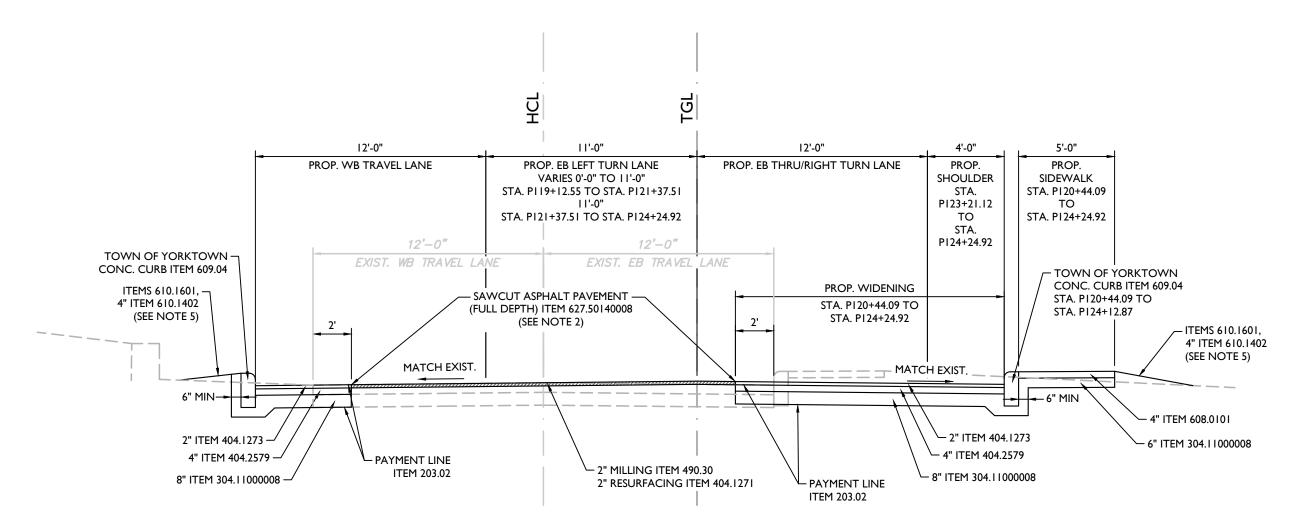

UNDERHILL AVENUE (WEST OF NYS ROUTE 118) STA: P119+12.55 TO STA: P124+24.92

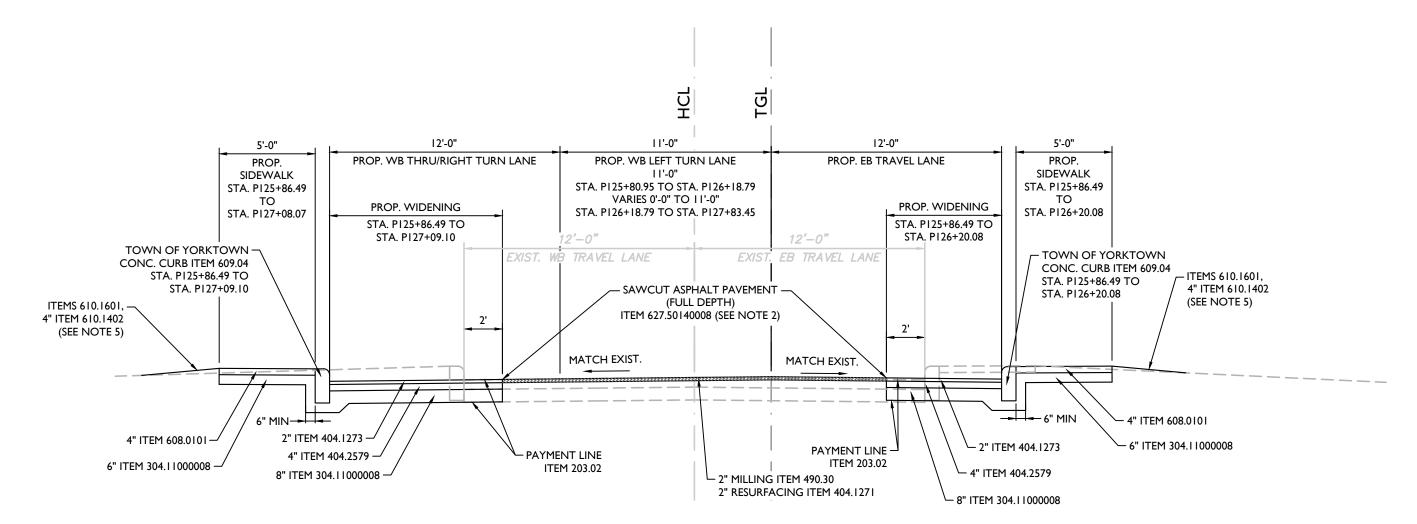

UNDERHILL AVENUE (EAST OF NYS ROUTE 118) STA: P125+80.95 TO STA: P127+83.45

DESCRIPTION

627.50140008

203.02 UNCLASSIFIED EXCAVATION AND DISPOSAL EMBANKMENT IN PLACE 203.03 SUBBASE BASE COURSE, TYPE I (MODIFIED) 304.11000008 404.0179 TRUING & LEVELING F9, 70 SERIES COMPACTION 12.5 F1 TOP COURSE ASPHALT, 70 SERIES COMPACTION 404.1979 19 F9 BINDER COURSE ASPHALT, 70 SERIES COMPACTION 37.5 F9 BASE COURSE ASPHALT, 70 SERIES COMPACTION 404.3779 407.0103 STRAIGHT TACK COAT 418.7603 ASPHALT PAVEMENT JOINT ADHESIVE MISC. COLD MILLING 608.0101 CONCRETE SIDEWALKS AND DRIVEWAYS CAST-IN-PLACE CONCRETE CURB (AS DETAILED) 609.04 CAST-IN-PLACE CONCRETE CURB TYPE VF6 609.0401 610.1402 TOPSOIL - ROADSIDE 610.1601 TURF ESTABLISHMENT (ROADSIDE)

CUTTING PAVEMENT

PROTECT YOURSELF ALL STATES REQUIRE NOTIFICATION OF EXCAVATORS, DESIGNERS, OR ANY PERSOI PREPARING TO DISTURB THE EARTH'S SURFACE ANYWHERE IN ANY STATE

Colliers

Engineering & Design

www.colliersengineering.com

Copyright © 2024. Colliers Engineering & Design All Rights Reserved. This drawin

and all the information contained herein is authorized for use only by the party

whom the services were contracted or to whom it is certified. This drawing may no

be copied, reused, disclosed, distributed or relied upon for any other purpo

without the express written consent of Colliers Engineering & Design.

FOR STATE SPECIFIC DIRECT PHONE NUMBERS VISIT: WWW.CALL811.COM

DESCRIPTION	REVISED PER NYSDOT COMMENTS RECEIVED 3/19/24	REVISED PER NYSDOT 4/25/24 COMMENTS.	REVISED PER NYSDOT 5/2/24 COMMENTS.	REVISED TRAFFIC SIGNAL PLAN SHEETS PER NYSDOT SIGNAL GROUP 5/23/24 EMAIL COMMENTS.	REVISED PER NYSDOT 7/1/24 COMMENTS.	REVISED PER NYSDOT 7/31/24 COMMENTS.	revised per QA/QC review	REVISED PER NYSDOT 8/30/24 COMMENTS.	REVISED PER NYSDOT 9/20/24 COMMENTS. FINAL SET FOR PERMITTING.	
DRAWN BY	M.J.A.	J.F.M.	M.J.A.	M.J.A.	M.J.A.	M.J.A.	RGD	M.J.A.	M.J.A.	•
DATE	4/3/24	4/26/24	5/14/24	5/24/24	7/1/24	8/7/24	8/15/24	9/12/24	9/23/24	•
REV	1	2	3	4	2	9	7	8	6	·



Philip John Grealy NEW YORK LICENSED PROFESSIONAL ENGINEER LICENSE NUMBER: 059858-1 COLLIERS ENGINEERING & DESIGN CT, P.C. N.Y. C.O.A #: 0017609

HIGHWAY IMPROVEMENT PLANS

FOR

UNDERHILL AVENUE **IMPROVEMENTS** (SEQR # 22-092)

NYS ROUTE 118 (S.H. 148) AT UNDERHILL AVENUE

TOWN OF YORKTOWN WESTCHESTER COUNTY **NEW YORK**

Colliers

400 Columbus Avenue, Suite 180E Engineering & Design

Valhalla, NY 10595 Phone: 914.347.7500 ARCHITECTURE, LANDSCAPE ARCHITECT SURVEYING CT, P.C.

WESTCHESTER

1/8/23 AS SHOWN M.J.A. R-PL04-TYPS 20006297A

TYPICAL SECTIONS

TYP-01

NOTE: DO NOT SCALE DRAWINGS FOR CONSTRUCTION.

TYPICAL SECTION NOTES:

I. STRAIGHT TACK COAT ITEM 407.0103 SHALL BE APPLIED BETWEEN EACH ASPHALT COURSE/LIFT.

DURATION OF THE CONTRACT UNDER ITEM 619.21. CLIPPINGS SHALL BE LEFT IN PLACE.

3. ROLL OVER BETWEEN SHOULDER AND TRAVEL LANE SHALL NOT EXCEED 8%.

INCLUDING ALL BASE AND BINDER AND TOP COURSE JOINTS.

2. WHERE CONCRETE PAVEMENT IS LOCATED UNDER ASPHALT OVERLAY AND IS LOCATED WITHIN 3 FT. OF THE PROPOSED WIDENING SECTION, THE WIDENING SHALL EXTEND TO LIMIT OF CONCRETE PAVEMENT.

4. TRUING AND LEVELING COURSE, ITEM 404.0179 MAY BE REQUIRED TO ACHIEVE UNIFORM CROSS SLOPE. CONTRACTOR SHALL VERIFY IF SUCH NEED IS REQUIRED AND CONFER WITH E.I.C. PRIOR TO COMMENCEMENT

5. AS PER SECTION 610-3.10, IN THE ABSENCE OF 1 INCH OF RAINFALL WITHIN 5 CONSECUTIVE CALENDAR DAYS

6. ASPHALT PAVEMENT JOINT ADHESIVE, ITEM 418.7603 SHALL BE APPLIED TO ALL FINAL PAVING VERTICAL JOINTS

THE CONTRACTOR SHALL WATER ALL TURF, WILDFLOWERS, SOD AND PLANTING BEDS ONCE A WEEK TO A


DEPTH OF I INCH UNDER ITEM 610.19. IN ADDITION AS PER SECTION 610-3.12, THE CONTRACTOR SHALL MOW


ALL TURF ESTABLISHMENT AREAS TO A HEIGHT OF 5 INCHES WHEREVER GROWTH REACHES 8 INCHES FOR THE

INCLUDING LONGITUDINAL, TRANSVERSE, CURBS OR OTHER JOINTS BUTTING AGAINST NEW ASPHALT


SCALE : 1" = 5' Linear unit of measure: US Survey Foot (1 ft = 1200/3937 m)

JNAUTHORIZED ALTERATION OR ADDITION TO A SURVEY OR ENGINEERING MAP BEARING A LICENSED LAND SURVEYOR OR PROFESSIONAL ENGINEER IS A VIOLATION OF SECTION 7209, SUB-DIVISION 2, OF THE NEW YORK STATE EDUCATION LAW. ONLY MAPS WITH THE LAND SURVEYOR OR PROFESSIONAL ENGINEER'S SEAL ARE GENUINE TRUE AND CORRECT COPIES OF THE LAND SURVEYOR OR PROFESSIONAL ENGINEER'S ORIGINAL WORK AND OPINION.

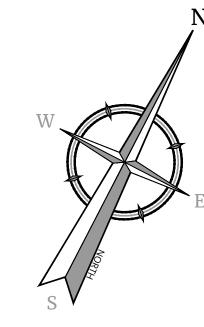

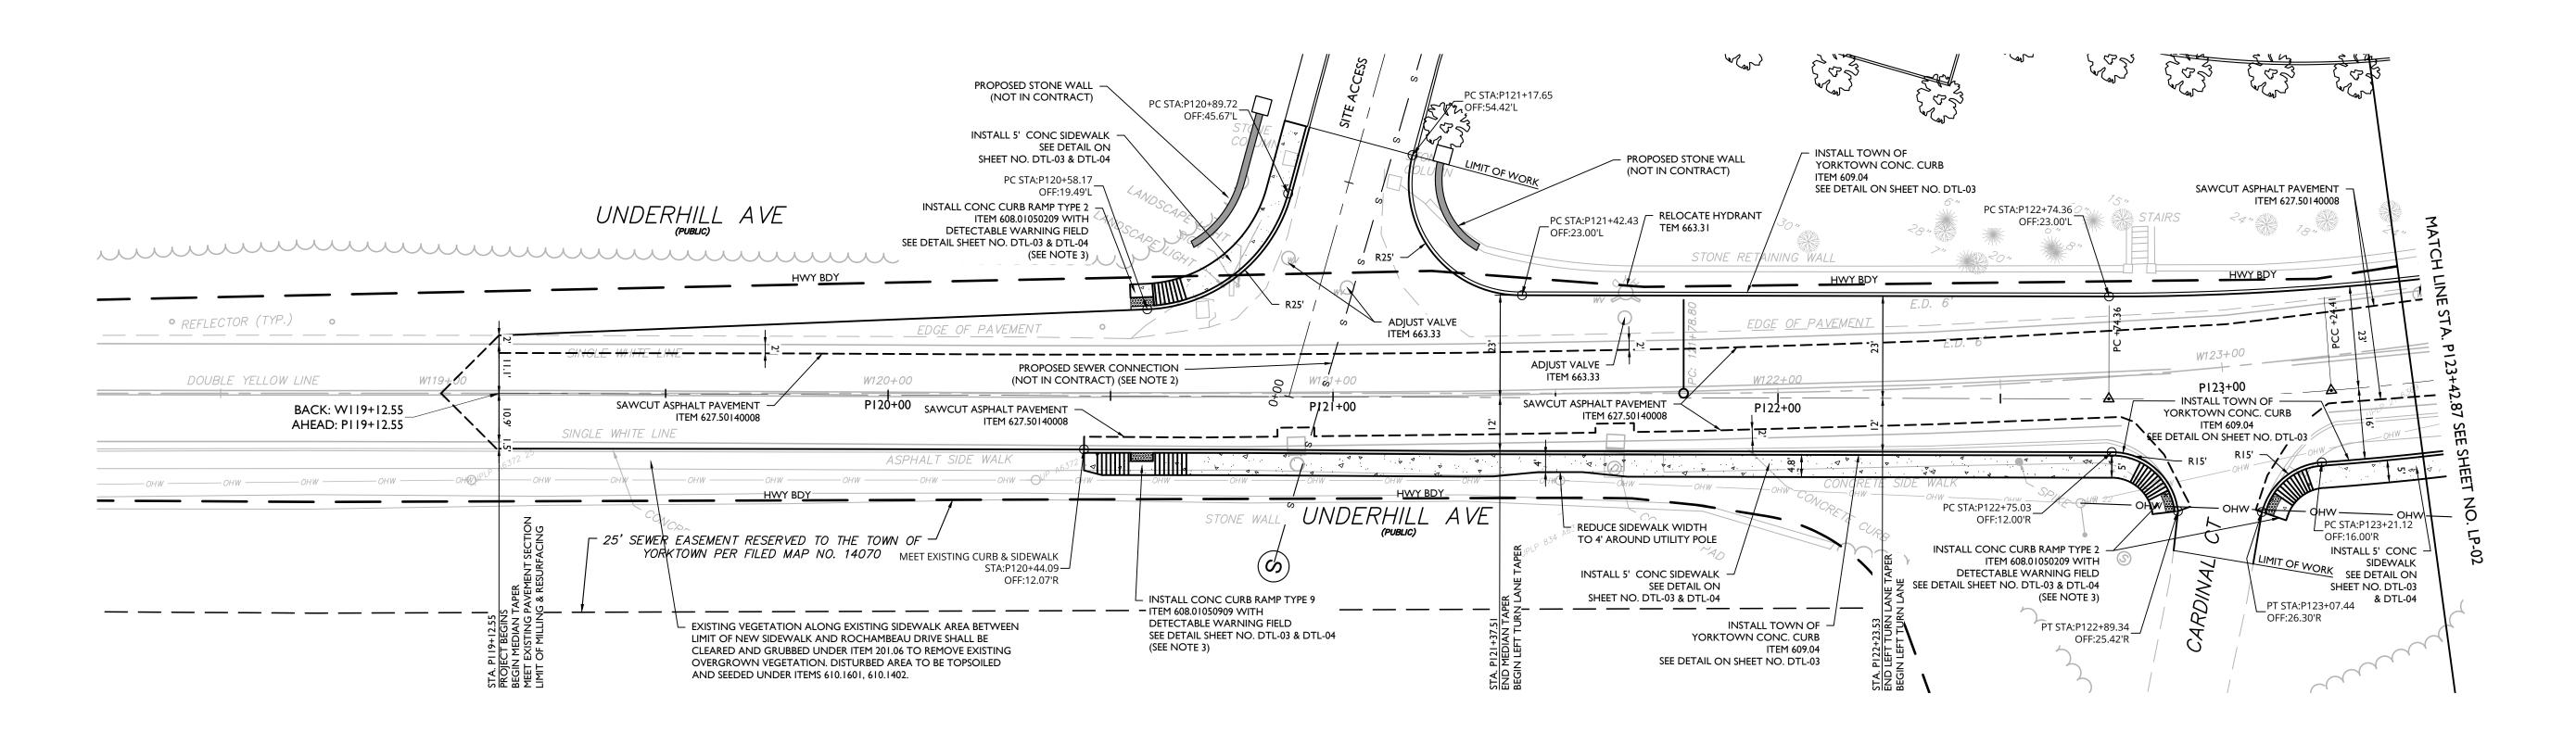

- UTILITY POLE RELOCATIONS SHOWN FOR INVENTORY PURPOSES ONLY. UTILITY RELOCATIONS SHALL BE COMPLETED BY THE ENTITY HAVING JURISDICTION THEREOVER.
- PROPOSED SEWER CONNECTION IS NOT INCLUDED AS PART OF THIS CONTRACT AND SHALL BE COMPLETED BY SOUNDVIEW SITE CONTRACTOR. COORDINATION OF WORK WILL BE REQUIRED TO ENSURE SEWER INSTALLATION IS COORDINATED WITH PROPOSED DRAINAGE WORK ON THE SOUTH SIDE OF UNDERHILL AVENUE AND IS COMPLETED PRIOR TO FINAL PAVING OF UNDERHILL AVENUE.
- CURB RAMP EXCAVATION SHALL BE PAID UNDER ITEM 608.02010015. CURB RAMP 6" SUBBASE SHALL BE PAID FOR UNDER ITEM 608.02020015.

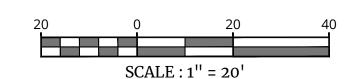

Linear unit of measure: US Survey Foot (1 ft = 1200/3937 m)

Colliers

Engineering & Design

www.colliersengineering.com

ALL STATES REQUIRE NOTIFICATION OF EXCAVATORS, DESIGNERS, OR ANY PERSON PREPARING TO DISTURB THE EARTH'S SURFACE ANYWHERE IN ANY STATE

FOR STATE SPECIFIC DIRECT PHONE NUMBERS VISIT: WWW.CALL811.COM



Philip John Grealy NEW YORK LICENSED PROFESSIONAL ENGINEER LICENSE NUMBER: 059858-1 COLLIERS ENGINEERING & DESIGN CT, P.C. N.Y. C.O.A #: 0017609

HIGHWAY IMPROVEMENT PLANS

UNDERHILL AVENUE **IMPROVEMENTS** (SEQR # 22-092)

NYS ROUTE 118 (S.H. 148) AT UNDERHILL AVENUE

TOWN OF YORKTOWN WESTCHESTER COUNTY NEW YORK

Colliers

& Design

WESTCHESTER 400 Columbus Avenue, Suite 180E Engineering


Valhalla, NY 10595 Phone: 914.347.7500 ARCHITECTURE, LANDSCAPE ARCHITECTU SURVEYING CT, P.C.


1/8/23 AS SHOWN R-PL06-CNST 20006297A

LAYOUT & CONSTRUCTION PLAN

LP-01

UNAUTHORIZED ALTERATION OR ADDITION TO A SURVEY OR ENGINEERING MAP BEARING A LICENSED LAND SURVEYOR OR PROFESSIONAL ENGINEER IS A VIOLATION OF SECTION 7209, SUB-DIVISION 2, OF THE NEW YORK STATE EDUCATION LAW. ONLY MAPS WITH THE LAND SURVEYOR OR PROFESSIONAL ENGINEER'S SEAL ARE GENUINE TRUE AND CORRECT COPIES OF THE LAND SURVEYOR OR PROFESSIONAL ENGINEER'S ORIGINAL WORK AND OPINION.

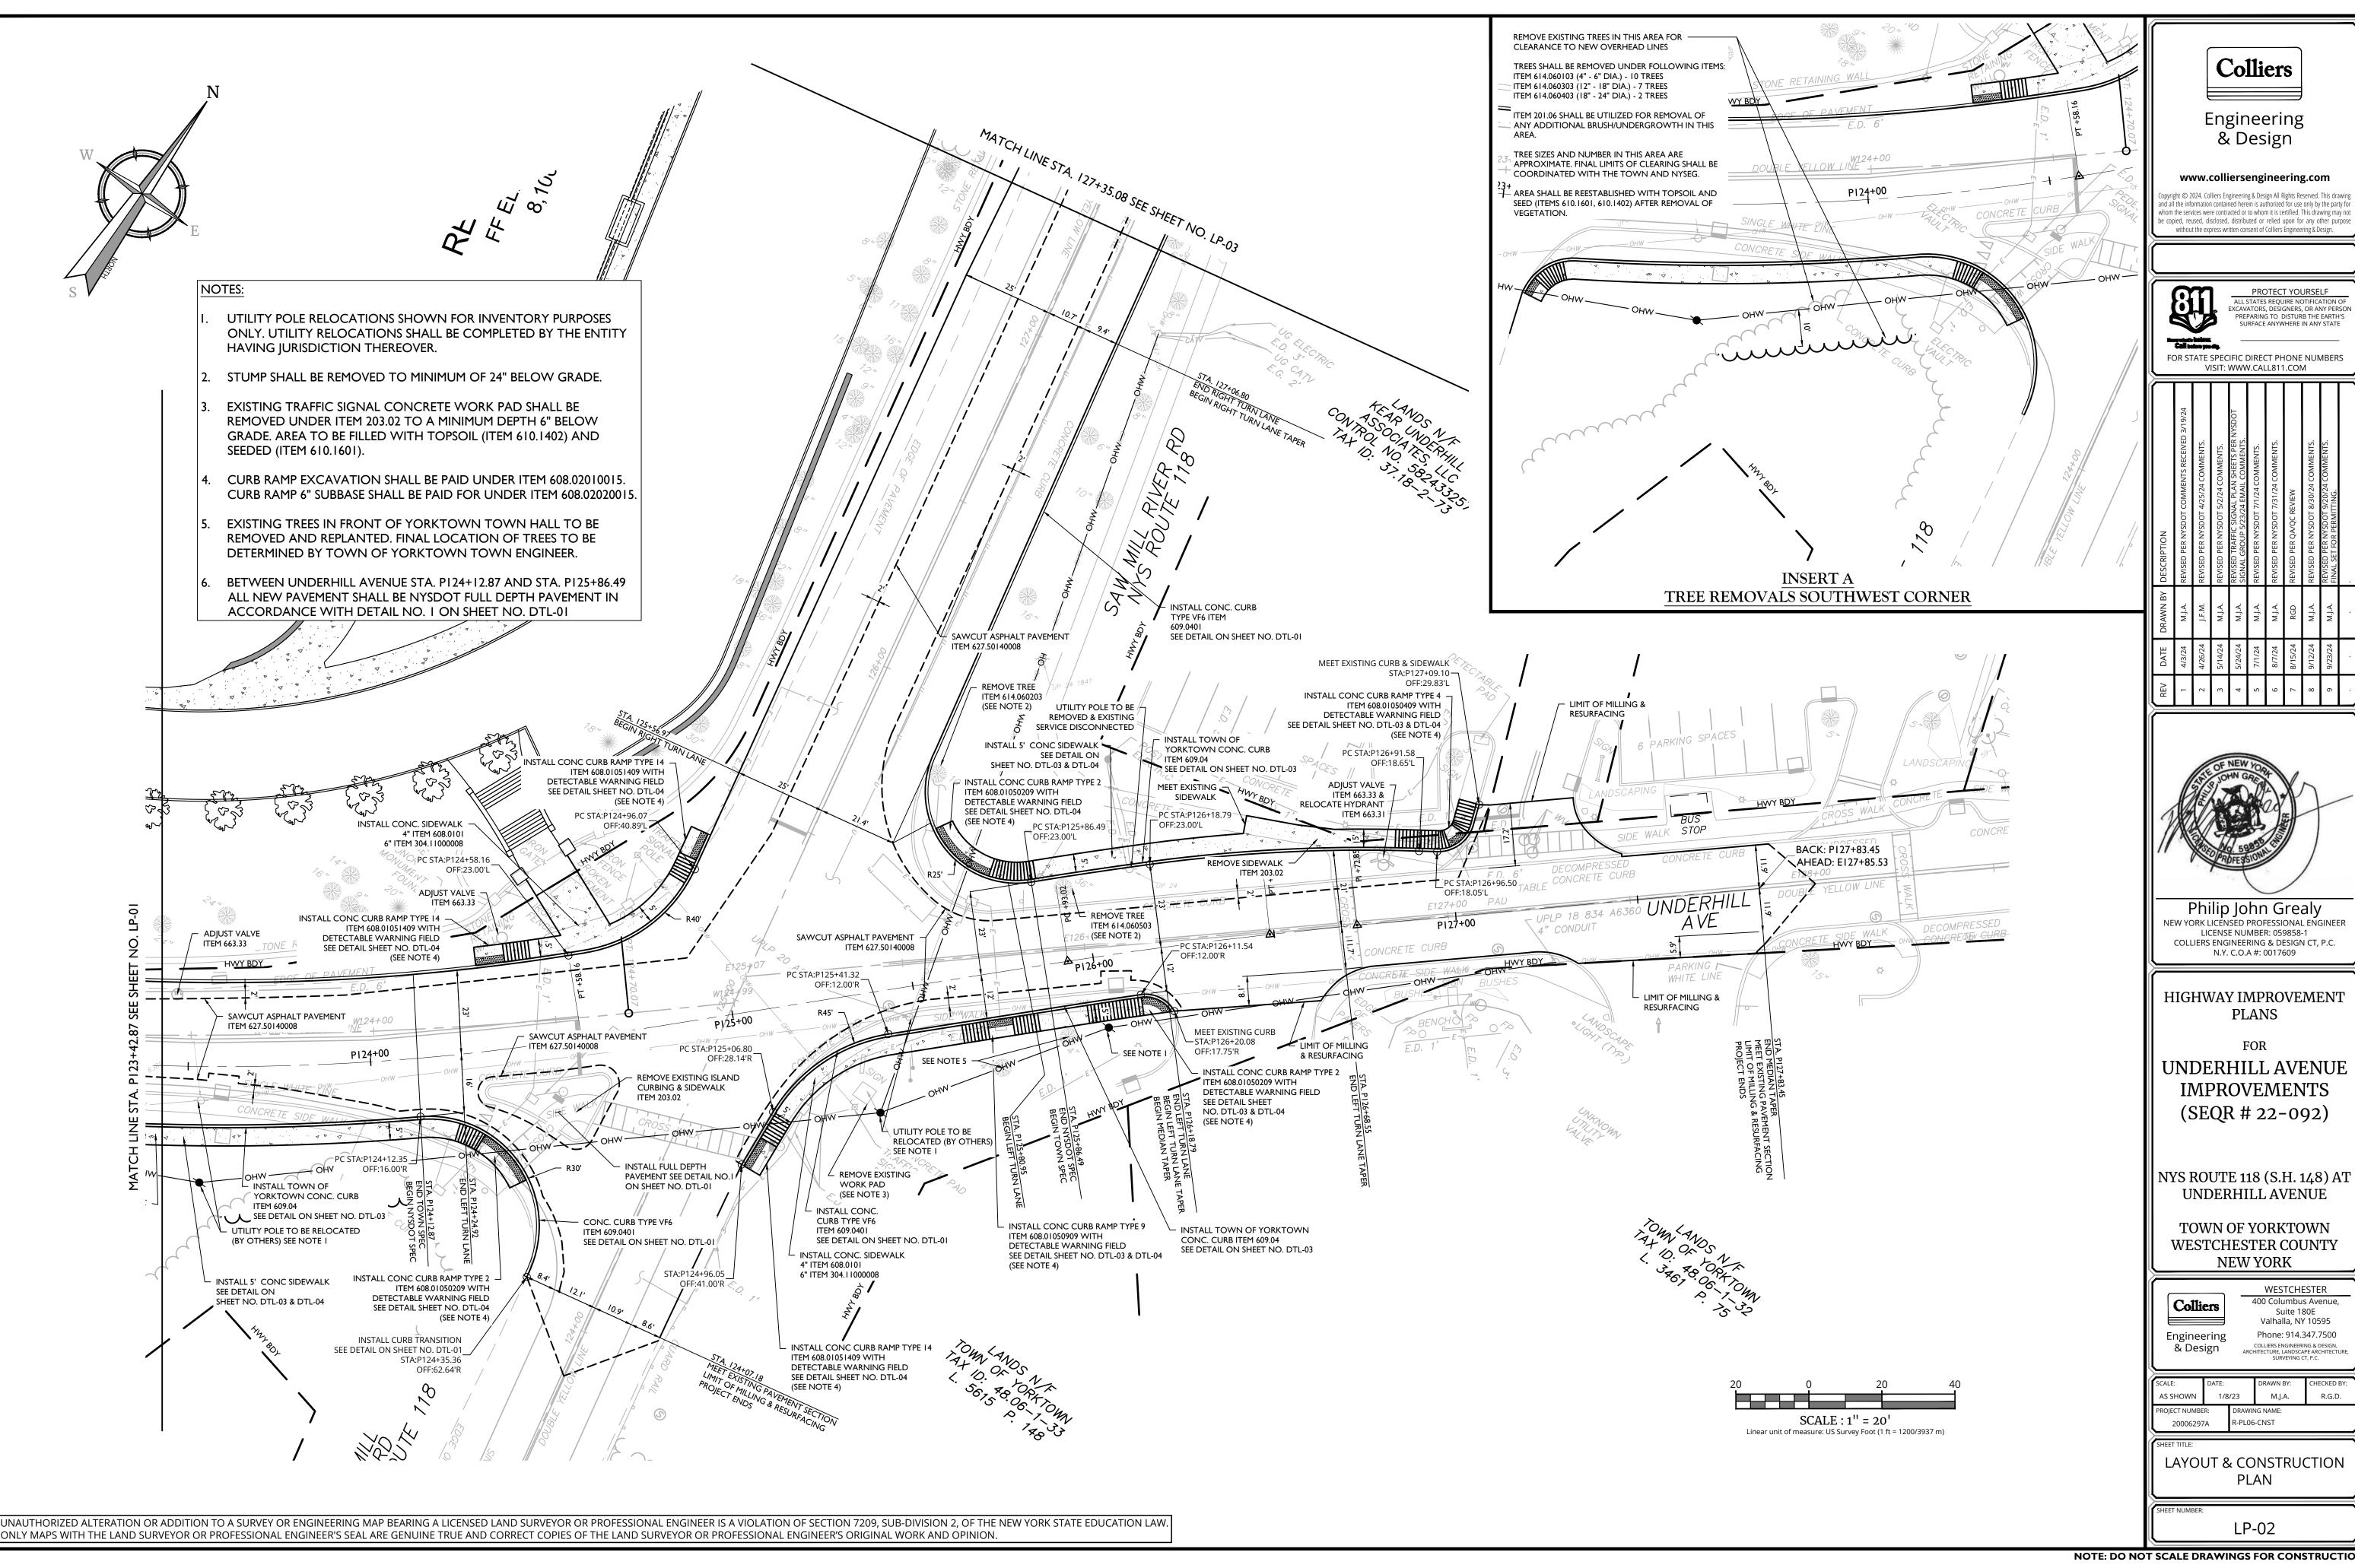

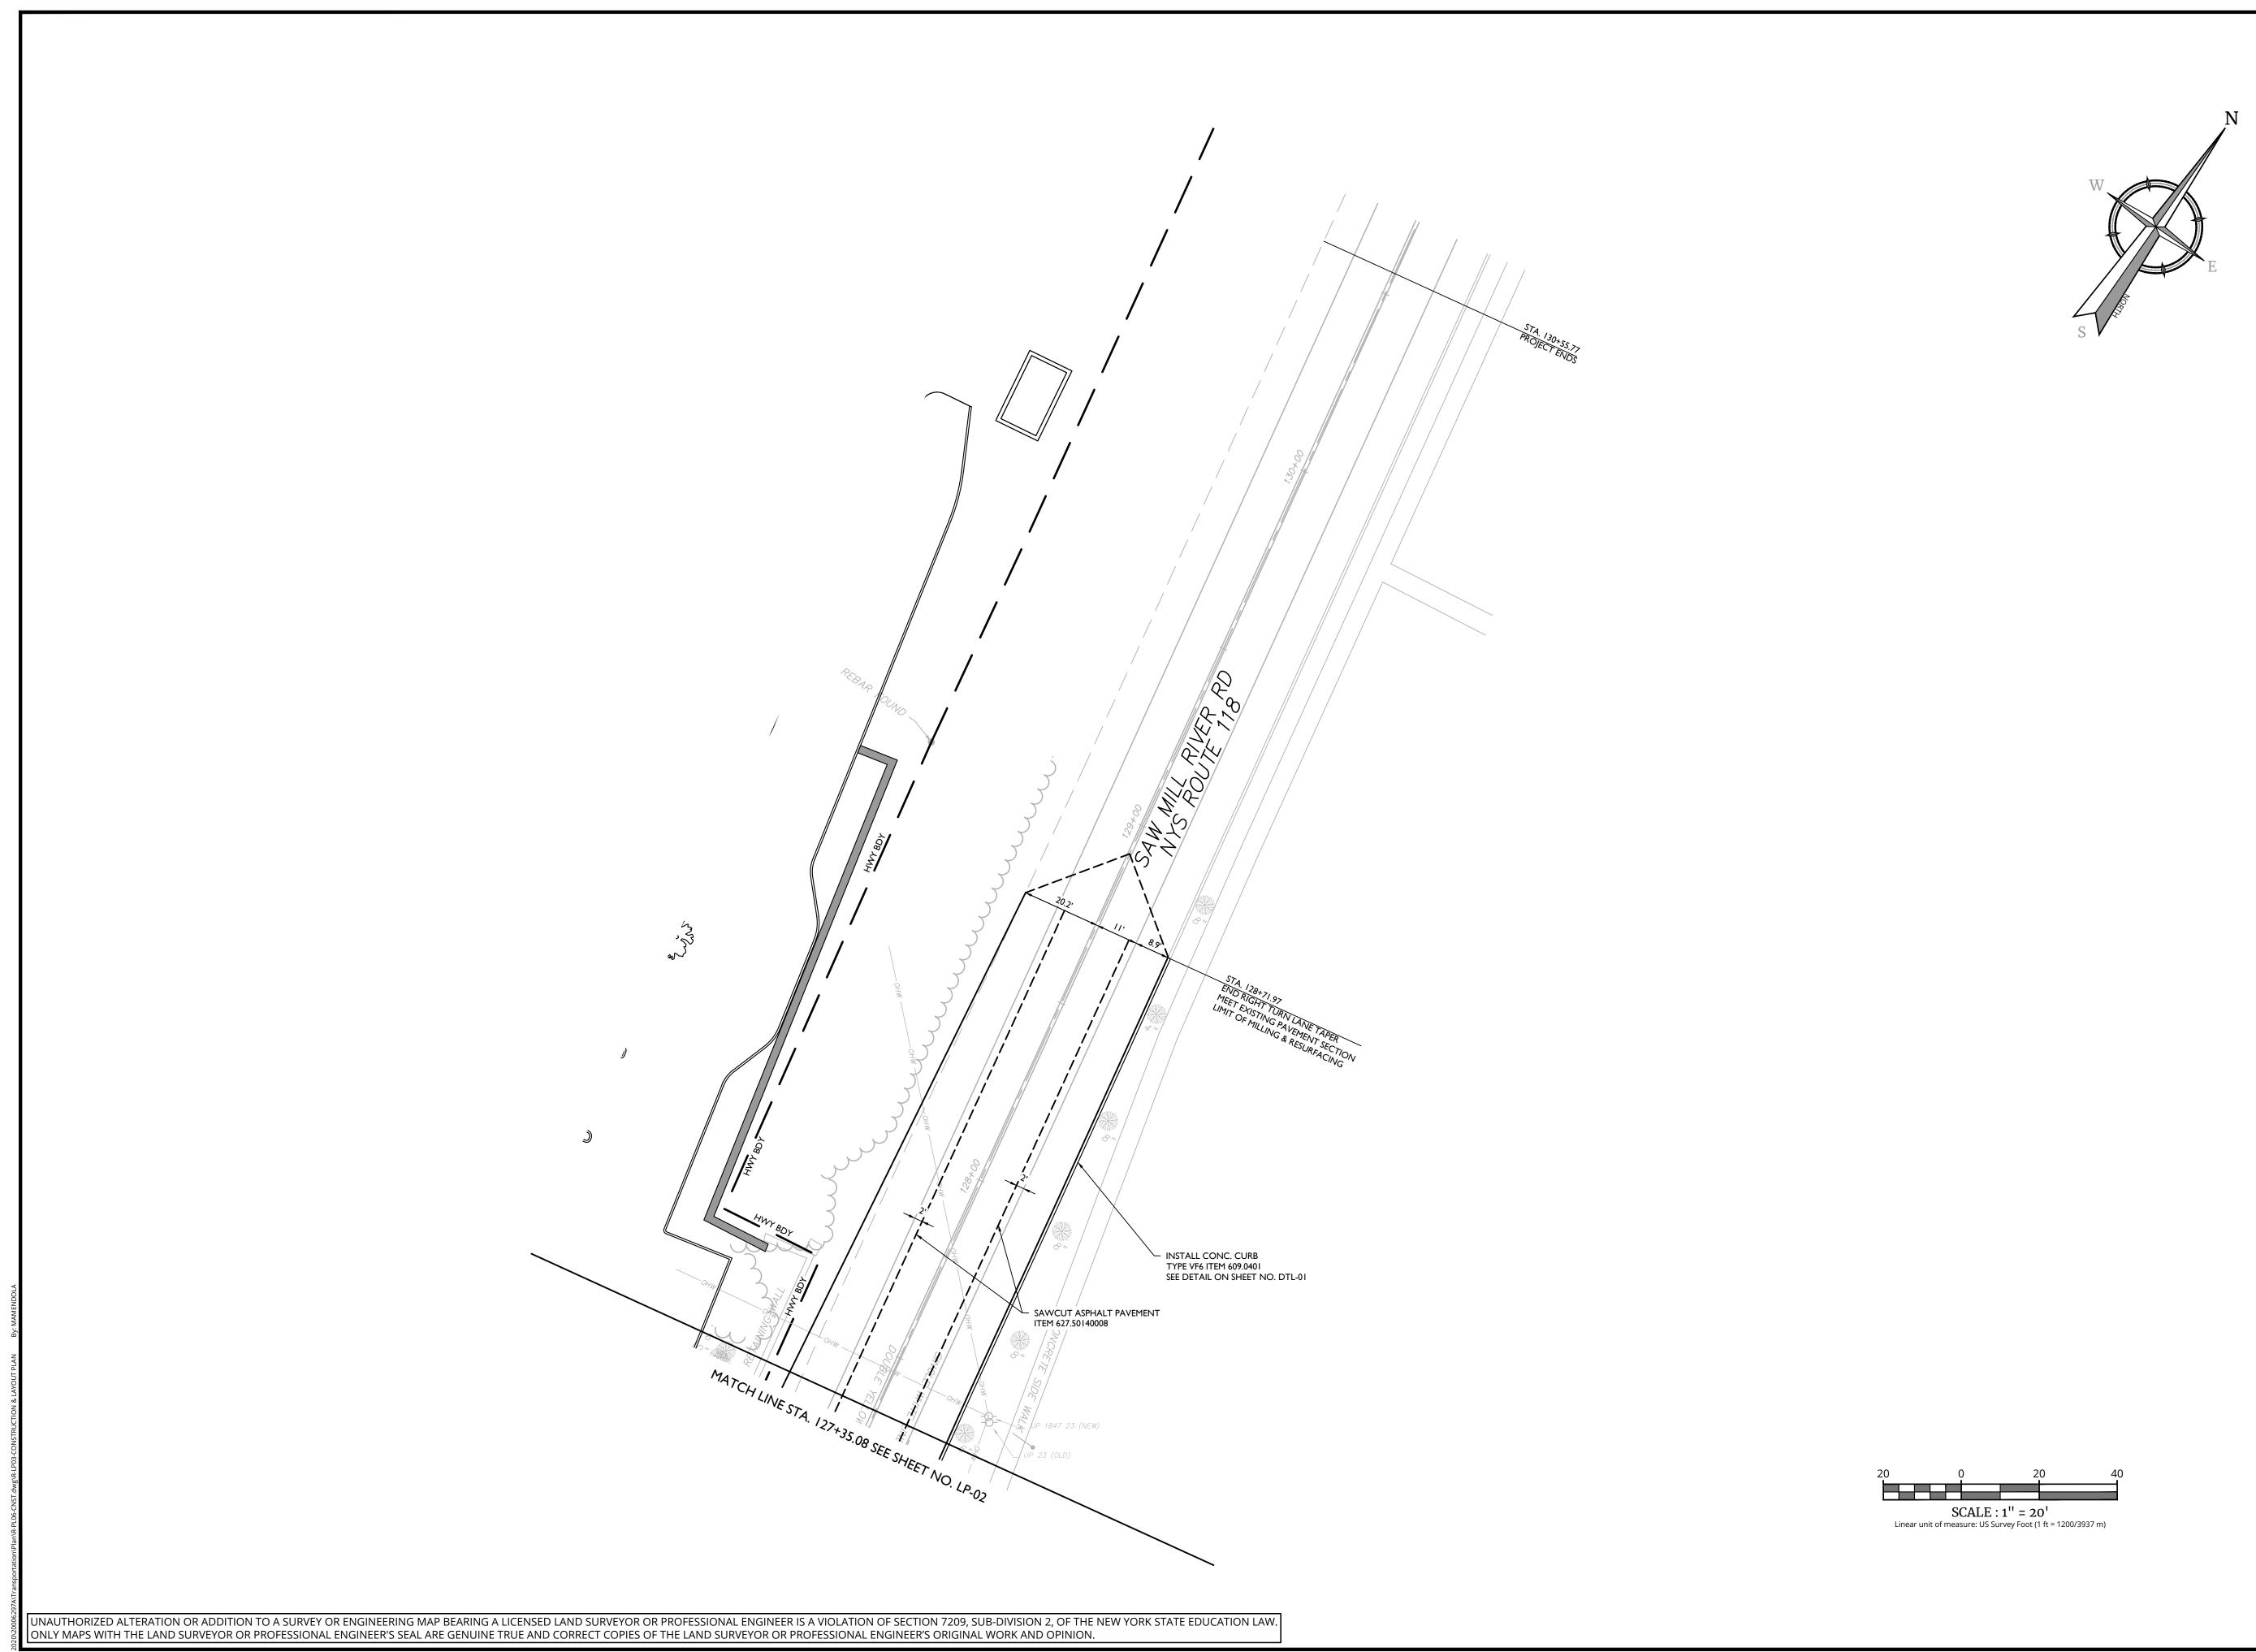



Engineering & Design

be copied, reused, disclosed, distributed or relied upon for any other purp



PROTECT YOURSELF

ALL STATES REQUIRE NOTIFICATION OF EXCAVATORS, DESIGNERS, OR ANY PERSON PREPARING TO DISTURB THE EARTH'S SURFACE ANYWHERE IN ANY STATE

FOR STATE SPECIFIC DIRECT PHONE NUMBERS VISIT: WWW.CALL811.COM

DRAWN BY DESCRIPTION	M.J.A. REVISED PER NYSDOT COMMENTS RECEIVED 3/19/24	J.F.M. REVISED PER NYSDOT 4/25/24 COMMENTS.	M.J.A. REVISED PER NYSDOT 5/2/24 COMMENTS.	M.J.A. REVISED TRAFFIC SIGNAL PLAN SHEETS PER NYSDOT SIGNAL GROUP 5/23/24 EMAIL COMMENTS.	M.J.A. REVISED PER NYSDOT 7/1/24 COMMENTS.	M.J.A. REVISED PER NYSDOT 7/31/24 COMMENTS.	REVISED PER QA/QC REVIEW	M.J.A. REVISED PER NYSDOT 8/30/24 COMMENTS.	M.J.A. REVISED PER NYSDOT 9/20/24 COMMENTS. FINAL SET FOR PERMITTING.	
DATE	4/3/24	4/26/24	5/14/24	5/24/24	7/1/24	8/7/24	8/15/24	9/12/24	9/23/24	
REV	1	2	3	4	5	9	7	8	6	



Philip John Grealy
NEW YORK LICENSED PROFESSIONAL ENGINEER
LICENSE NUMBER: 059858-1
COLLIERS ENGINEERING & DESIGN CT, P.C.
N.Y. C.O.A #: 0017609

HIGHWAY IMPROVEMENT **PLANS**

FOR

UNDERHILL AVENUE **IMPROVEMENTS** (SEQR # 22-092)

NYS ROUTE 118 (S.H. 148) AT UNDERHILL AVENUE

TOWN OF YORKTOWN WESTCHESTER COUNTY **NEW YORK**

Colliers

Engineering & Design


WESTCHESTER 400 Columbus Avenue, Suite 180E Valhalla, NY 10595

Phone: 914.347.7500

AS SHOWN 1/8/23 R-PL06-CNST 20006297A

LAYOUT & CONSTRUCTION PLAN

LP-03

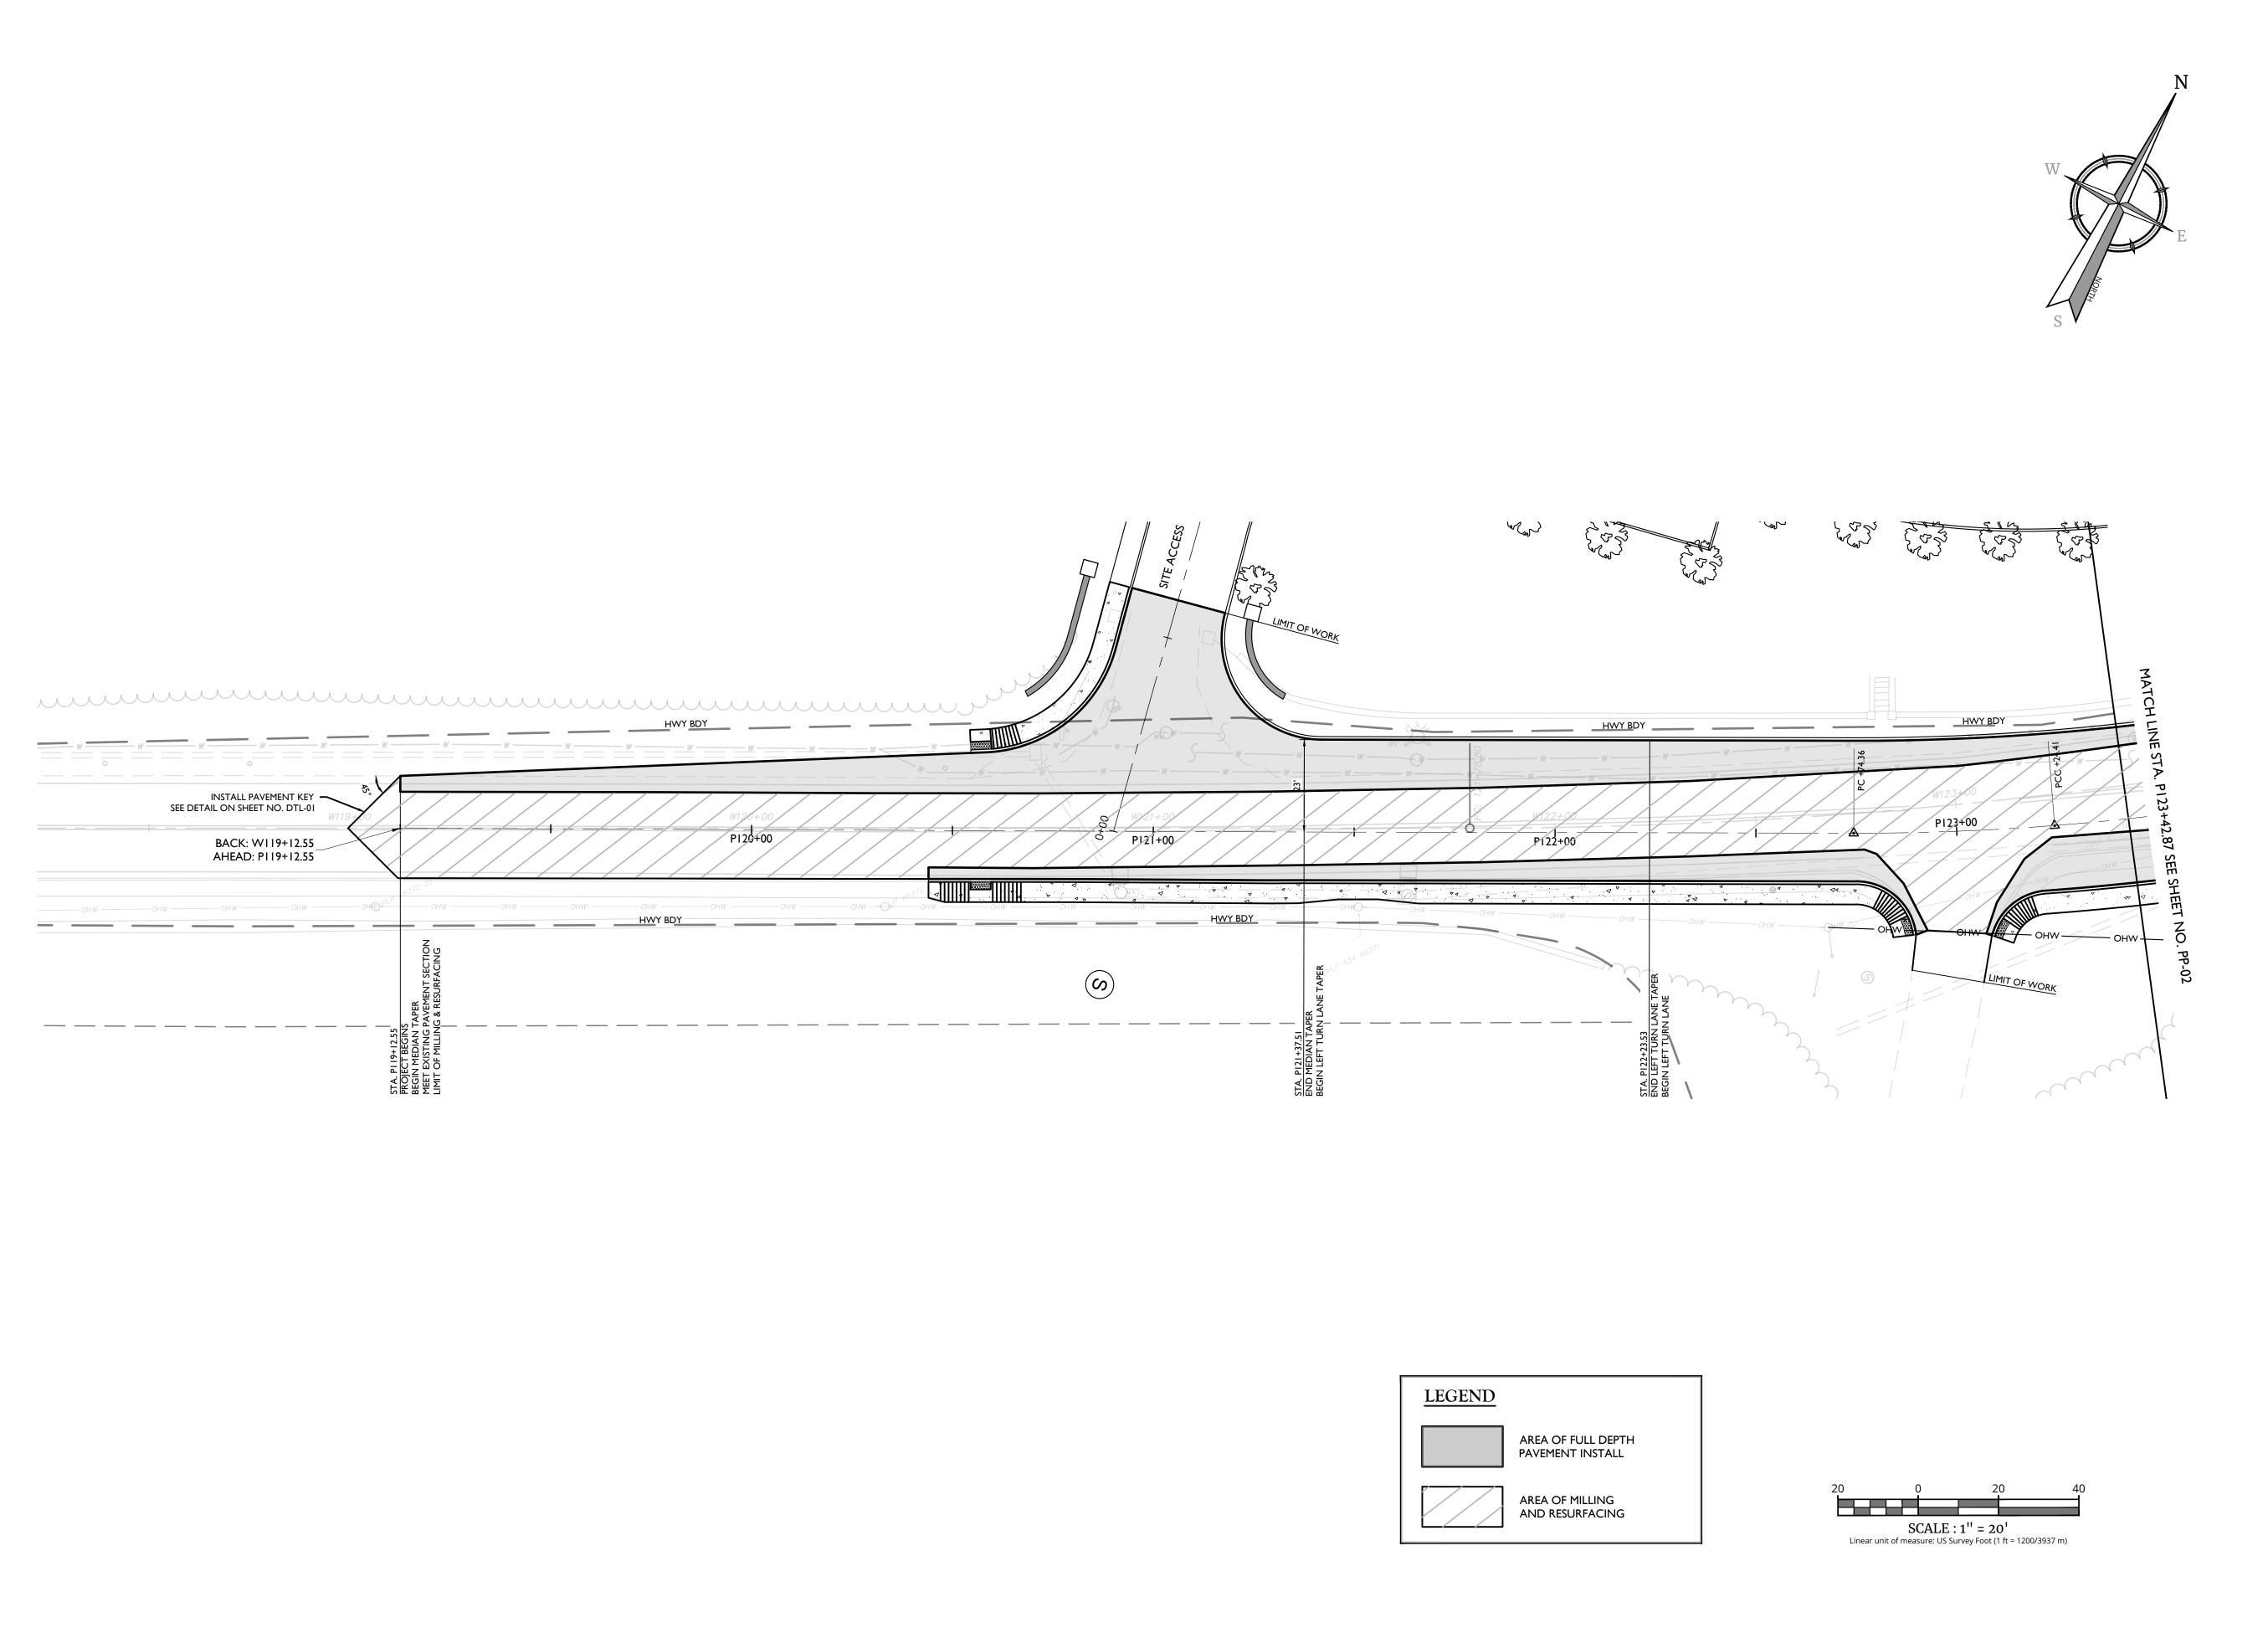

UNAUTHORIZED ALTERATION OR ADDITION TO A SURVEY OR ENGINEERING MAP BEARING A LICENSED LAND SURVEYOR OR PROFESSIONAL ENGINEER IS A VIOLATION OF SECTION 7209, SUB-DIVISION 2, OF THE NEW YORK STATE EDUCATION LAW.

ONLY MAPS WITH THE LAND SURVEYOR OR PROFESSIONAL ENGINEER'S SEAL ARE GENUINE TRUE AND CORRECT COPIES OF THE LAND SURVEYOR OR PROFESSIONAL ENGINEER'S ORIGINAL WORK AND OPINION.

Colliers

Engineering & Design

www.colliersengineering.com

be copied, reused, disclosed, distributed or relied upon for any other purpo

PROTECT YOURSELF

ALL STATES REQUIRE NOTIFICATION OF EXCAVATORS, DESIGNERS, OR ANY PERSON PREPARING TO DISTURB THE EARTH'S SURFACE ANYWHERE IN ANY STATE

FOR STATE SPECIFIC DIRECT PHONE NUMBERS VISIT: WWW.CALL811.COM

REV	DATE	DRAWN BY	DESCRIPTION
1	4/3/24	M.J.A.	REVISED PER NYSDOT COMMENTS RECEIVED 3/19/24
2	4/26/24	J.F.M.	REVISED PER NYSDOT 4/25/24 COMMENTS.
3	5/14/24	M.J.A.	REVISED PER NYSDOT 5/2/24 COMMENTS.
4	5/24/24	M.J.A.	REVISED TRAFFIC SIGNAL PLAN SHEETS PER NYSDOT SIGNAL GROUP 5/23/24 EMAIL COMMENTS.
5	7/1/24	M.J.A.	REVISED PER NYSDOT 7/1/24 COMMENTS.
9	8/7/24	M.J.A.	REVISED PER NYSDOT 7/31/24 COMMENTS.
7	8/15/24	RGD	REVISED PER QA/QC REVIEW
8	9/12/24	M.J.A.	REVISED PER NYSDOT 8/30/24 COMMENTS.
6	9/23/24	M.J.A.	REVISED PER NYSDOT 9/20/24 COMMENTS. FINAL SET FOR PERMITTING.
·J	٠		



Philip John Grealy
NEW YORK LICENSED PROFESSIONAL ENGINEER
LICENSE NUMBER: 059858-1 COLLIERS ENGINEERING & DESIGN CT, P.C. N.Y. C.O.A #: 0017609

HIGHWAY IMPROVEMENT **PLANS**

FOR

UNDERHILL AVENUE **IMPROVEMENTS** (SEQR # 22-092)

NYS ROUTE 118 (S.H. 148) AT UNDERHILL AVENUE

TOWN OF YORKTOWN WESTCHESTER COUNTY **NEW YORK**

Colliers

& Design


WESTCHESTER 400 Columbus Avenue, Suite 180E Valhalla, NY 10595 Engineering


Phone: 914.347.7500 COLLIERS ENGINEERING & DESIGN, ARCHITECTURE, LANDSCAPE ARCHITECTURE SURVEYING CT, P.C.

AS SHOWN 1/8/23 R-PL07-PAVE 20006297A

PAVING PLAN

PP-01

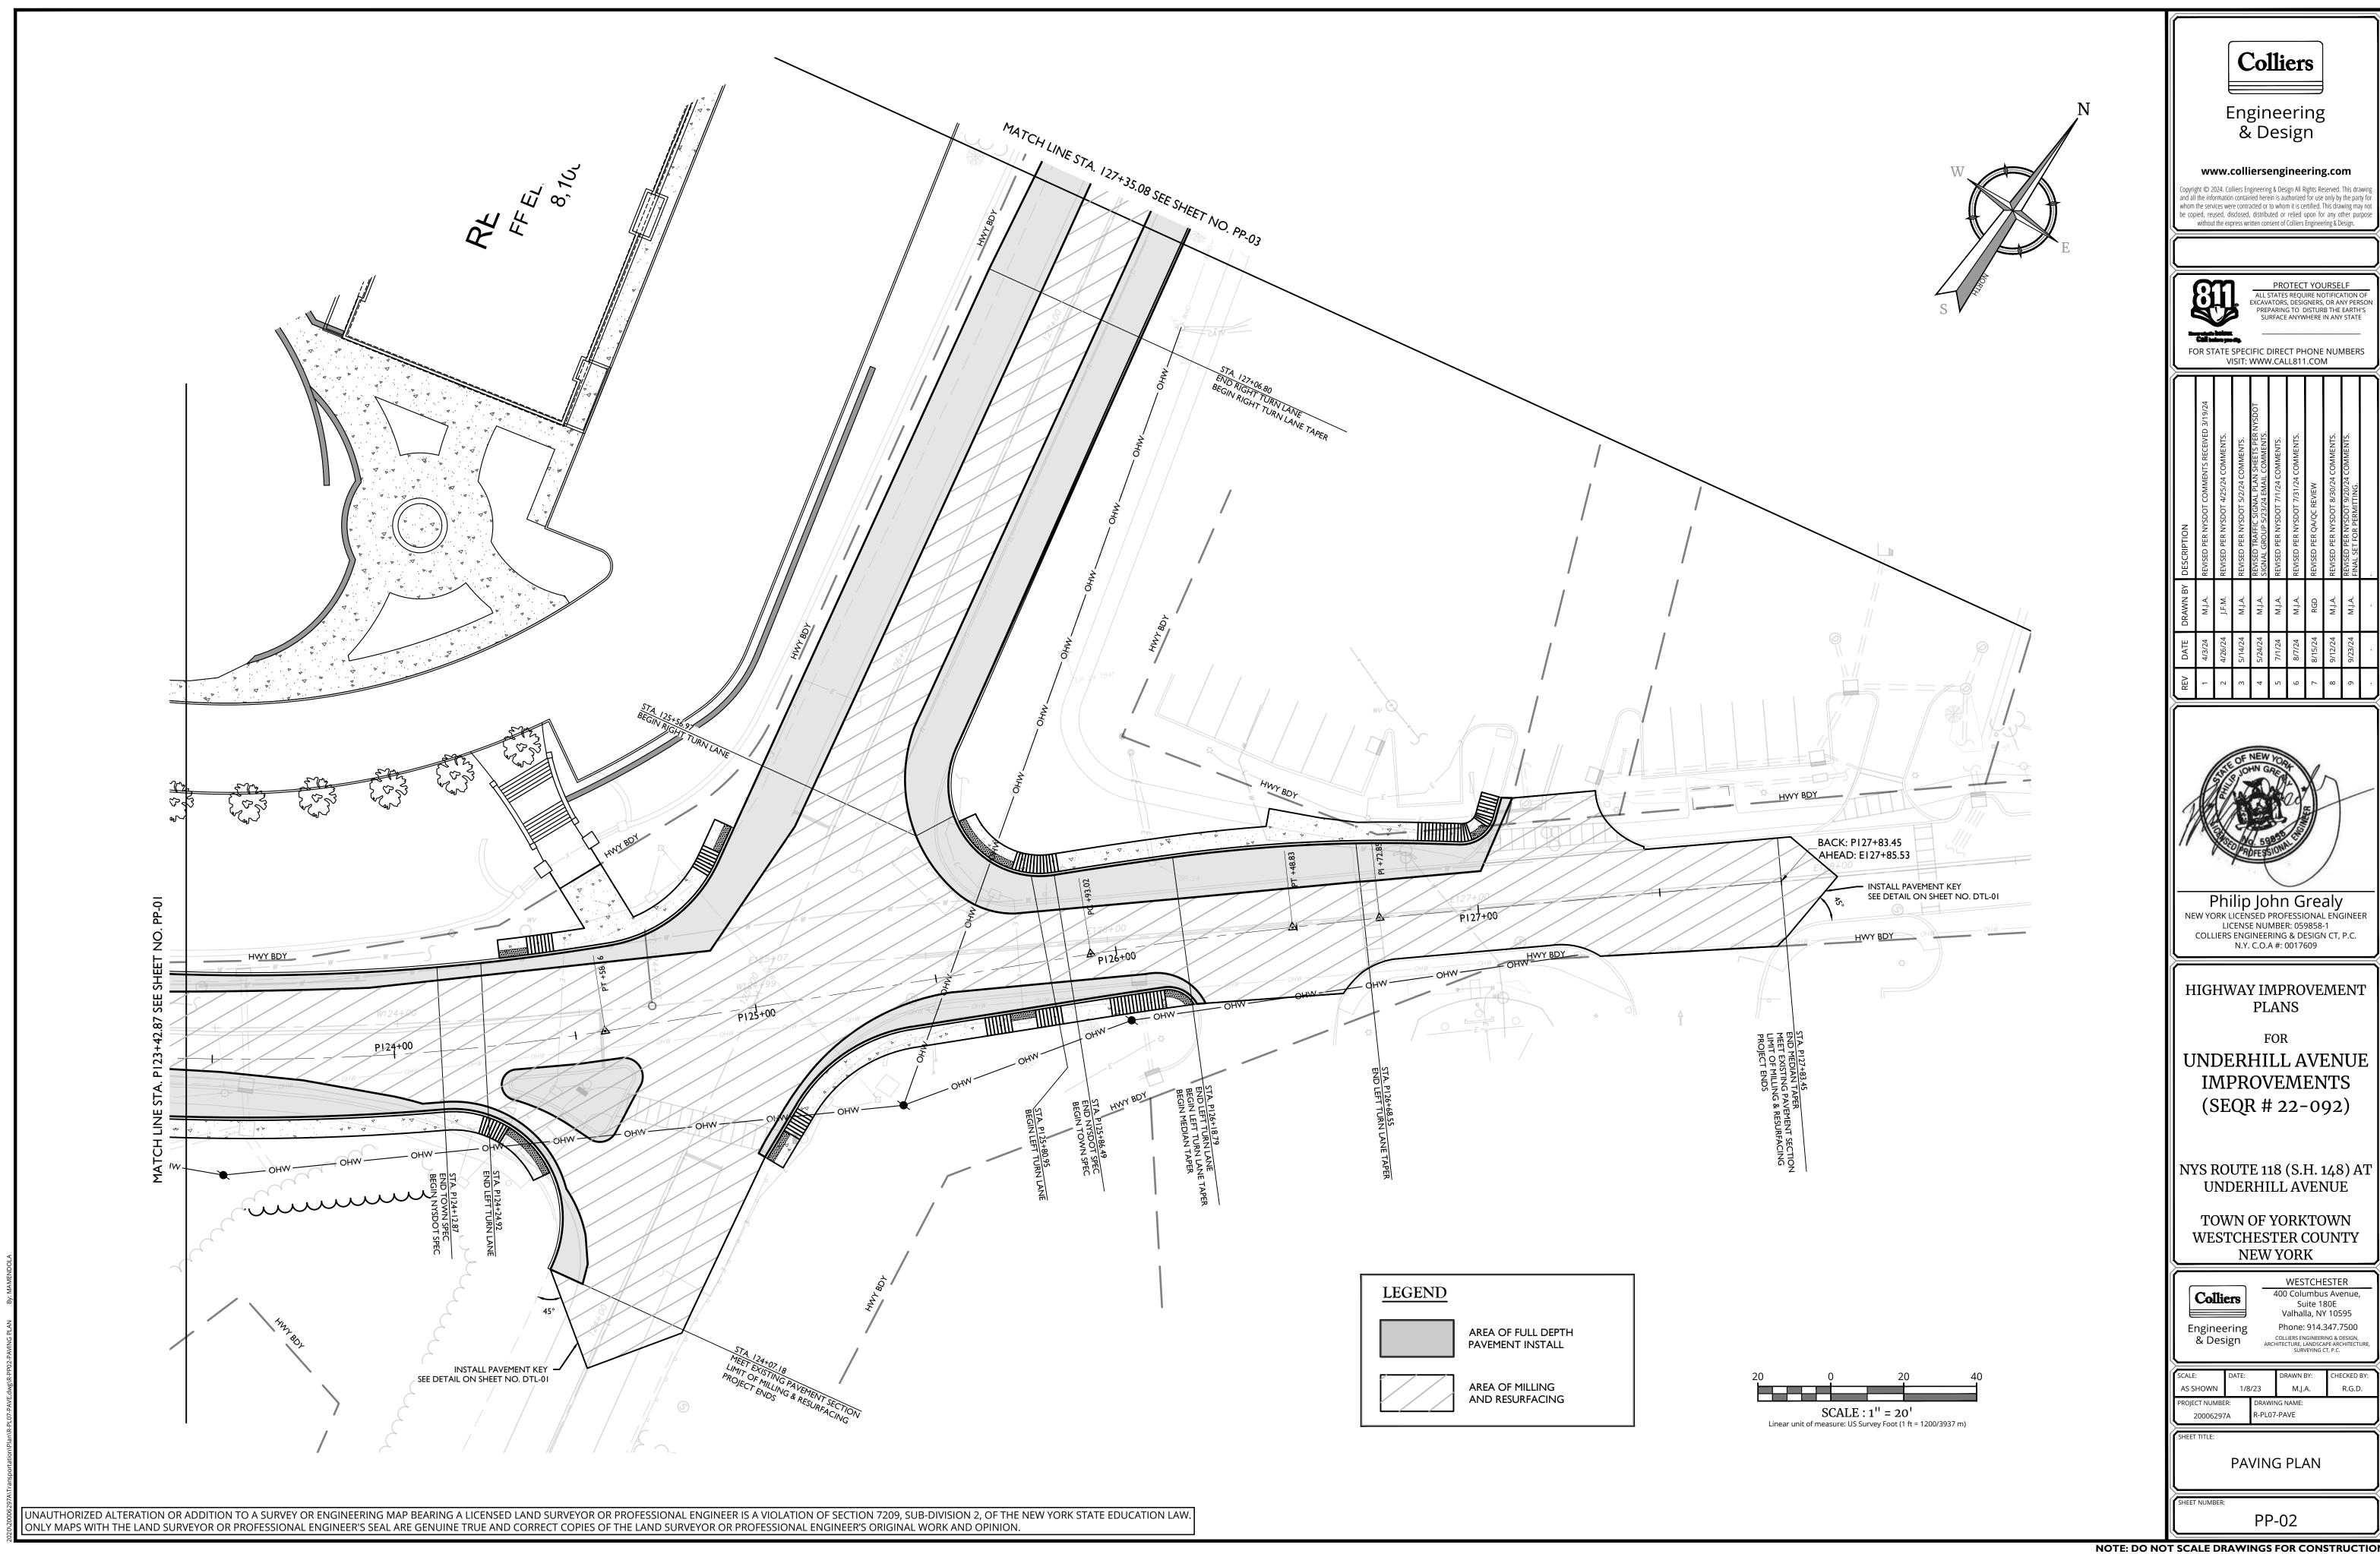

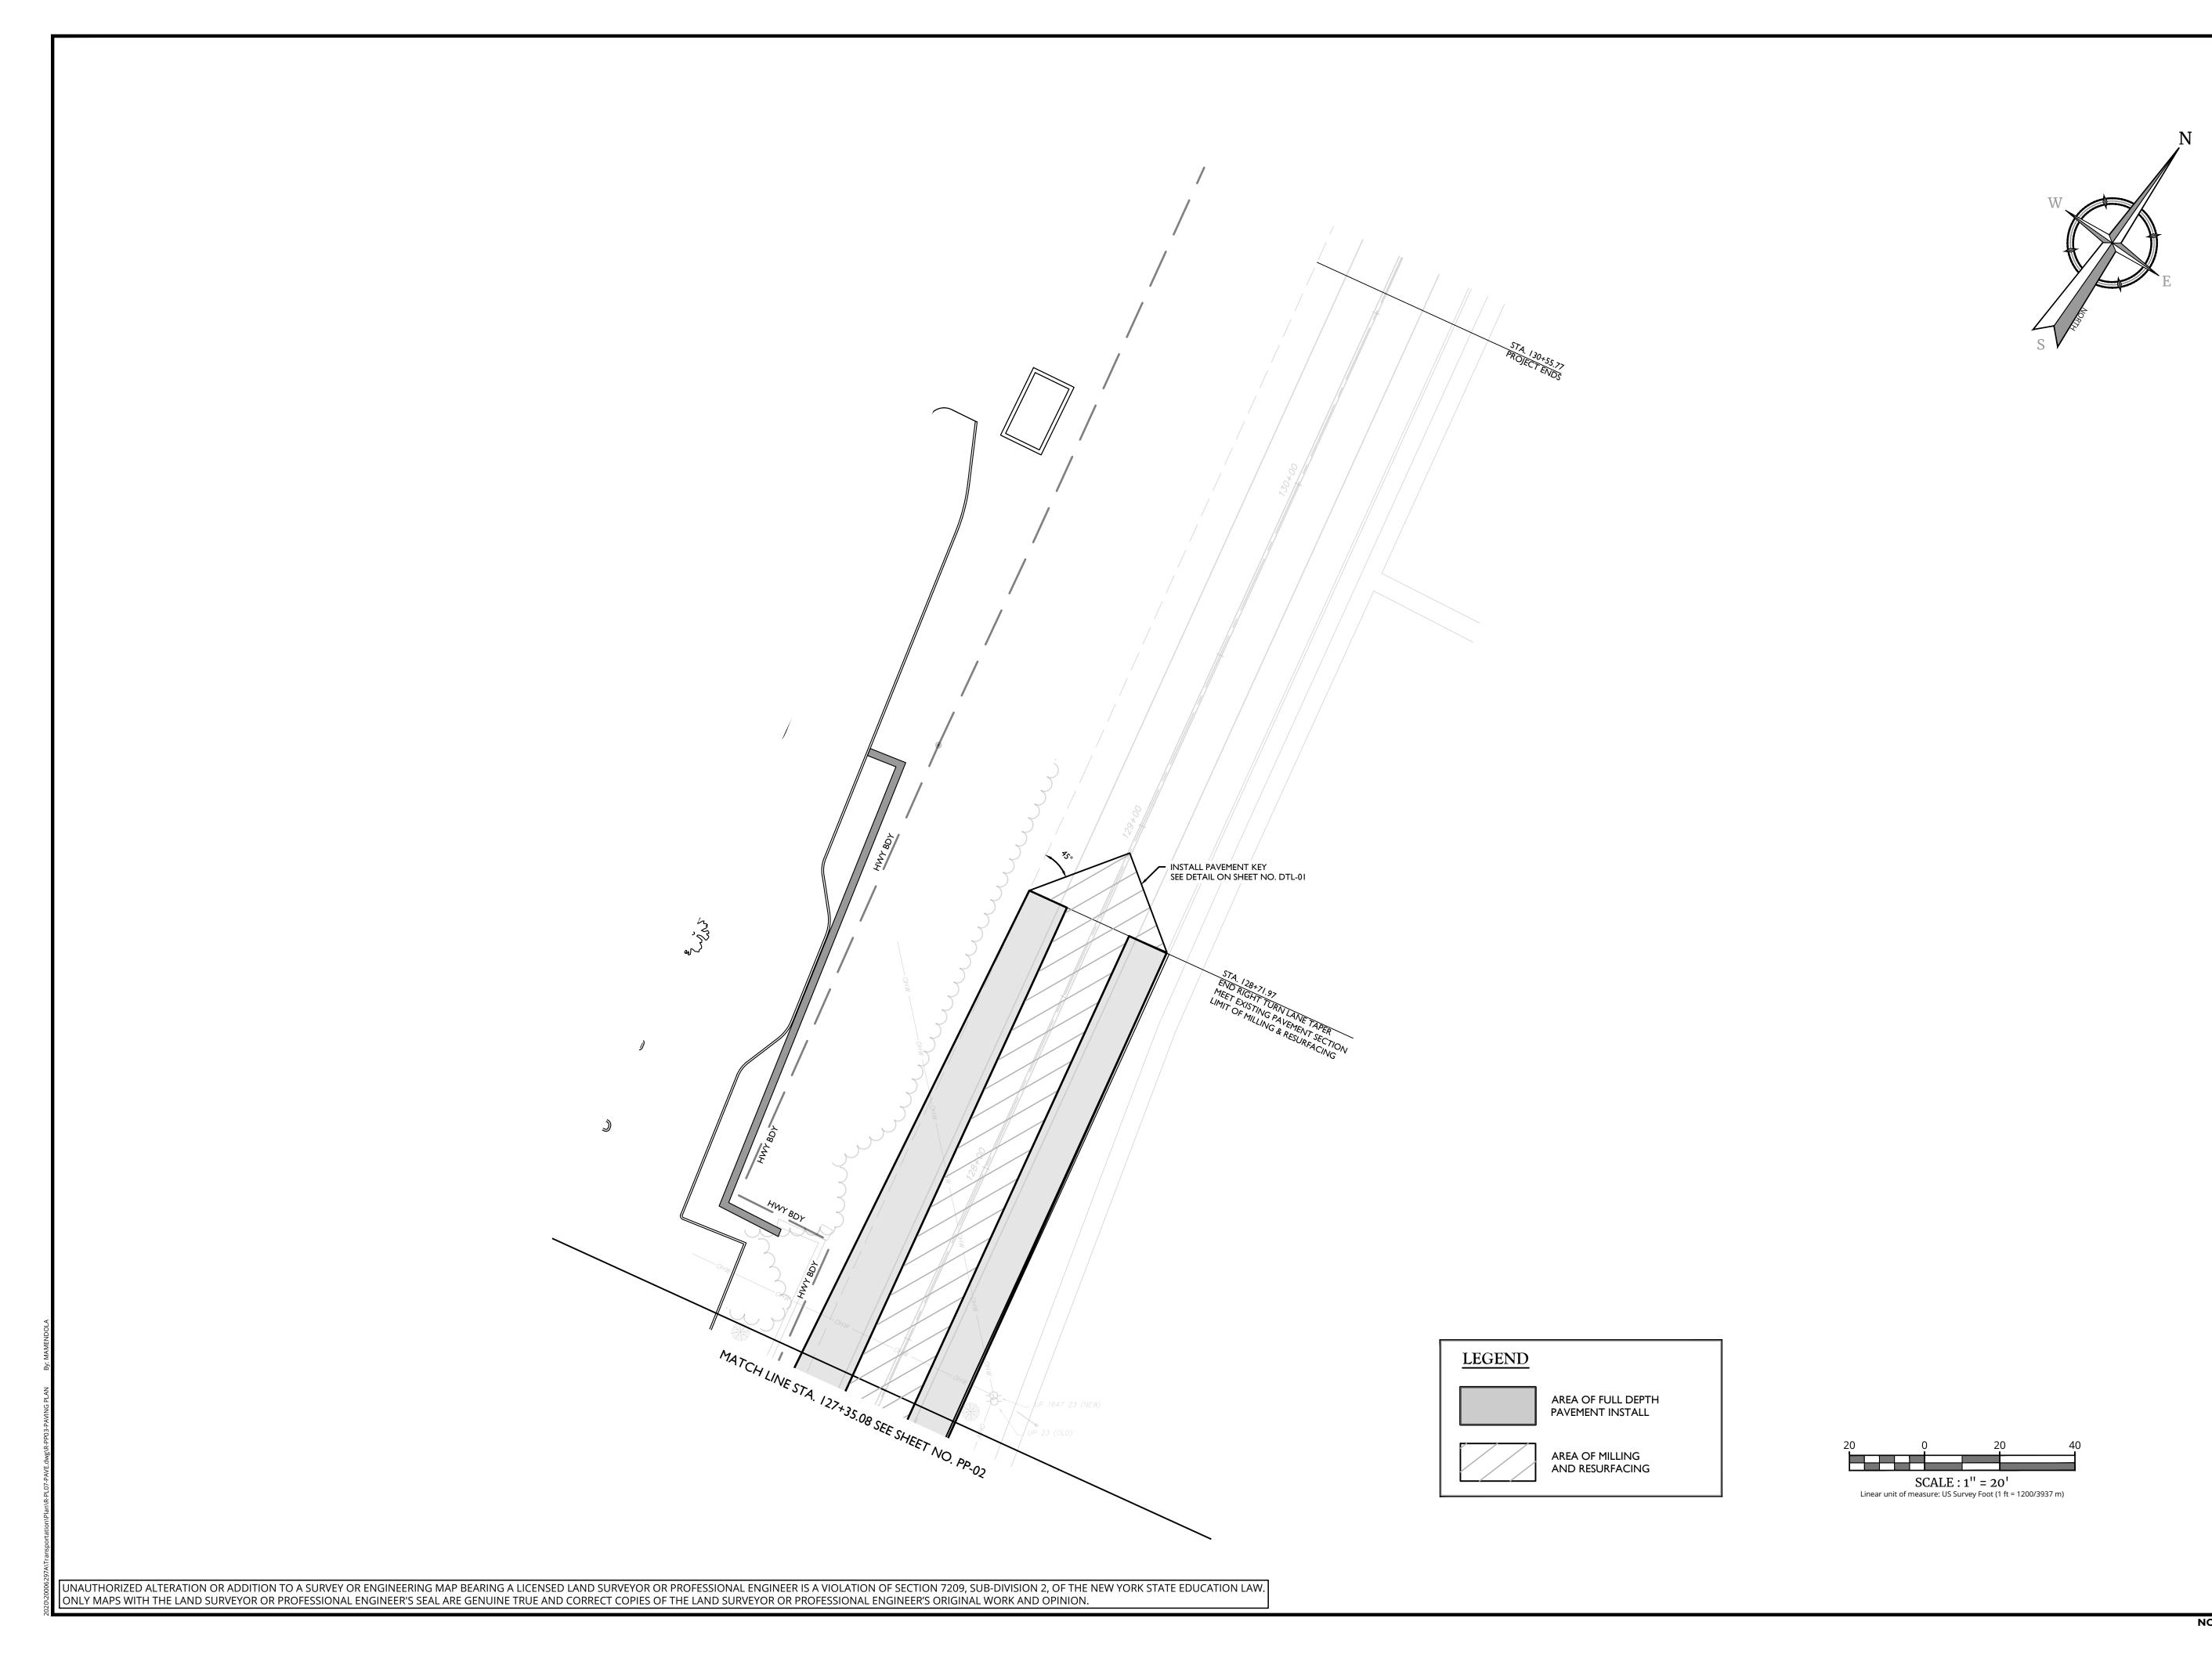



Engineering & Design

www.colliersengineering.com

Copyright © 2024. Colliers Engineering & Design All Rights Reserved. This drawing and all the information contained herein is authorized for use only by the party for whom the services were contracted or to whom it is certified. This drawing may no be copied, reused, disclosed, distributed or relied upon for any other purpos

PROTECT YOURSELF
ALL STATES REQUIRE NOTIFICATION OF EXCAVATORS, DESIGNERS, OR ANY PERSON PREPARING TO DISTURB THE EARTH'S SURFACE ANYWHERE IN ANY STATE

FOR STATE SPECIFIC DIRECT PHONE NUMBERS VISIT: WWW.CALL811.COM

REV	DATE	DRAWN BY	DESCRIPTION
_	4/3/24	M.J.A.	REVISED PER NYSDOT COMMENTS RECEIVED 3/19/24
2	4/26/24	J.F.M.	REVISED PER NYSDOT 4/25/24 COMMENTS.
8	5/14/24	M.J.A.	REVISED PER NYSDOT 5/2/24 COMMENTS.
4	5/24/24	M.J.A.	REVISED TRAFFIC SIGNAL PLAN SHEETS PER NYSDOT SIGNAL GROUP 5/23/24 EMAIL COMMENTS.
5	7/1/24	M.J.A.	REVISED PER NYSDOT 7/1/24 COMMENTS.
9	8/7/24	M.J.A.	REVISED PER NYSDOT 7/31/24 COMMENTS.
7	8/15/24	RGD	revised per qa/qc review
8	9/12/24	M.J.A.	REVISED PER NYSDOT 8/30/24 COMMENTS.
6	9/23/24	M.J.A.	REVISED PER NYSDOT 9/20/24 COMMENTS. FINAL SET FOR PERMITTING.



Philip John Grealy
NEW YORK LICENSED PROFESSIONAL ENGINEER
LICENSE NUMBER: 059858-1
COLLIERS ENGINEERING & DESIGN CT, P.C.
N.Y. C.O.A #: 0017609

HIGHWAY IMPROVEMENT **PLANS**

FOR

UNDERHILL AVENUE **IMPROVEMENTS** (SEQR # 22-092)

NYS ROUTE 118 (S.H. 148) AT UNDERHILL AVENUE

TOWN OF YORKTOWN WESTCHESTER COUNTY **NEW YORK**

Colliers

& Design


WESTCHESTER 400 Columbus Avenue, Suite 180E Valhalla, NY 10595 Engineering


Phone: 914.347.7500 COLLIERS ENGINEERING & DESIGN, ARCHITECTURE, LANDSCAPE ARCHITECTURE SURVEYING CT, P.C.

AS SHOWN 1/8/23 R-PL07-PAVE 20006297A


PAVING PLAN

PP-03

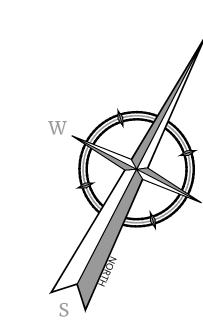

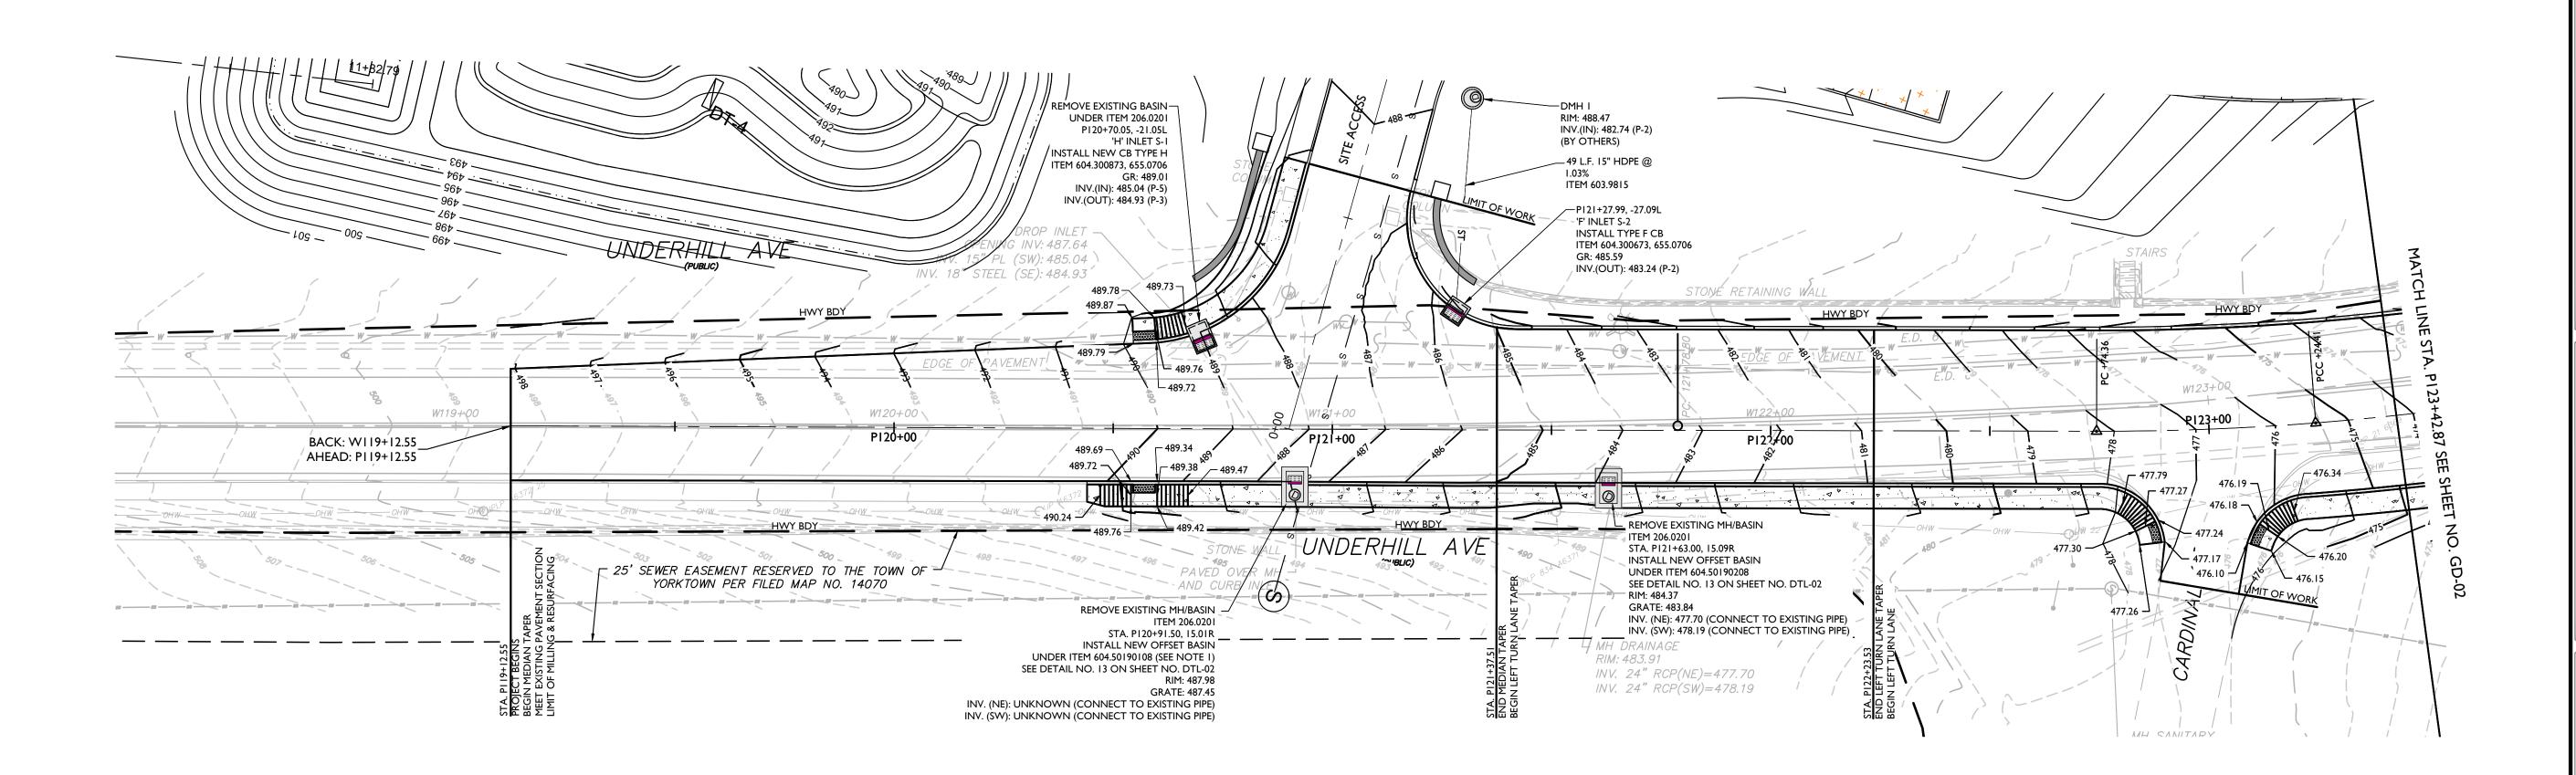

CONTRACTOR SHALL EXPOSE AND INSPECT STRUCTURE PRIOR TO WORK TO DETERMINE INVERTS OF EXISTING STRUCTURE. STRUCTURE SHALL BE CONNECTED TO EXISTING PIPES AT EXISTING INVERTS.

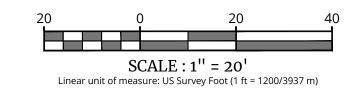

WESTCHESTER COUNTY **NEW YORK** WESTCHESTER 400 Columbus Avenue,

Philip John Grealy

NEW YORK LICENSED PROFESSIONAL ENGINEER

LICENSE NUMBER: 059858-1

COLLIERS ENGINEERING & DESIGN CT, P.C. N.Y. C.O.A #: 0017609

HIGHWAY IMPROVEMENT

PLANS

FOR

UNDERHILL AVENUE

IMPROVEMENTS

(SEQR # 22-092)

NYS ROUTE 118 (S.H. 148) AT

UNDERHILL AVENUE

TOWN OF YORKTOWN

Colliers

Engineering & Design

www.colliersengineering.com

and all the information contained herein is authorized for use only by the party whom the services were contracted or to whom it is certified. This drawing may r be copied, reused, disclosed, distributed or relied upon for any other purp without the express written consent of Colliers Engineering & Design

FOR STATE SPECIFIC DIRECT PHONE NUMBERS VISIT: WWW.CALL811.COM

PROTECT YOURSELF

ALL STATES REQUIRE NOTIFICATION OF EXCAVATORS, DESIGNERS, OR ANY PERSO PREPARING TO DISTURB THE EARTH'S SURFACE ANYWHERE IN ANY STATE

Colliers Engineering & Design

Suite 180E Valhalla, NY 10595 Phone: 914.347.7500 COLLIERS ENGINEERING & DESIGN, ARCHITECTURE, LANDSCAPE ARCHITECTU SURVEYING CT, P.C.


1/8/23 M.J.A. AS SHOWN R-PL08-GRAD


20006297A


GRADING & DRAINAGE PLAN

GD-01

UNAUTHORIZED ALTERATION OR ADDITION TO A SURVEY OR ENGINEERING MAP BEARING A LICENSED LAND SURVEYOR OR PROFESSIONAL ENGINEER IS A VIOLATION OF SECTION 7209, SUB-DIVISION 2, OF THE NEW YORK STATE EDUCATION LAW. ONLY MAPS WITH THE LAND SURVEYOR OR PROFESSIONAL ENGINEER'S SEAL ARE GENUINE TRUE AND CORRECT COPIES OF THE LAND SURVEYOR OR PROFESSIONAL ENGINEER'S ORIGINAL WORK AND OPINION.

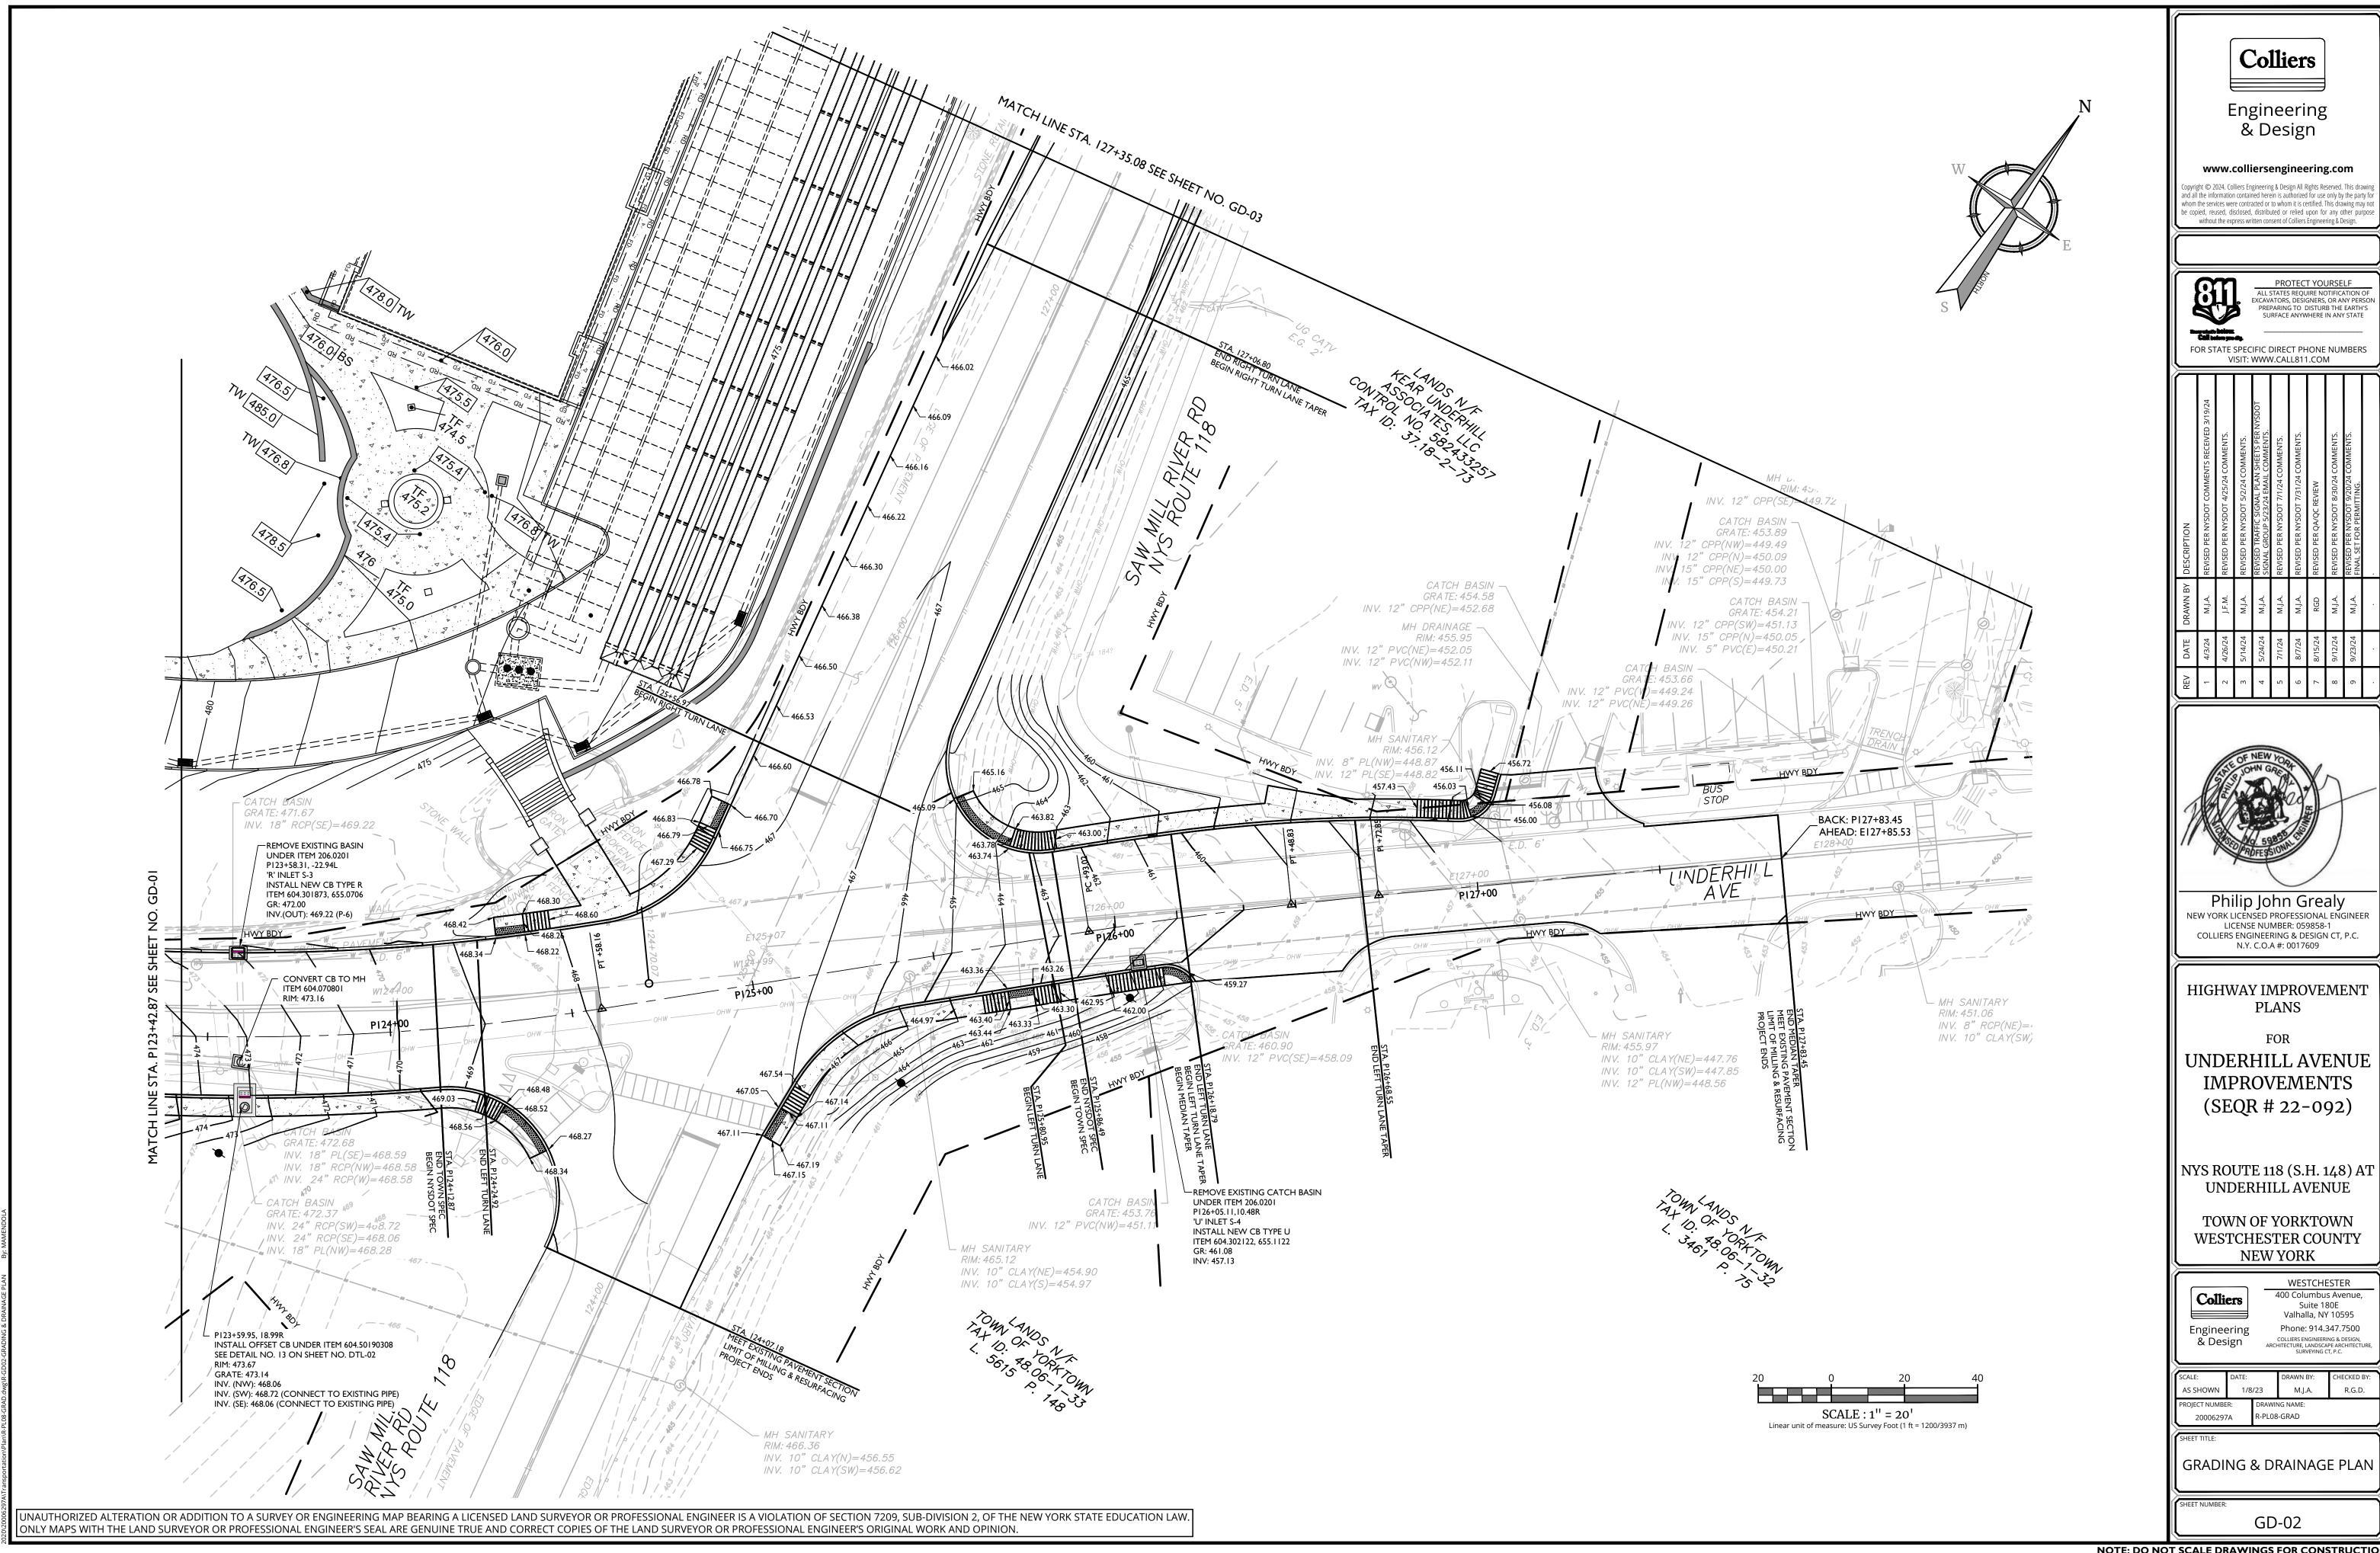

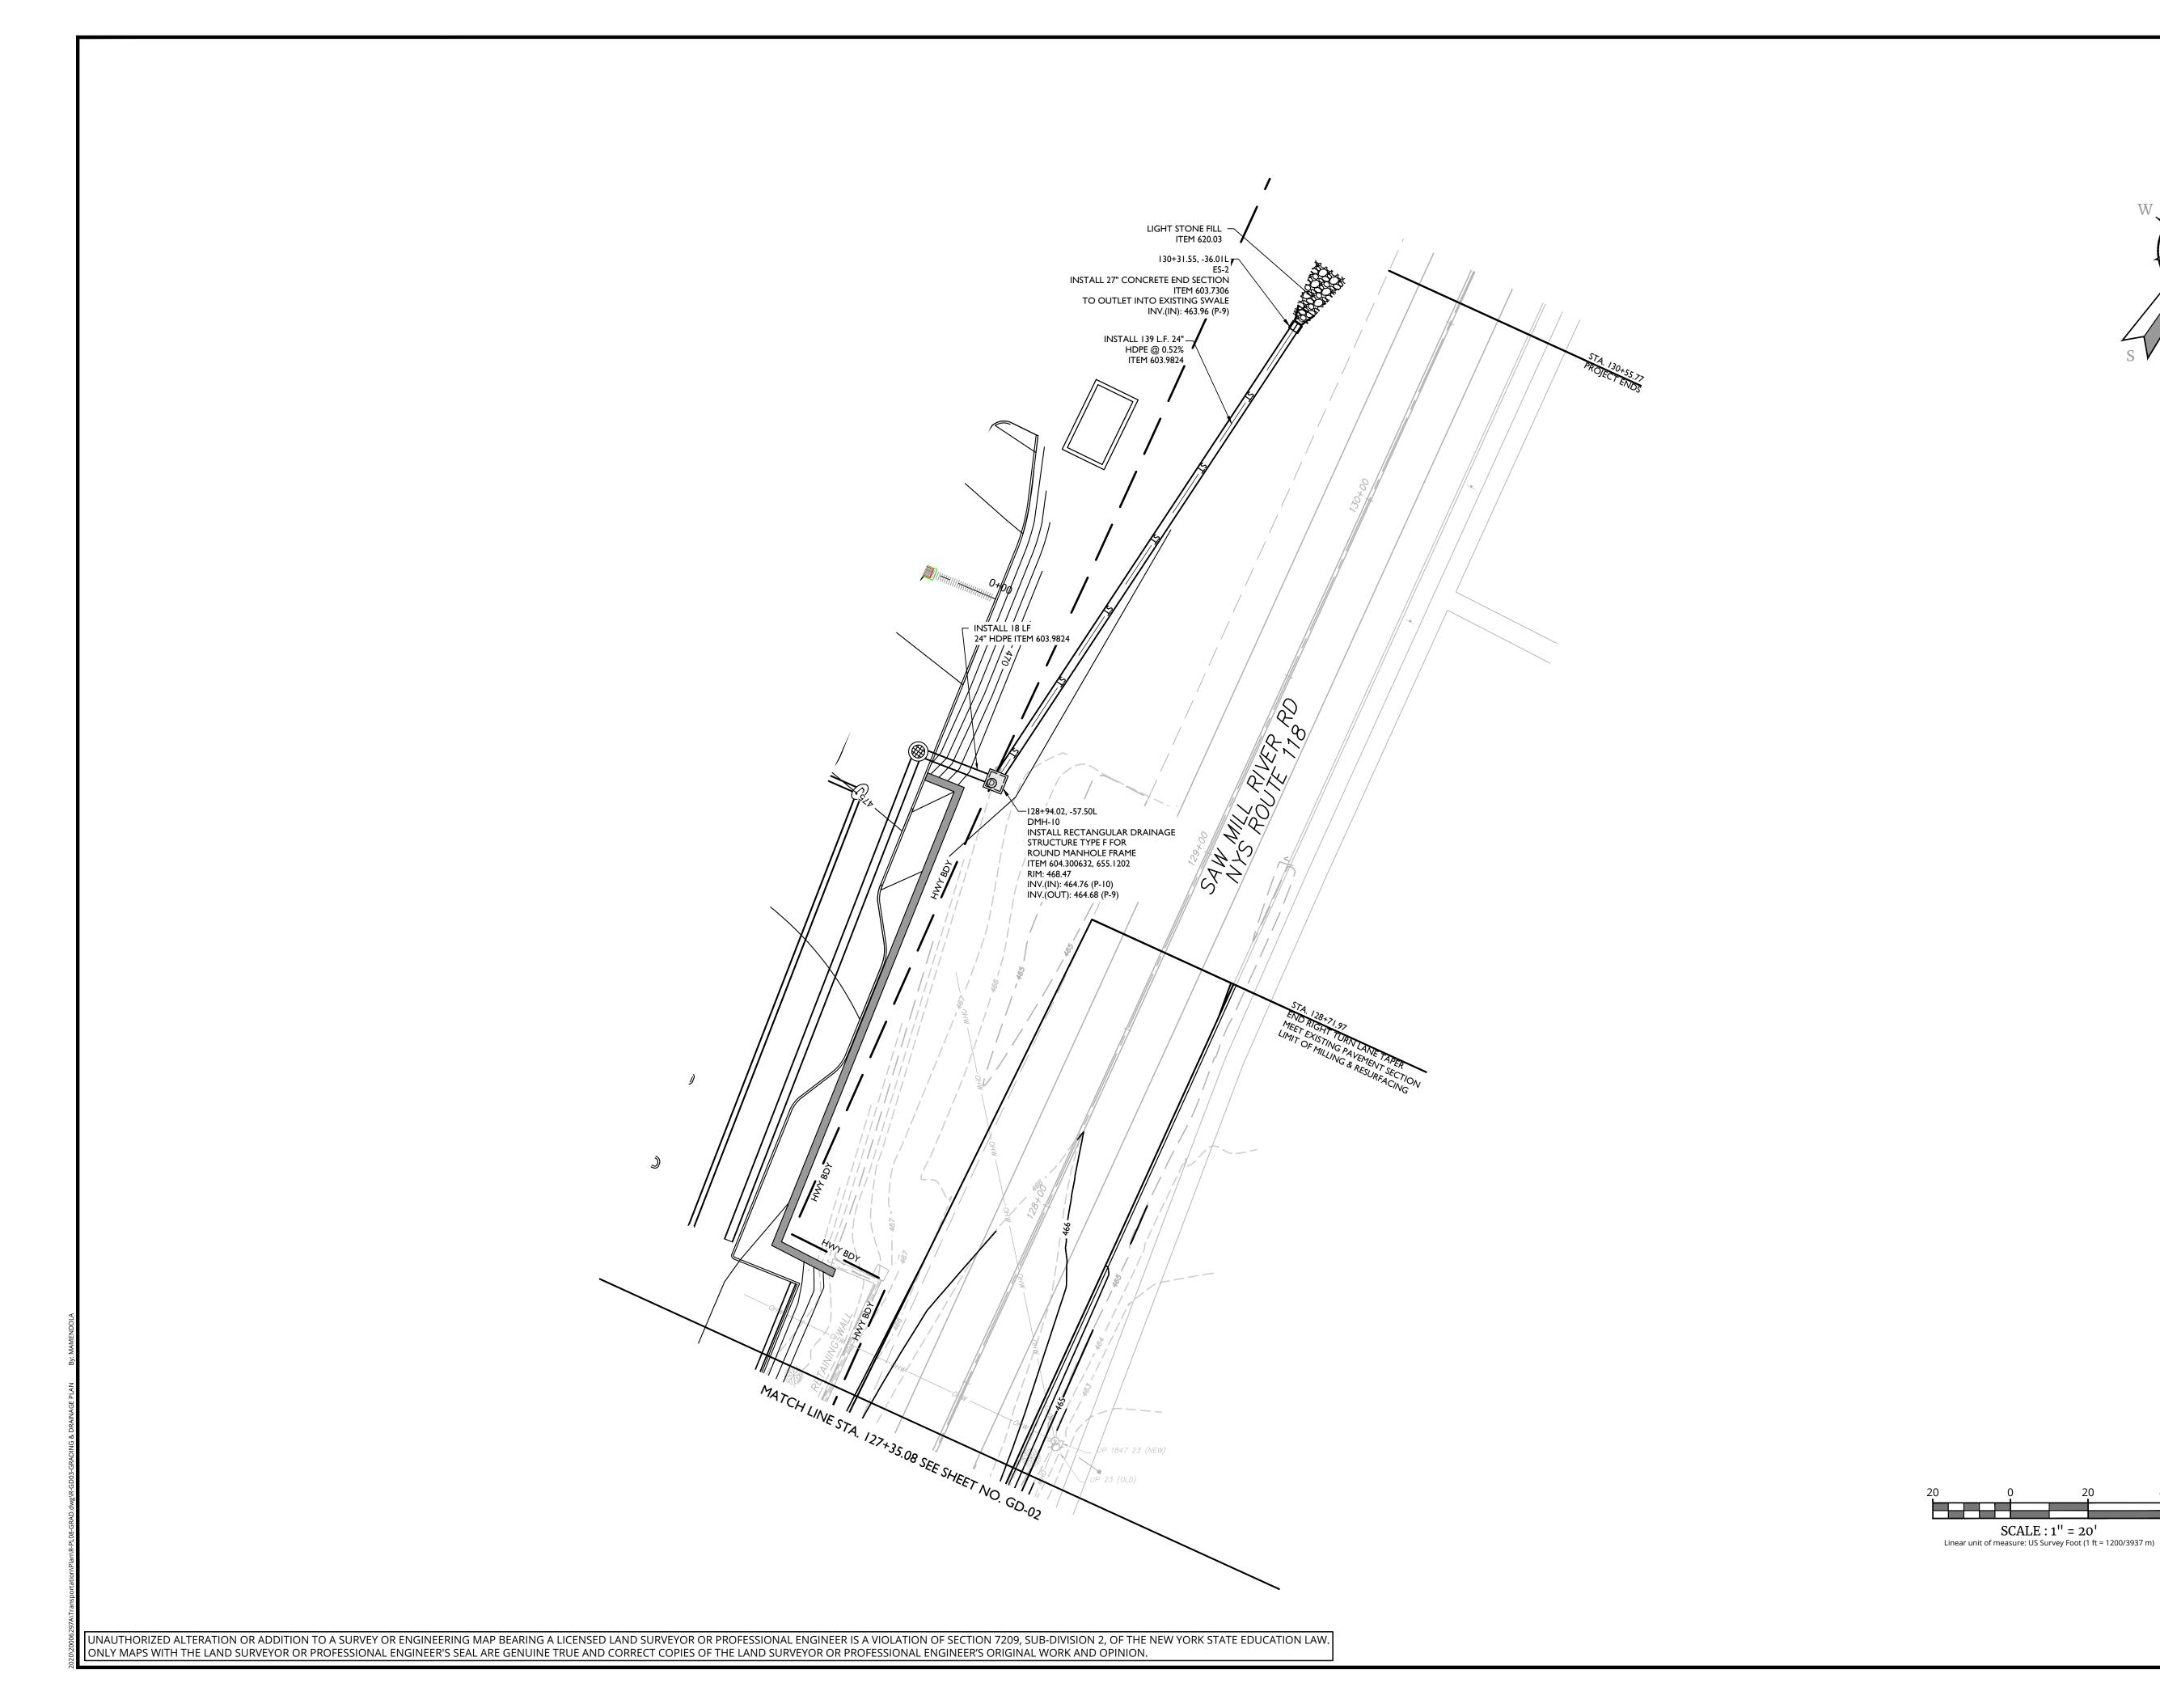

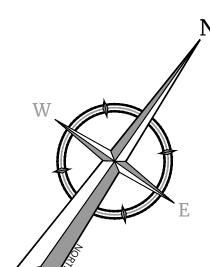

Engineering & Design

www.colliersengineering.com

Copyright © 2024. Colliers Engineering & Design All Rights Reserved. This drawir and all the information contained herein is authorized for use only by the party for whom the services were contracted or to whom it is certified. This drawing may no be copied, reused, disclosed, distributed or relied upon for any other purpo

PROTECT YOURSELF
ALL STATES REQUIRE NOTIFICATION OF EXCAVATORS, DESIGNERS, OR ANY PERSON PREPARING TO DISTURB THE EARTH'S SURFACE ANYWHERE IN ANY STATE

FOR STATE SPECIFIC DIRECT PHONE NUMBERS VISIT: WWW.CALL811.COM

DRAWN BY DESCRIPTION	REVISED PER NYSDOT COMMENTS RECEIVED 3/19/24	REVISED PER NYSDOT 4/25/24 COMMENTS.	REVISED PER NYSDOT 5/2/24 COMMENTS.	REVISED TRAFFIC SIGNAL PLAN SHEETS PER NYSDOT SIGNAL GROUP 5/23/24 EMAIL COMMENTS.	REVISED PER NYSDOT 7/1/24 COMMENTS.	REVISED PER NYSDOT 7/31/24 COMMENTS.	revised per qa/qc review	REVISED PER NYSDOT 8/30/24 COMMENTS.	REVISED PER NYSDOT 9/20/24 COMMENTS. FINAL SET FOR PERMITTING.	
WN BY D	M.J.A. RE	J.F.M. RE	M.J.A. RE	M.J.A. SI	M.J.A. RE	M.J.A. RE	RGD RE	M.J.A. RE	M.J.A. FII	
DRA	W	J.f	M	M	M	W	R	M	Μ	
DATE	4/3/24	4/26/24	5/14/24	5/24/24	7/1/24	8/7/24	8/15/24	9/12/24	9/23/24	
REV	1	2	3	4	2	9	7	8	6	·



Philip John Grealy
NEW YORK LICENSED PROFESSIONAL ENGINEER
LICENSE NUMBER: 059858-1
COLLIERS ENGINEERING & DESIGN CT, P.C.
N.Y. C.O.A #: 0017609

HIGHWAY IMPROVEMENT **PLANS**

FOR

UNDERHILL AVENUE **IMPROVEMENTS** (SEQR # 22-092)

NYS ROUTE 118 (S.H. 148) AT UNDERHILL AVENUE

TOWN OF YORKTOWN WESTCHESTER COUNTY **NEW YORK**

Colliers

Engineering & Design


WESTCHESTER 400 Columbus Avenue, Suite 180E Valhalla, NY 10595

Phone: 914.347.7500

AS SHOWN 1/8/23 R-PL08-GRAD 20006297A

GRADING & DRAINAGE PLAN

GD-03

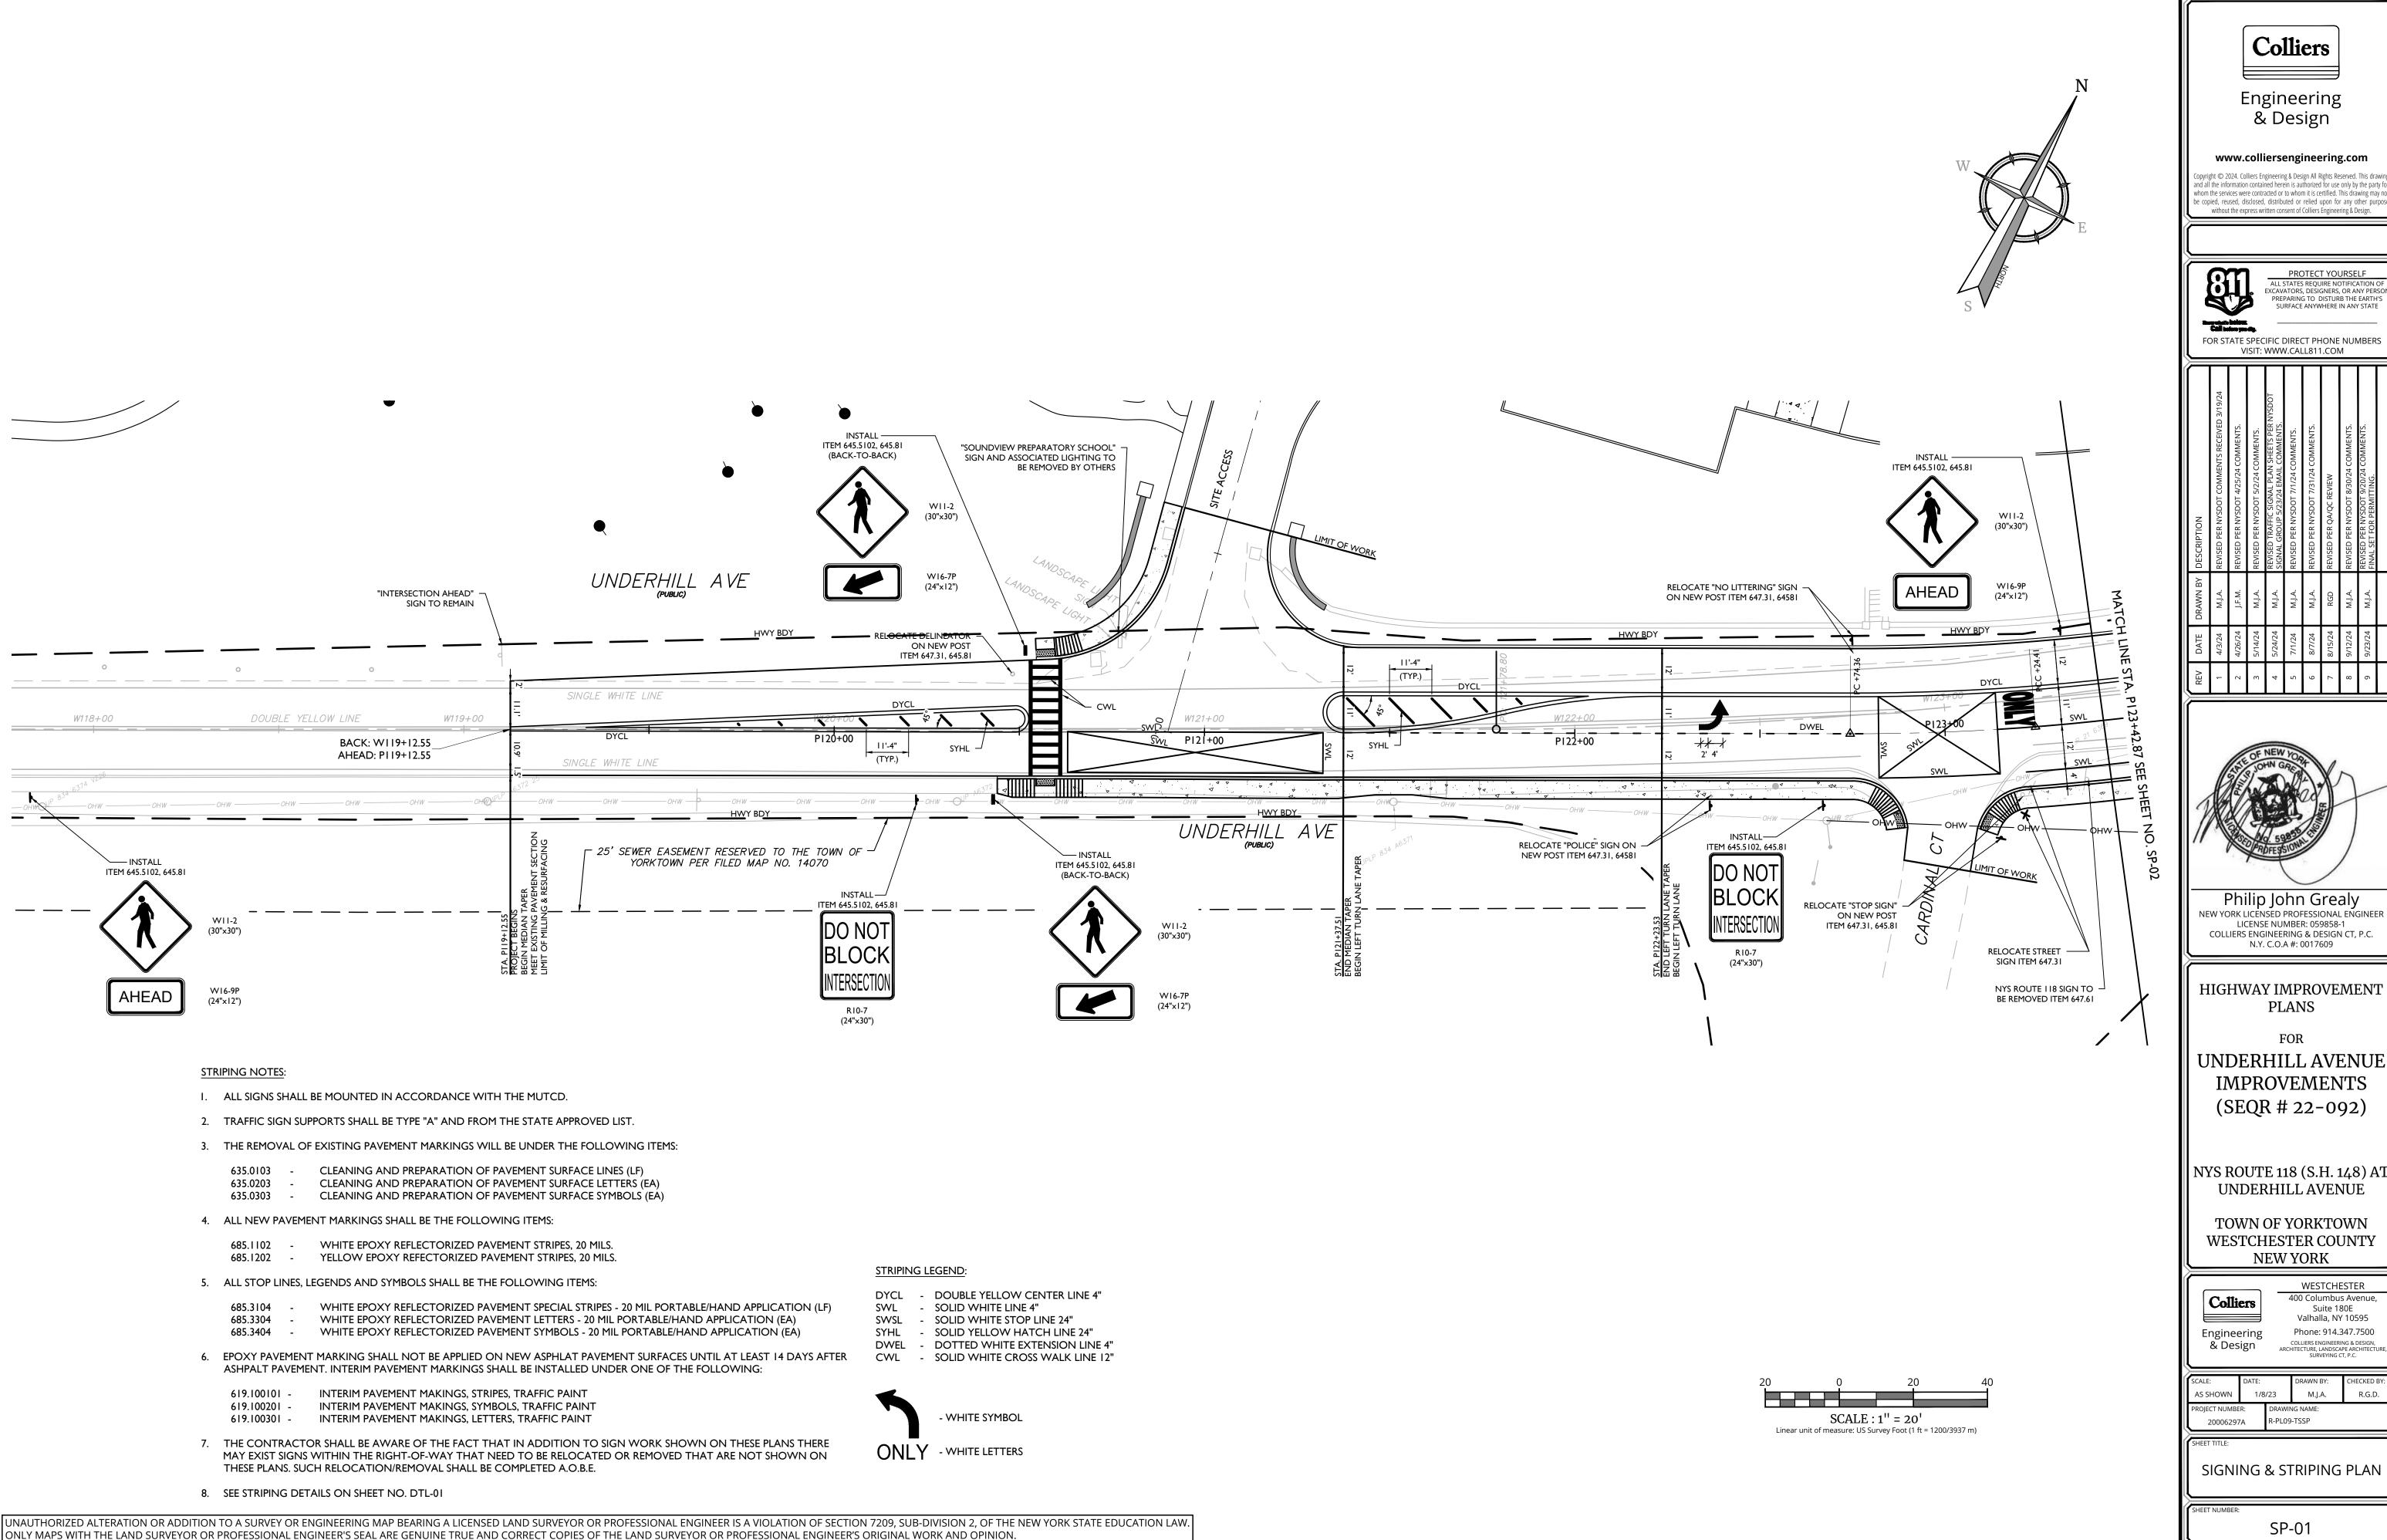

Engineering & Design

www.colliersengineering.com

opyright © 2024. Colliers Engineering & Design All Rights Reserved. This drawi be copied, reused, disclosed, distributed or relied upon for any other purp

ALL STATES REQUIRE NOTIFICATION OF EXCAVATORS, DESIGNERS, OR ANY PERSO PREPARING TO DISTURB THE EARTH'S SURFACE ANYWHERE IN ANY STATE

FOR STATE SPECIFIC DIRECT PHONE NUMBERS VISIT: WWW.CALL811.COM

DRAWN BY DESCRIPTION	REVISED PER NYSDOT COMMENTS RECEIVED 3/19/24	REVISED PER NYSDOT 4/25/24 COMMENTS.	REVISED PER NYSDOT 5/2/24 COMMENTS.	REVISED TRAFFIC SIGNAL PLAN SHEETS PER NYSDOT SIGNAL GROUP 5/23/24 EMAIL COMMENTS.	REVISED PER NYSDOT 7/1/24 COMMENTS.	REVISED PER NYSDOT 7/31/24 COMMENTS.	REVISED PER QA/QC REVIEW	REVISED PER NYSDOT 8/30/24 COMMENTS.	REVISED PER NYSDOT 9/20/24 COMMENTS. FINAL SET FOR PERMITTING.	
DRAWN BY	M.J.A.	J.F.M.	M.J.A.	M.J.A.	M.J.A.	M.J.A.	RGD	M.J.A.	M.J.A.	
DATE	4/3/24	4/26/24	5/14/24	5/24/24	7/1/24	8/7/24	8/15/24	9/12/24	9/23/24	
REV	1	2	3	4	5	9	7	8	6	



Philip John Grealy NEW YORK LICENSED PROFESSIONAL ENGINEER LICENSE NUMBER: 059858-1 COLLIERS ENGINEERING & DESIGN CT, P.C. N.Y. C.O.A #: 0017609

HIGHWAY IMPROVEMENT PLANS

UNDERHILL AVENUE **IMPROVEMENTS** (SEQR # 22-092)

NYS ROUTE 118 (S.H. 148) AT UNDERHILL AVENUE

TOWN OF YORKTOWN WESTCHESTER COUNTY NEW YORK




WESTCHESTER 400 Columbus Avenue, Suite 180E Valhalla, NY 10595 Phone: 914.347.7500


ARCHITECTURE, LANDSCAPE ARCHITECTU SURVEYING CT, P.C.


1/8/23 AS SHOWN R-PL09-TSSP 20006297A

SIGNING & STRIPING PLAN

SP-01

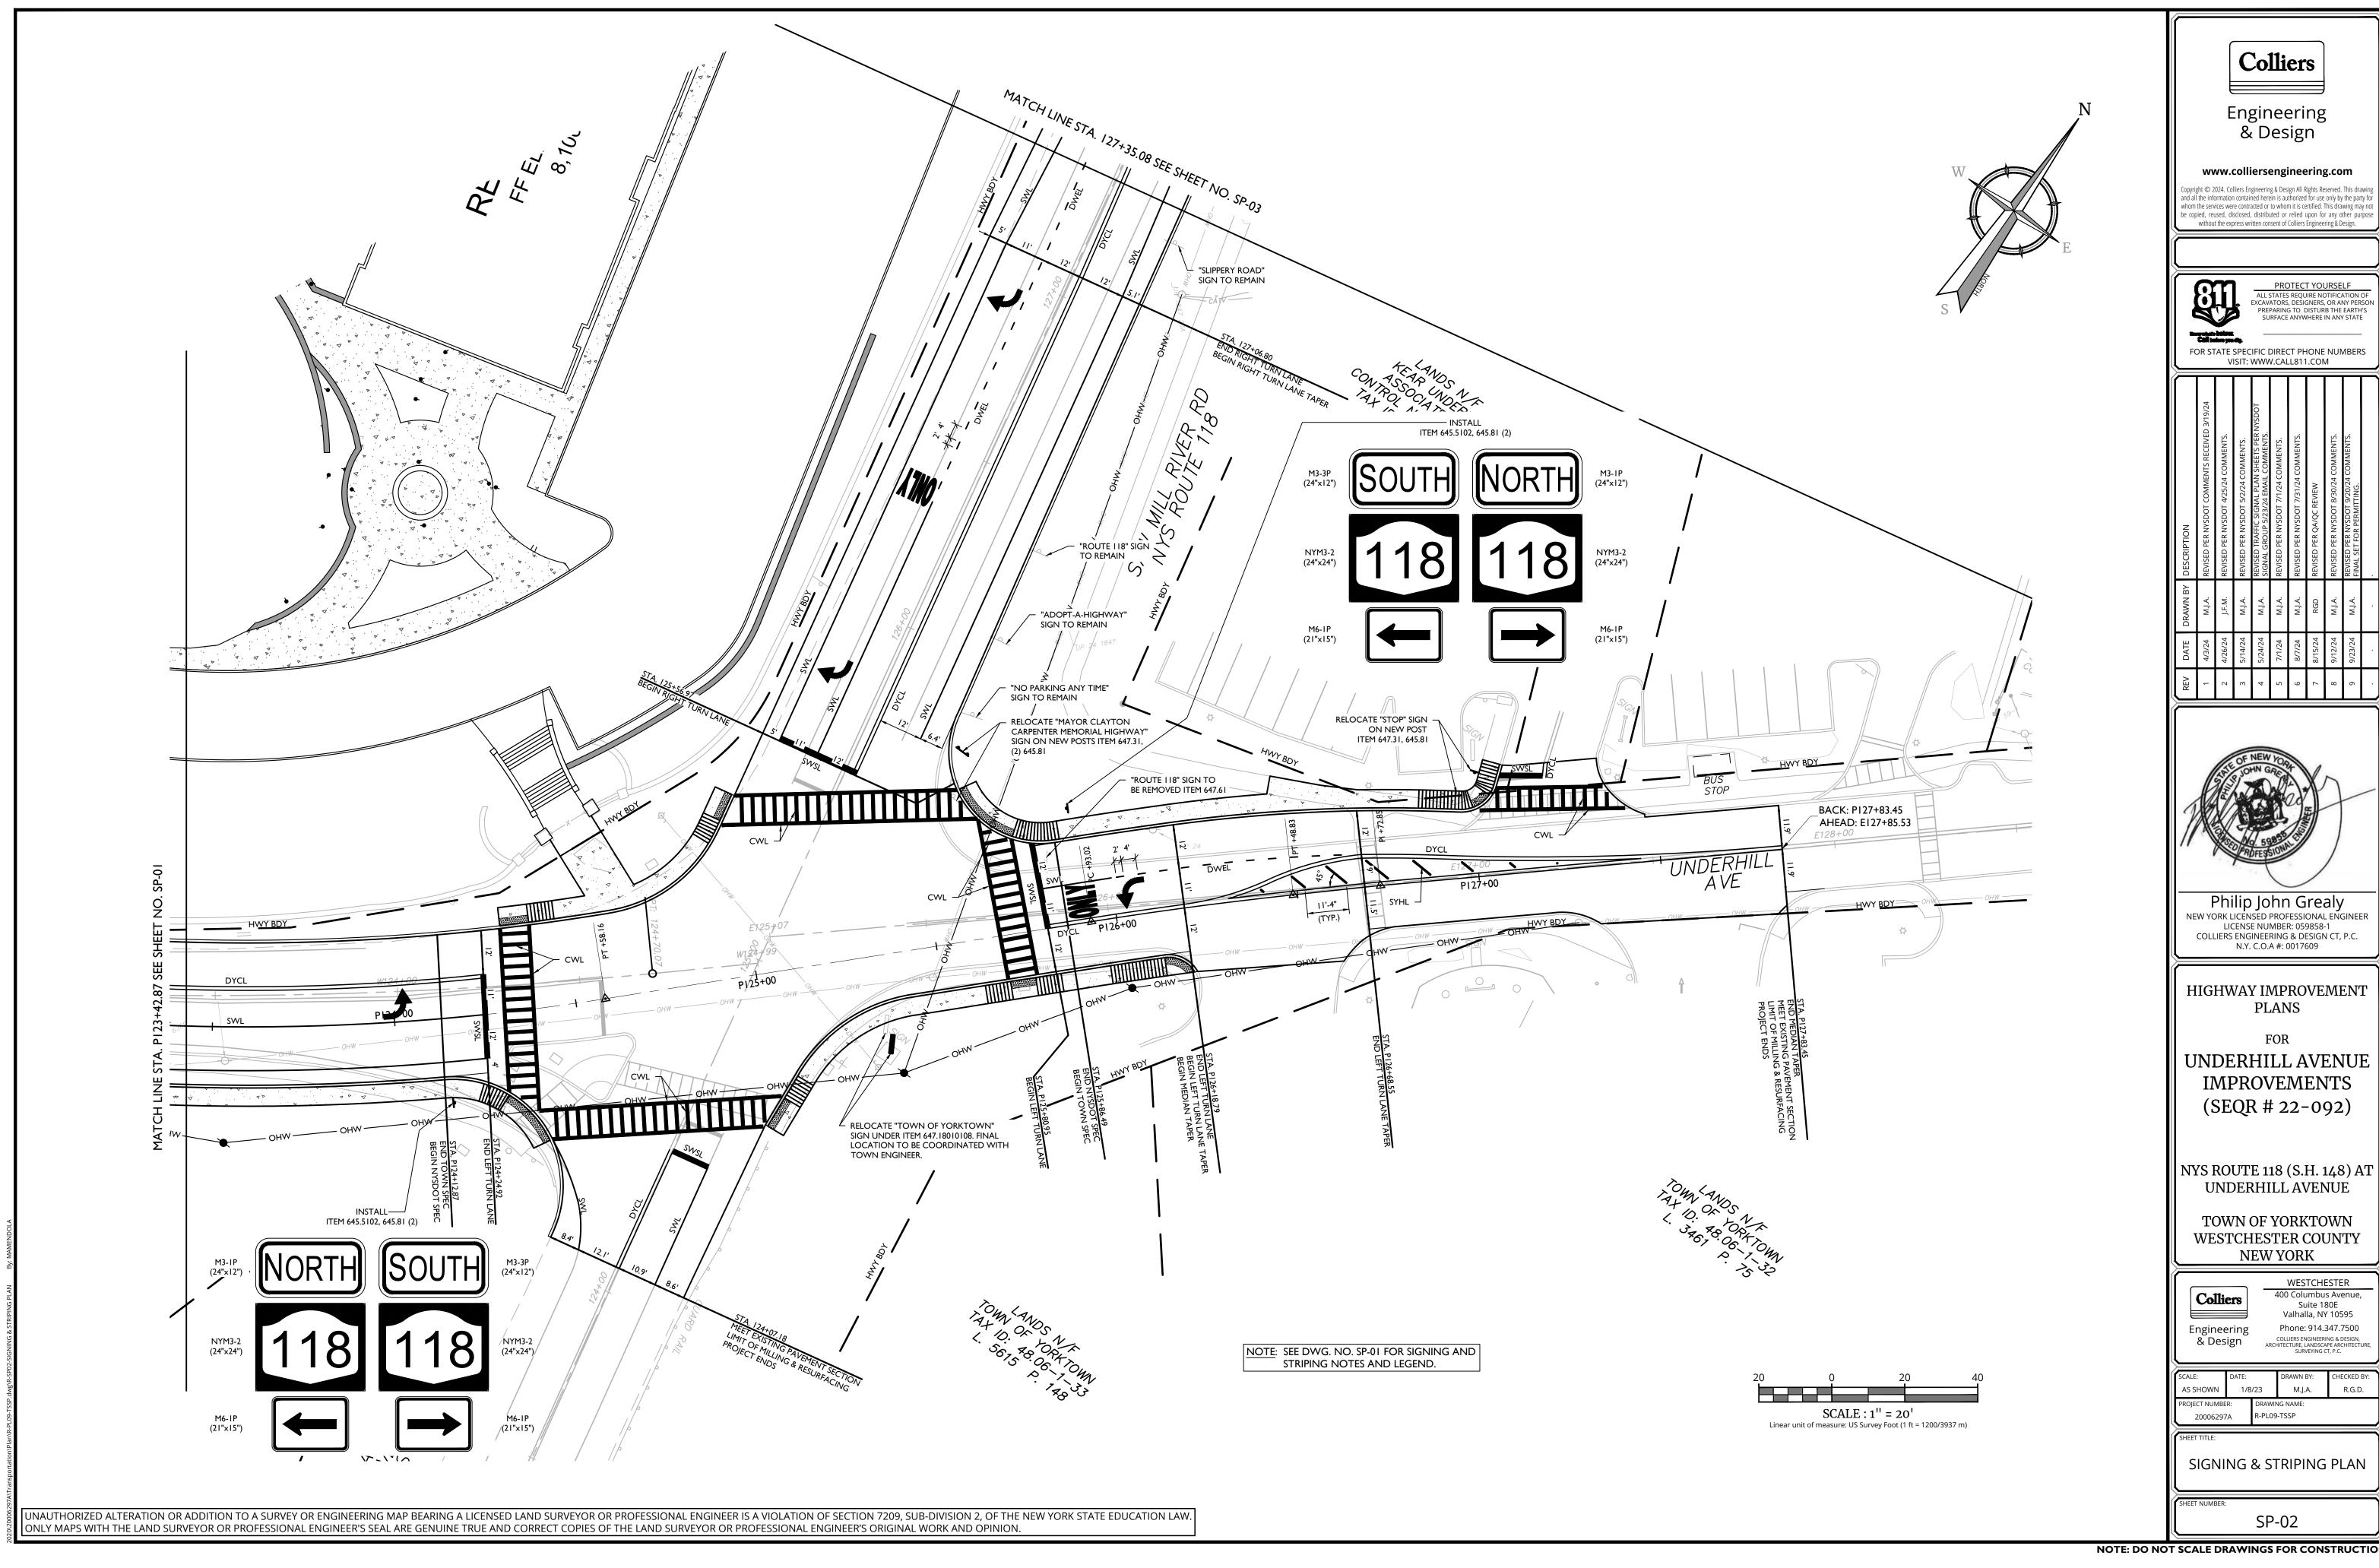

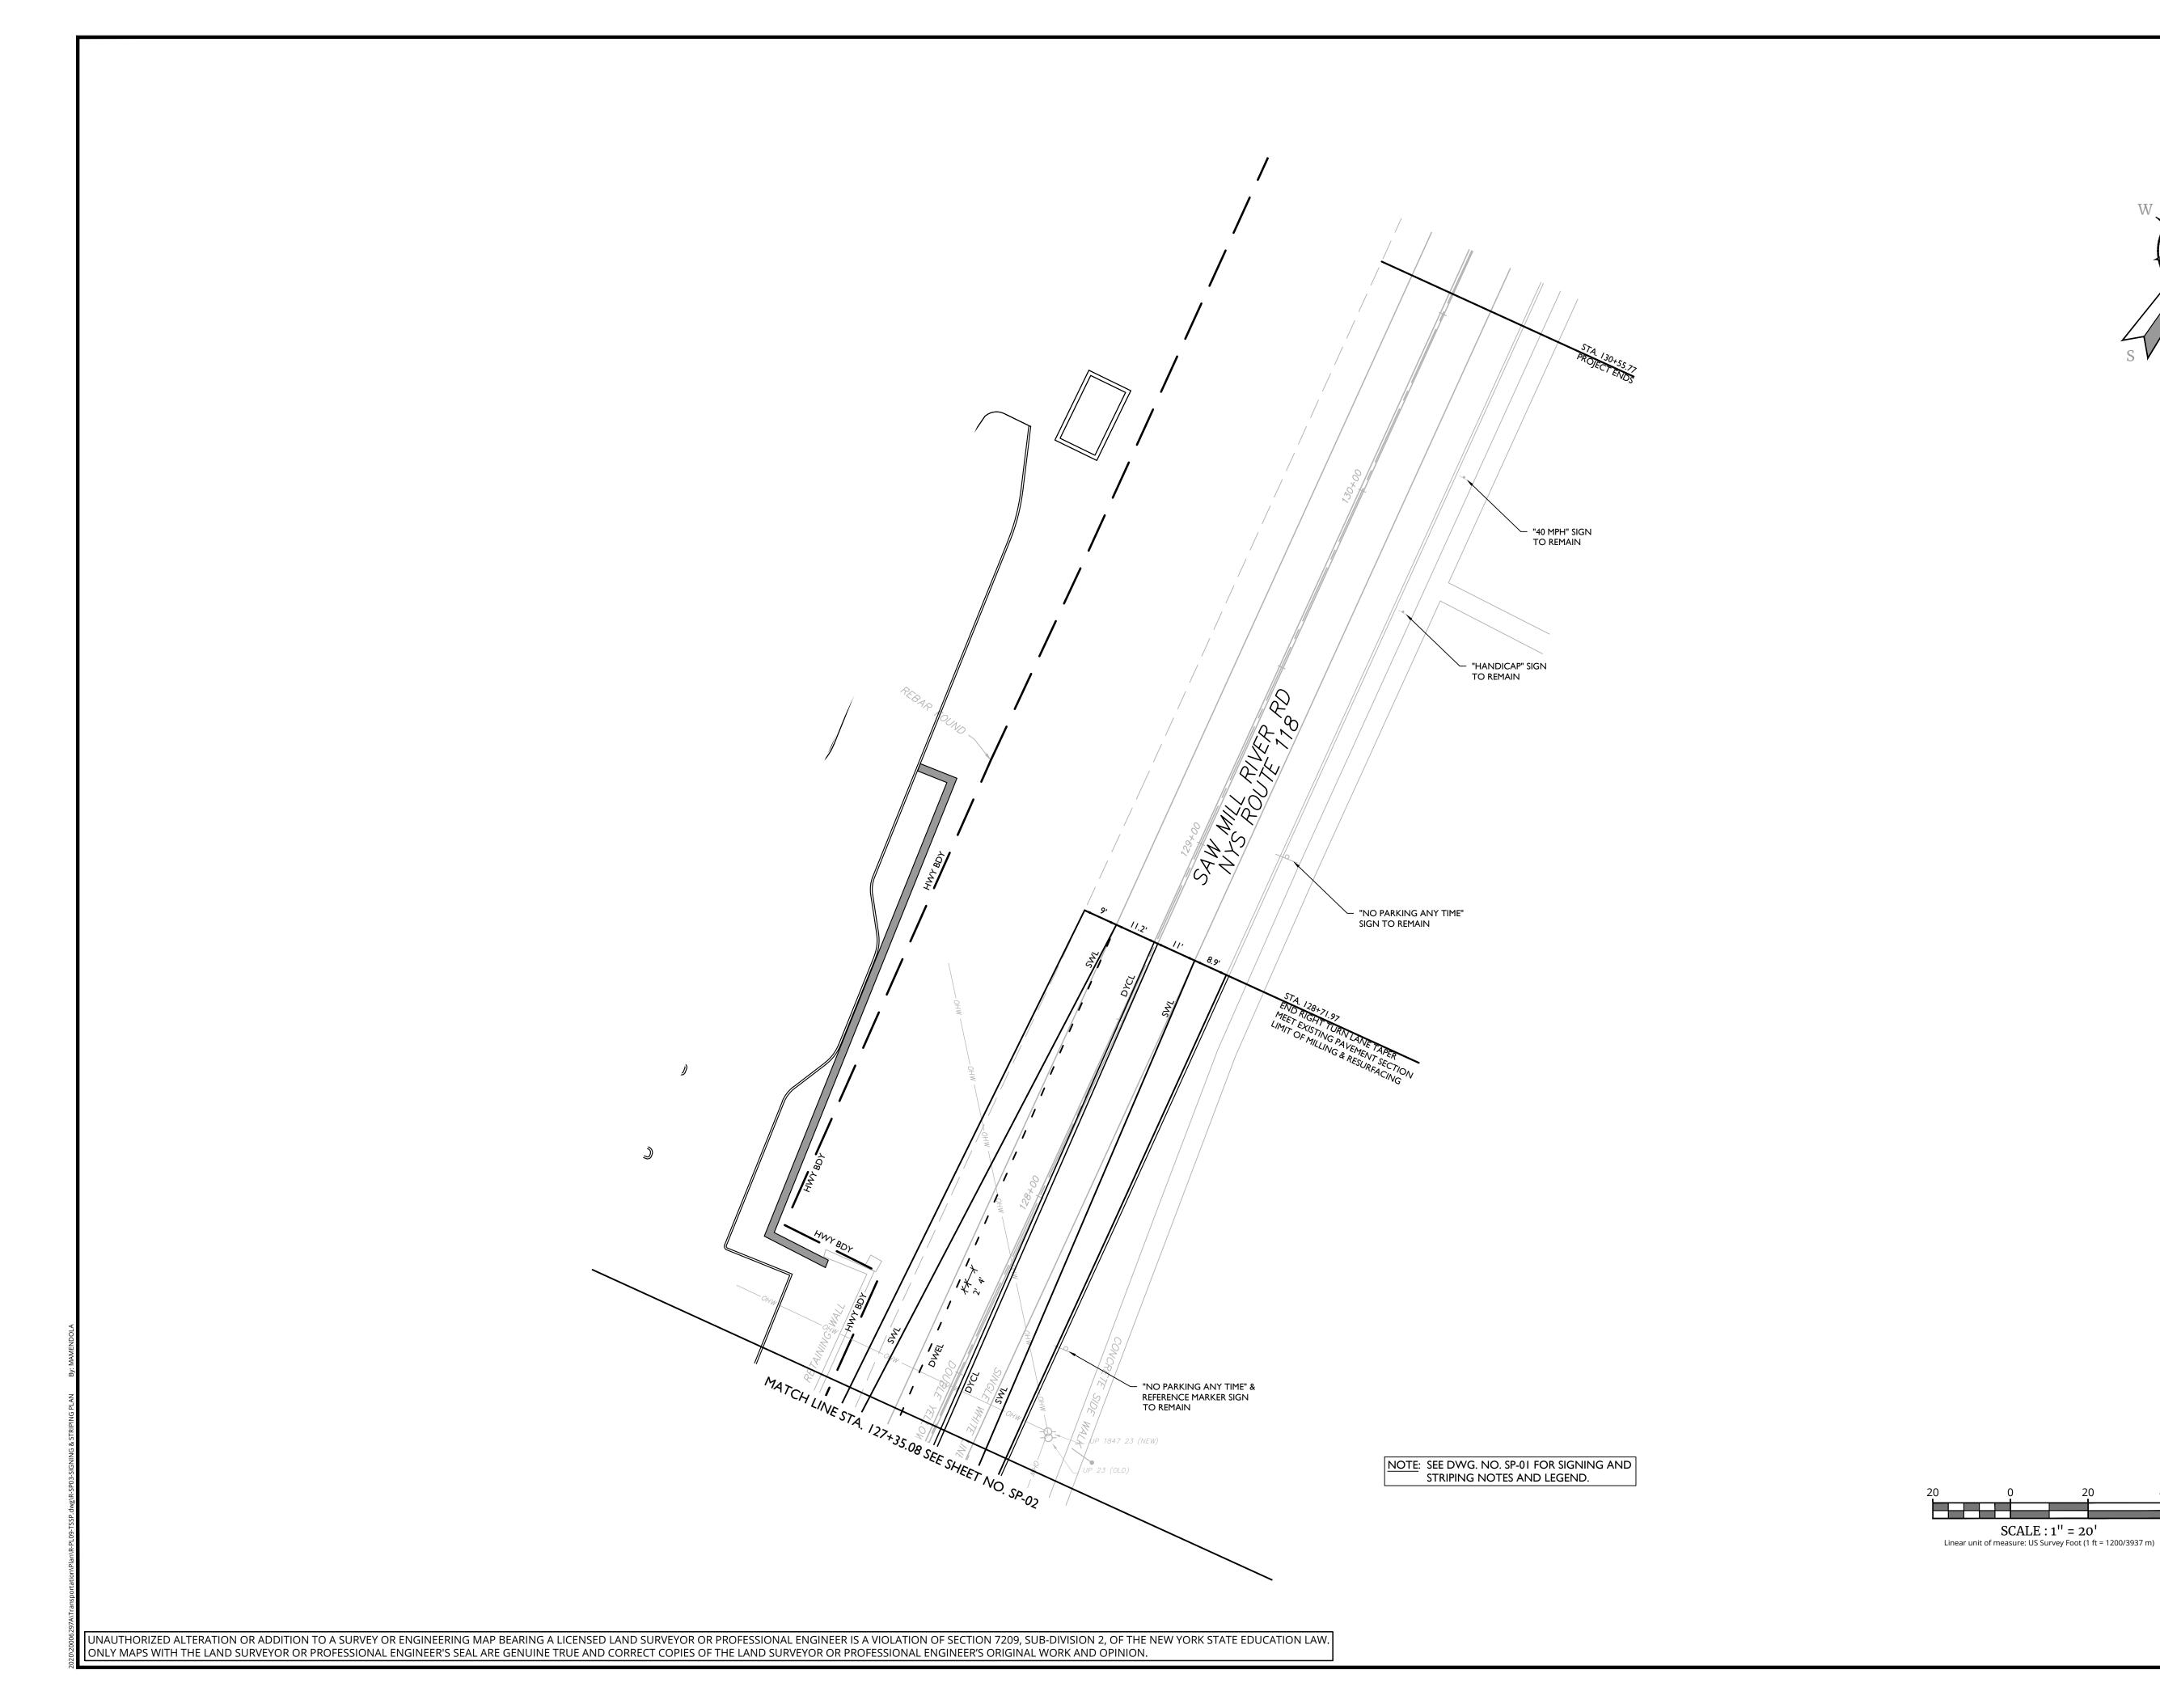

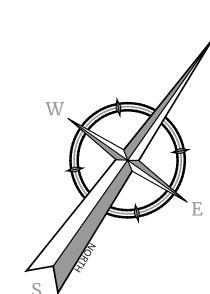

Engineering & Design

www.colliersengineering.com

Copyright © 2024. Colliers Engineering & Design All Rights Reserved. This drawir and all the information contained herein is authorized for use only by the party for whom the services were contracted or to whom it is certified. This drawing may not be copied, reused, disclosed, distributed or relied upon for any other purpose within concept of Collings Engineering. Presign

PR ALL STATI EXCAVATOR PREPARIN SURFACE


PROTECT YOURSELF

ALL STATES REQUIRE NOTIFICATION OF EXCAVATORS, DESIGNERS, OR ANY PERSON PREPARING TO DISTURB THE EARTH'S SURFACE ANYWHERE IN ANY STATE

SON ACE ANTWICK IN ANY STA

FOR STATE SPECIFIC DIRECT PHONE NUMBERS VISIT: WWW.CALL811.COM

REV	DATE	DRAWN BY	DESCRIPTION
1	4/3/24	M.J.A.	REVISED PER NYSDOT COMMENTS RECEIVED 3/19/24
2	4/26/24	J.F.M.	REVISED PER NYSDOT 4/25/24 COMMENTS.
3	5/14/24	M.J.A.	REVISED PER NYSDOT 5/2/24 COMMENTS.
4	5/24/24	M.J.A.	REVISED TRAFFIC SIGNAL PLAN SHEETS PER NYSDOT SIGNAL GROUP 5/23/24 EMAIL COMMENTS.
2	7/1/24	M.J.A.	REVISED PER NYSDOT 7/1/24 COMMENTS.
9	8/7/24	M.J.A.	REVISED PER NYSDOT 7/31/24 COMMENTS.
7	8/15/24	RGD	revised per QA/QC review
8	9/12/24	M.J.A.	REVISED PER NYSDOT 8/30/24 COMMENTS.
6	9/23/24	M.J.A.	REVISED PER NYSDOT 9/20/24 COMMENTS. FINAL SET FOR PERMITTING.
		·	

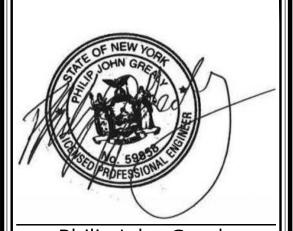

Philip John Grealy
NEW YORK LICENSED PROFESSIONAL ENGINEER
LICENSE NUMBER: 059858-1
COLLIERS ENGINEERING & DESIGN CT, P.C.
N.Y. C.O.A #: 0017609

HIGHWAY IMPROVEMENT PLANS

FOR

UNDERHILL AVENUE IMPROVEMENTS (SEQR # 22-092)

NYS ROUTE 118 (S.H. 148) AT UNDERHILL AVENUE

TOWN OF YORKTOWN WESTCHESTER COUNTY NEW YORK

Colliers

Engineering & Design WESTCHESTER

400 Columbus Avenue,
Suite 180E
Valhalla, NY 10595
Phone: 914 347 7500

Valhalla, NY 10595

Phone: 914.347.7500

COLLIERS ENGINEERING & DESIGN, ARCHITECTURE, LANDSCAPE ARCHITECTURE, SURVEYING CT. P.C.

 SCALE:
 DATE:
 DRAWN BY:
 CHECKED BY:

 AS SHOWN
 1/8/23
 M.J.A.
 R.G.D.

 PROJECT NUMBER:
 DRAWING NAME:


 20006297A
 R-PL09-TSSP

20006297A

SHEET TITLE:

SIGNING & STRIPING PLAN

SP-03

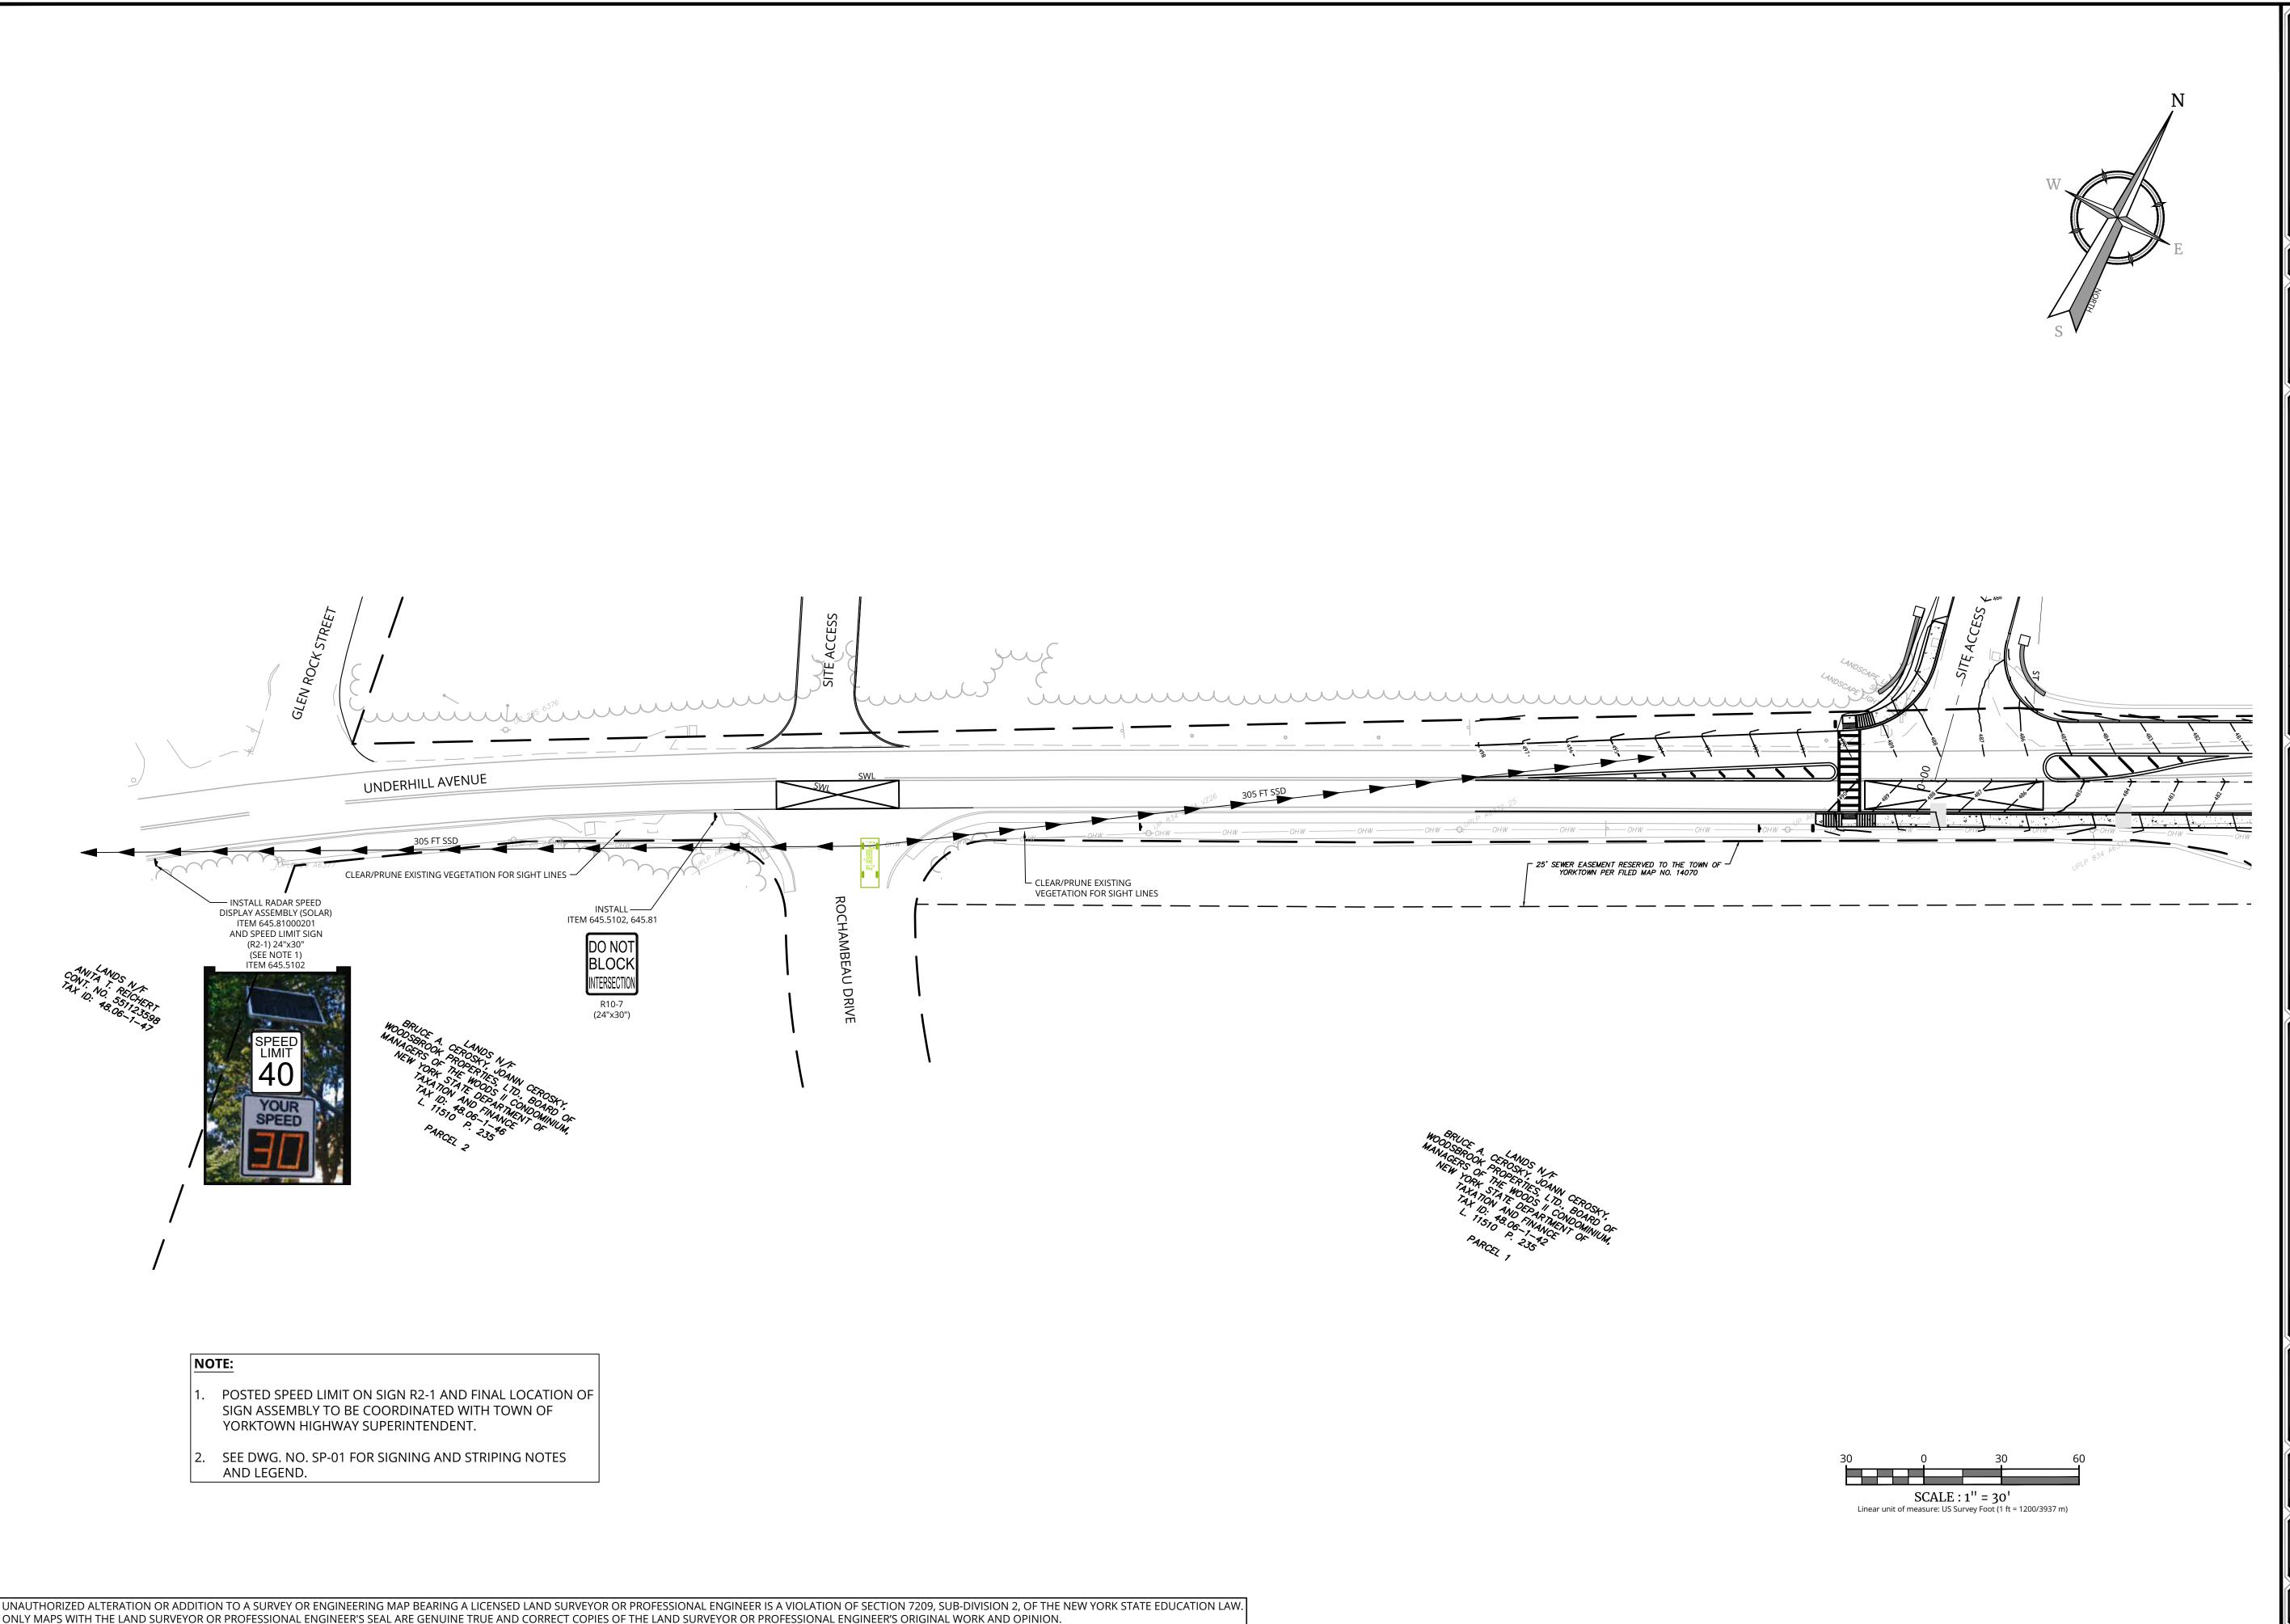

Engineering & Design

www.colliersengineering.com

Copyright © 2024. Colliers Engineering & Design All Rights Reserved. This drawin and all the information contained herein is authorized for use only by the party whom the services were contracted or to whom it is certified. This drawing may r be copied, reused, disclosed, distributed or relied upon for any other purp without the express written consent of Colliers Engineering & Design



PROTECT YOURSELF
ALL STATES REQUIRE NOTIFICATION OF EXCAVATORS, DESIGNERS, OR ANY PERSON PREPARING TO DISTURB THE EARTH'S SURFACE ANYWHERE IN ANY STATE

FOR STATE SPECIFIC DIRECT PHONE NUMBERS VISIT: WWW.CALL811.COM

REV	DATE	DRAWN BY	DESCRIPTION
1	4/3/24	M.J.A.	REVISED PER NYSDOT COMMENTS RECEIVED 3/19/24
2	4/26/24	J.F.M.	REVISED PER NYSDOT 4/25/24 COMMENTS.
3	5/14/24	M.J.A.	REVISED PER NYSDOT 5/2/24 COMMENTS.
4	5/24/24	M.J.A.	REVISED TRAFFIC SIGNAL PLAN SHEETS PER NYSDOT SIGNAL GROUP 5/23/24 EMAIL COMMENTS.
5	7/1/24	M.J.A.	REVISED PER NYSDOT 7/1/24 COMMENTS.
9	8/7/24	M.J.A.	REVISED PER NYSDOT 7/31/24 COMMENTS.
7	8/15/24	RGD	revised per QA/QC review
8	9/12/24	M.J.A.	REVISED PER NYSDOT 8/30/24 COMMENTS.
6	9/23/24	M.J.A.	REVISED PER NYSDOT 9/20/24 COMMENTS. FINAL SET FOR PERMITTING.
		•	



Philip John Grealy
NEW YORK LICENSED PROFESSIONAL ENGINEER
LICENSE NUMBER: 059858-1 COLLIERS ENGINEERING & DESIGN CT, P.C. N.Y. C.O.A #: 0017609

HIGHWAY IMPROVEMENT **PLANS**

FOR

UNDERHILL AVENUE **IMPROVEMENTS** (SEQR # 22-092)

NYS ROUTE 118 (S.H. 148) AT UNDERHILL AVENUE

TOWN OF YORKTOWN WESTCHESTER COUNTY **NEW YORK**

Colliers

& Design


WESTCHESTER 400 Columbus Avenue, Suite 180E Valhalla, NY 10595

Phone: 914.347.7500 Engineering

AS SHOWN 1/8/23 R-PL10-ROCH 20006297A

ROCHAMBEAU DRIVE INTERSECTION **IMPROVEMENTS**

RD-01

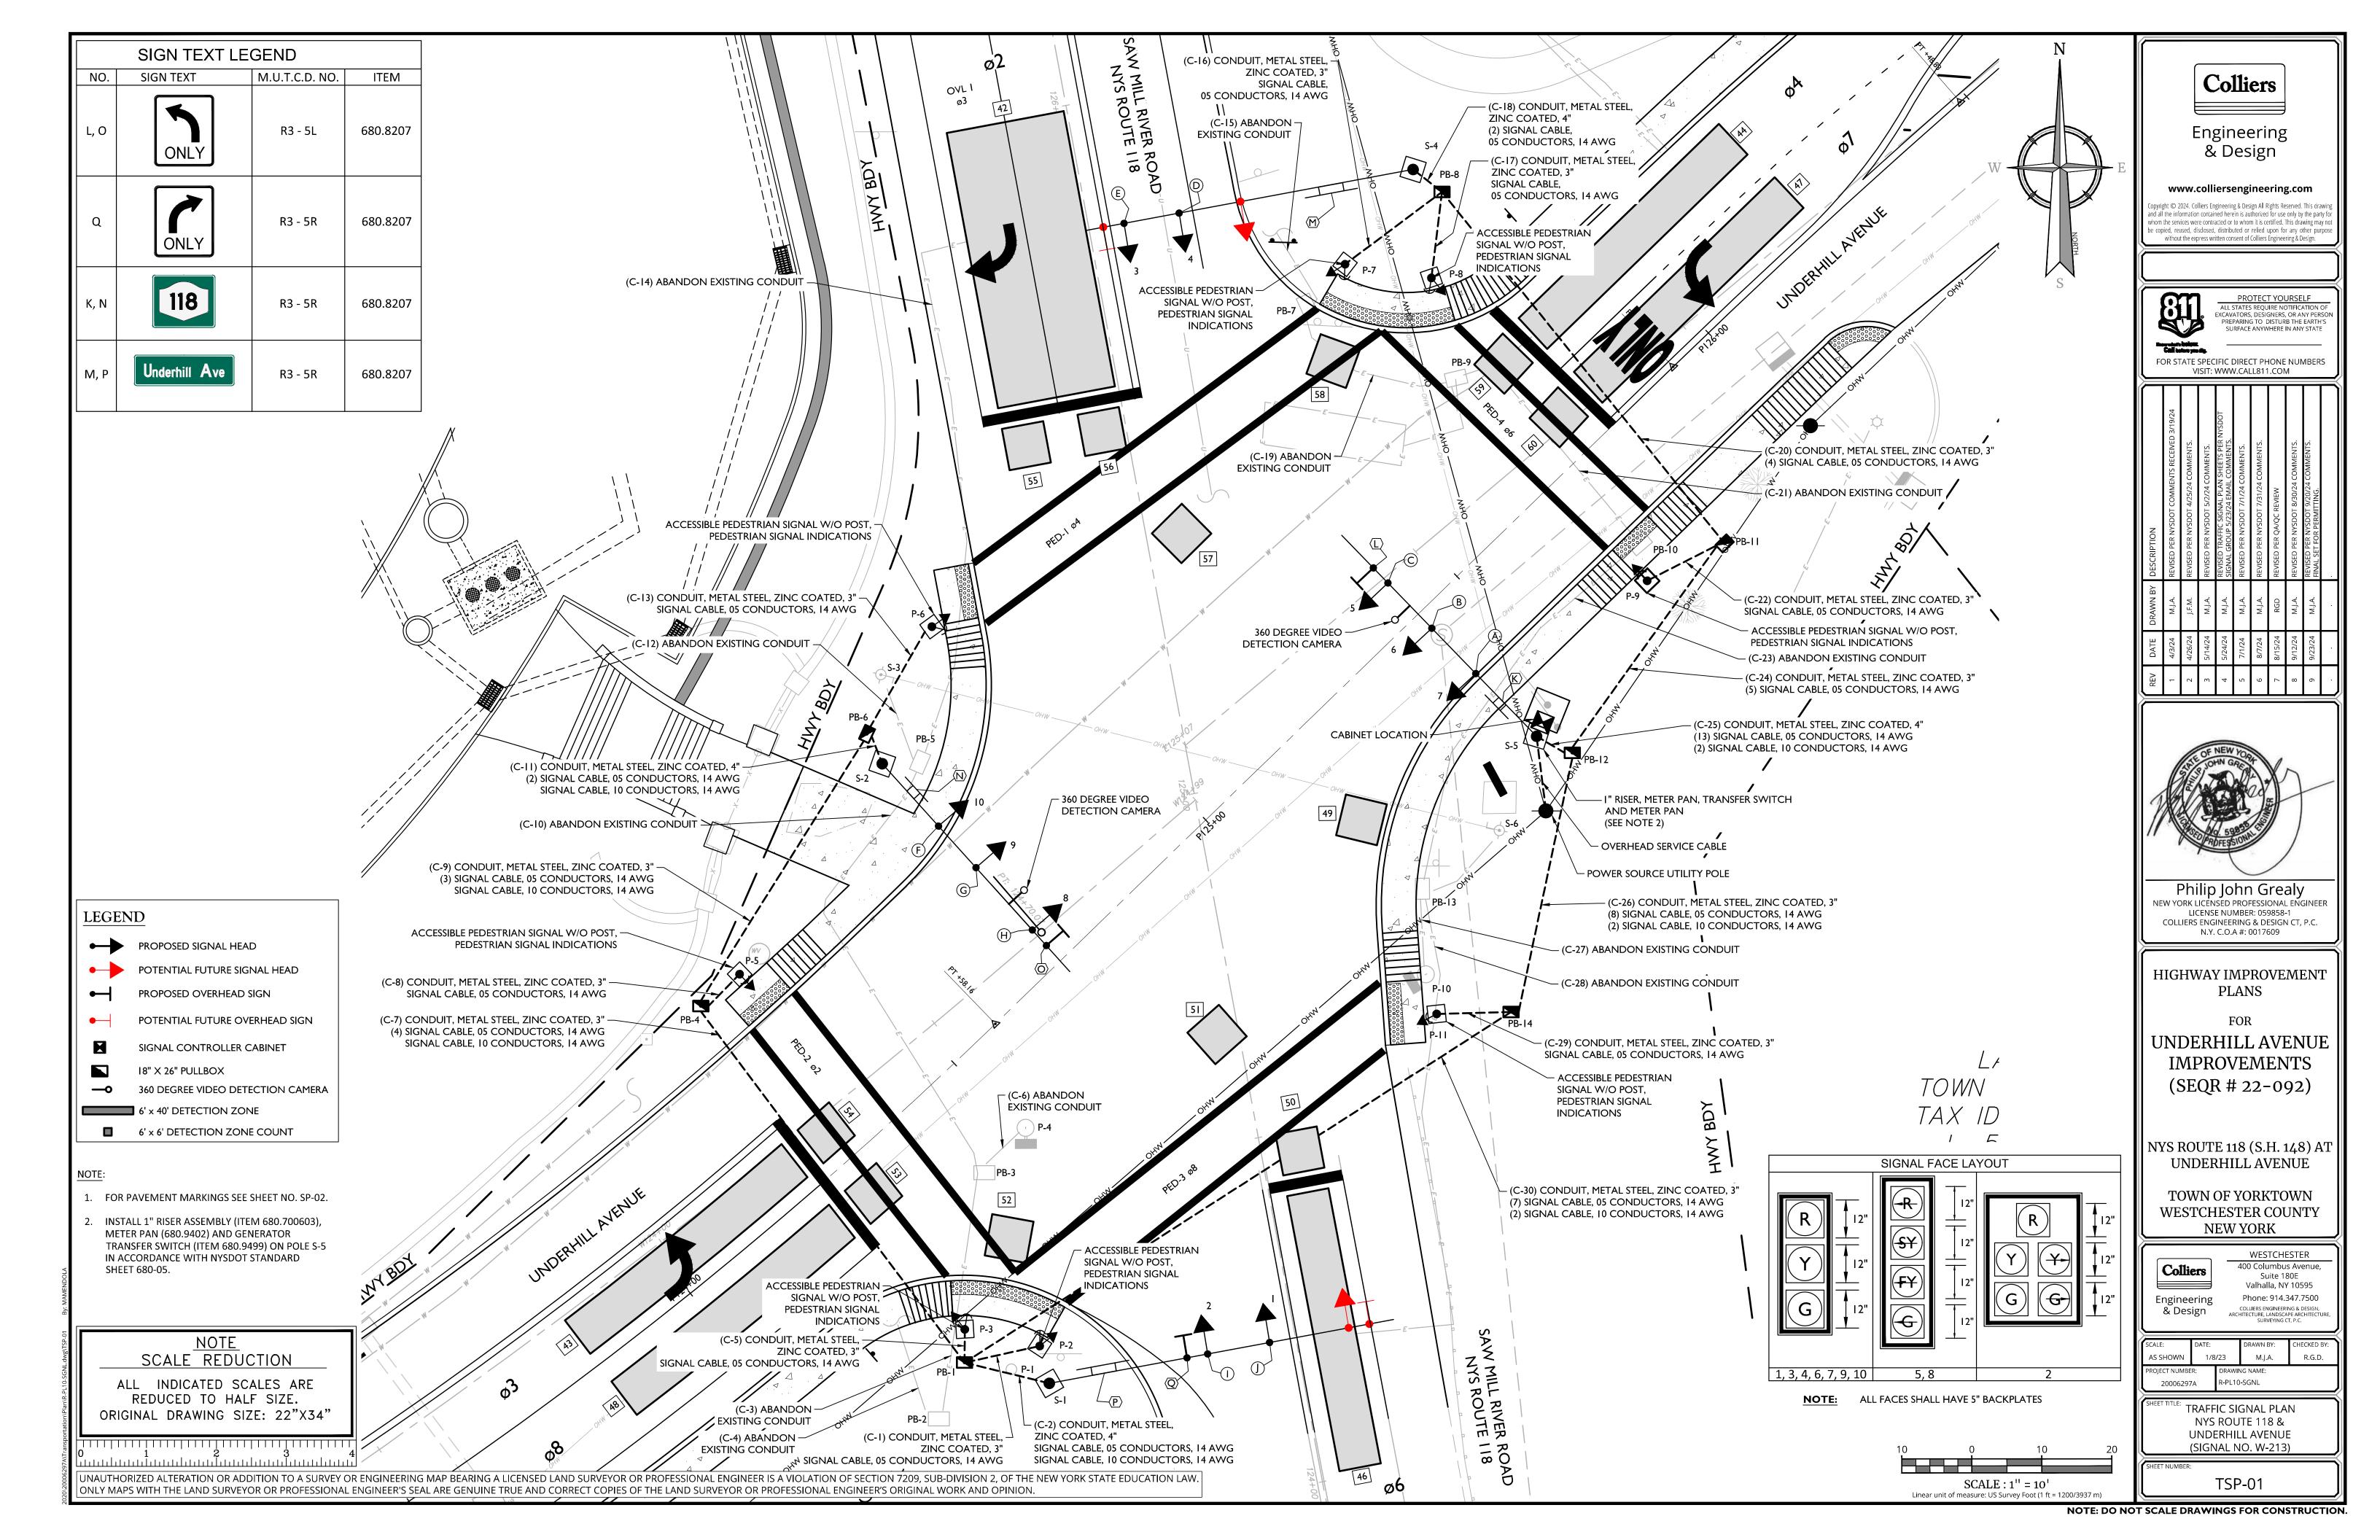

TRAFFIC SIGNAL NOTES:

- ALL WORK IS TO BE COMPLETED ACCORDING TO THE LATEST "NYSDOT STANDARD SPECIFICATIONS," REGION 8 SIGNAL DETAILS SHEETS AND STANDARD STRUCTURE SHEETS. THE REGION 8 SIGNAL DETAILS SHEETS ARE TO BE A PART OF THE SIGNAL PLAN.
- SIGNAL HEAD ROADWAY CLEARANCE SHOULD BE 16'-6".
- ALL MATERIALS INCORPORATED IN THE SIGNAL INSTALLATION SHALL CONFORM TO THE CURRENT NYSDOT REQUIREMENTS AS PER NOTE I ABOVE CONFORMANCE SHALL BE MET BY THE STATE APPROVAL OF THE FOLLOWING SUBMISSIONS BY THE CONTRACTOR.
- A. TRAFFIC SIGNAL POLES AND PEDESTRIAN POLES:
- MANUFACTURER'S SHOP DRAWINGS AND CALCULATIONS MUST BE SUBMITTED TO NYSDOT FOR EACH SIGNAL POLE. THE SHOP DRAWINGS AND CALCULATIONS MUST BE STAMPED BY A PROFESSIONAL ENGINEER LICENSED IN THE STATE OF NEW YORK
- B. TRAFFIC SIGNAL HEADS (SECTIONS) & BRACKET ASSEMBLIES, PEDESTRIAN HEADS AND BRACKET ASSEMBLIES, CONCRETE PULLBOXES, CAST ALUMINUM JUNCTION BOXES, AND OVERHEAD SIGN ASSEMBLIES:
- MANUFACTURER'S CATALOG CUTS MUST BE SUBMITTED TO THE STATE AS WELL AS MANUFACTURER'S CERTIFICATION OF COMPLIANCE WITH "NYSDOT STANDARD SPECIFICATIONS"
- C. TRAFFIC SIGNAL CONDUIT, CABLE, WIRE:
- MANUFACTURER'S CATALOG CUTS MUST BE SUBMITTED TO NYSDOT.
- D. TRAFFIC SIGNAL LOOP EMBEDDING SEALER:
- ONLY THOSE PRODUCTS ON THE LATEST NYSDOT MATERIALS BUREAU "APPROVED LIST" SHALL BE USED.
- THE SIGNAL INSTALLATION CONTRACTOR SHALL CONTACT THE STATE PRIOR TO PERFORMING ANY WORK, A MEETING SHALL TAKE PLACE AS DETERMINED NECESSARY BY NYSDOT OR AT THE REQUEST OF THE CONTRACTOR.
- NYSDOT SHALL BE NOTIFIED PRIOR TO THE INSTALLATION OF ANY VEHICLE DETECTOR LOOPS. FAILURE TO DO SO MAY RESULT IN THE REJECTION OF LOOPS SO INSTALLED.
- THE PERMITTEE/CONTRACTOR IS RESPONSIBLE FOR ANY AND ALL LOCAL PERMITS REQUIRED.
- PAVEMENT MARKINGS, IF REQUIRED, SHALL BE IN ACCORDANCE WITH CURRENT NYSDOT PRACTICE FOR THE SIGNAL LOCATION.
- THE CONTRACTOR IS RESPONSIBLE FOR ARRANGING ELECTRIC SERVICE TO THE SIGNAL.
- IT IS THE PERMITTEE'S RESPONSIBILITY TO RESTORE ANY DISTURBED AREAS TO THEIR ORIGINAL CONDITION AS PER THE APPROPRIATE SECTIONS OF THE STANDARD SPECIFICATIONS.
- 10. NYSDOT SHALL PROVIDE A TABLE OF SWITCH PACKS AND TABLE OF INPUT WIRING TO THE PERMITTEE (CONTRACTOR). IT IS THE PERMITTEE'S (CONTRACTOR'S) RESPONSIBILITY TO NOTIFY NYSDOT IN ADVANCE OF WHEN THESE ARE NEEDED.
- LOOP DETECTORS ARE TO BE WIRED IN PARALLEL IN THE CABINET.
- 12. ELECTRICAL CABLE SPLICES:
 - ALL CABLE SPLICES MADE IN CABLE RUNS TO BE LOCATED BELOW GROUND WILL BE ACCOMPLISHED USING METHOD # 2 (TWO COMPONENT ELECTRICAL INSULATING RESIN REJACKETING MATERIAL) AS DESCRIBED IN SECTION 680.3.16 OF THE STANDARDS SPECIFICATIONS.
- MAINTENANCE AND PROTECTION OF TRAFFIC SHALL BE IN ACCORDANCE WITH THE MANUAL ON UNIFORM TRAFFIC CONTROL DEVICES NYS SUPPLEMENT AND THE NYSDOT STANDARD SPECIFICATIONS.
- 14. PULLBOXES:
- a. UNLESS OTHERWISE SHOWN ON THE PLANS ALL PULLBOXES SHALL BE INSTALLED OUTSIDE OF THE PAVEMENT OR SHOULDER AREA.
- b. THE FINISHED GROUND SURFACE ON THE BACK SLOPE IN THE VICINITY OF THE PULLBOX SHALL BE ADJUSTED SO THAT NO FILL SHALL BE SPILLED ON THE TOP OF THE BOX AND THE MAXIMUM DISTANCE FROM THE TOP OF THE FINISHED GROUND AT THE BOX SHALL NOT EXCEED 4 INCHES. ALL MATERIALS AND LABOR NECESSARY TO COMPLETE THIS WORK SHALL BE INCLUDED IN THE PRICE BID FOR THE PULLBOX.
- 15. THE CONTRACTOR SHALL REFERENCE NYSDOT STANDARD SHEETS 680-1, 680-2, 680-4, 680-5, 680-6, 680-8, 680-10, 680-11, 680-13 AND 680-14, 685-01 FOR THIS INSTALLATION.
- PER NYSDOT STANDARD SPECIFICATION SECTION 619-3.17 - MAINTAIN OR MODIFY TRAFFIC SIGNAL **EQUIPMENT - TRAFFIC SIGNALS SHALL BE MAINTAINED IN** PROPER OPERATION, INCLUDING THE MAINTENANCE OF ALL FEATURES OF THE TRAFFIC SIGNAL OPERATION IN EFFECT AND OPERATING AT THE TIME ANY WORK BEGINS ON THE CONTRACT. TRAFFIC ACTUATED PHASES SHALL REMAIN ACTUATED, AND SIGNALS OPERATING WITHIN SIGNAL SYSTEMS SHALL REMAIN COORDINATED WITH THE REMAINDER OF THE SYSTEM UNLESS OTHERWISE APPROVED BY THE ENGINEER. EXCEPT FOR EMERGENCIES, NO CHANGES IN THE SIGNAL OPERATION OR TIMING SHALL BE MADE WITHOUT PRIOR APPROVAL BY THE ENGINEER. IF EMERGENCY CONDITIONS DICTATE A CHANGE IN THE OPERATION, THE ENGINEER SHALL BE NOTIFIED BY THE START OF THE NEXT WORK DAY. UNLESS OTHERWISE APPROVED BY THE ENGINEER, AN ALTERED SIGNAL OPERATION MUST BE RETURNED TO THE ORIGINAL SIGNAL OPERATION WITHIN 24 HOURS.

THE CONTRACTOR SHALL MAINTAIN IN OPERATION ALL EQUIPMENT INCLUDING SIGNAL HEADS, SUPPORTS, CABLE, WIRING, SPAN-WIRE-MOUNTED SIGNING, CONTROLLERS, MASTER CONTROLLERS, DETECTOR SYSTEMS, CONFLICT AND CURRENT MONITORS, RELAYS, SWITCH PACKS, AND ALL OTHER ACCESSORY AND NECESSARY EQUIPMENT. MAINTENANCE SHALL ALSO INCLUDE THE REPAIR AND REPLACEMENT OF EXISTING DETECTOR LOOPS, PAID FOR SEPARATELY.

THE CONTRACTOR SHALL HAVE CAPABLE TRAFFIC SIGNAL REPAIR PERSONNEL ON CALL 24 HOURS A DAY, SEVEN DAYS A WEEK, AND SHALL PROVIDE TO THE ENGINEER A SINGLE TELEPHONE NUMBER FOR CONTACTING THEM. IF FOR ANY REASON A SIGNAL IS NOT FUNCTIONING PROPERLY. THE CONTRACTOR SHALL COMMENCE WORK ON THE SIGNAL WITHIN TWO (2) HOURS OF NOTIFICATION. IF DIRECTED BY THE ENGINEER, THE CONTRACTOR SHALL NOTIFY THE APPROPRIATE POLICE AGENCY FOR TRAFFIC CONTROL OPERATIONS. IF THE POLICE AGENCY CANNOT OR WILL NOT PROVIDE TRAFFIC CONTROL, THE CONTRACTOR SHALL PROVIDE FLAGGERS AT LOCATIONS SPECIFIED BY THE ENGINEER WITHIN THE 2-HOUR TIME PERIOD. THE CONTRACTOR SHALL CONTINUE THE FLAGGER SERVICES UNTIL THE SIGNAL IS IN PROPER OPERATION. A FLAGGER WARNING (W20-7 OR W20-7a) SIGN SHALL BE USED ON ALL APPROACHES TO AN INTERSECTION CONTROLLED BY FLAGGERS.

- 17. THE CLEARANCES BETWEEN ANY SIGNAL EQUIPMENT AND UTILITY LINES SHALL BE 10' FOR PRIMARY, 5.5' SECONDARY AND 2' FOR ALL OTHERS. CONTRACTOR SHALL COORDINATE HIS WORK WITH THE APPROPRIATE UTILITY COMPANY TO ENSURE PROPER CLEARANCES ARE ACHIEVED..
- 18. IF SOFT CLAY OR ORGANIC DEPOSITS ARE DURING THE FOOTING ENCOUNTERED AUGERING/DIGGING OPERATION, OR AUGERING/DIGGING IS UNDERTAKEN IN AREAS HAVING A HIGH WATER TABLE, THE CONTRACTOR SHALL CONSULT THE ENGINEER-IN-CHARGE.
- 19. CONTRACTOR SHALL CONTACT ALL THE APPROPRIATE PARTIES WITH JURISDICTION OVER THE UTILITIES (OVERHEAD AND UNDERGROUND) ENTERING ON OR NEAR THE PROJECT AREA PRIOR TO INITIATION OF CONSTRUCTION ACTIVITIES AND PROVIDE THOSE AGENCIES 72 HOURS NOTIFICATION. CONTRACTOR SHALL BE AWARE THAT OTHER UTILITIES (OVERHEAD AND/OR UNDERGROUND) NOT SHOWN ON THE PLANS MAY BE ENCOUNTERED IN THE FIELD. THE CONTRACTOR SHALL AT HIS/HER OWN EXPENSE, REPAIR OR REPLACE ANY STRUCTURES OR UTILITIES THAT HE/SHE DAMAGES, AND SHALL CONSTANTLY PROCEED WITH CAUTION TO PREVENT UNDUE INTERRUPTION TO UTILITY SERVICES.
- 20. PRIOR TO COMMENCEMENT OF WORK THE CONTRACTOR SHALL COORDINATE WITH UTILITY COMPANIES IN AREA TO RESOLVE ANY CONFLICTS BETWEEN SIGNAL EQUIPMENT AND UTILITY.
- 21. AT THE CONCLUSION OF INSTALLATION WORK AND UPON ACCEPTANCE BY THE STATE THE CONTRACTOR SHALL FURNISH AN AS-BUILT DRAWING TO NYSDOT ALONG WITH A LIST OF ALL INSTALLED EQUIPMENT.
- 22. PHASE 2 & 6 SHALL BE SET ON RECALL GREEN.
- 23. FOR PAVEMENT MARKINGS SEE SHEET NO. SP-01 24. PEDESTRIAN PUSHBUTTONS:
- PEDESTRIAN PUSHBUTTONS SHOULD BE LOCATED TO MEET ALL OF THE FOLLOWING CRITERIA:
- A. UNOBSTRUCTED AND ADJACENT TO A LEVEL ALL-WEATHER SURFACE TO PROVIDE ACCESS FROM A WHEELCHAIR; B. BETWEEN THE EDGE OF THE CROSSWALK LINE
- (EXTENDED) FARTHEST FROM THE CENTER OF THE INTERSECTION AND THE SIDE OF A CURB RAMP (IF PRESENT), BUT NOT GREATER THAN 5 FEET FROM SAID CROSSWALK LINE:
- C. A DISTANCE OF 10" MAXIMUM FROM THE PEDESTRIAN ACCESS ROUTE (PUSHBUTTON EXTENSION ARMS MAY BE USED UP TO 18" IN LENGTH);
- D. BETWEEN 1.5 AND 6 FEET FROM THE EDGE OF THE CURB, SHOULDER, OR PAVEMENT;
- E. WITH THE FACE OF THE PUSHBUTTON PARALLEL TO THE CROSSWALK TO BE USED; AND
- F. AT A MOUNTING HEIGHT OF APPROXIMATELY 3.5 FEET, BUT NO MORE THAN 4 FEET, ABOVE THE SIDEWALK.
- WHERE THERE ARE PHYSICAL CONSTRAINTS THAT MAKE IT IMPRACTICAL TO PLACE THE PEDESTRIAN PUSHBUTTON BETWEEN 1.5 AND 6 FEET FROM THE EDGE OF THE CURB, SHOULDER, OR PAVEMENT, IT SHOULD NOT BE FARTHER THAN 10 FEET FROM THE EDGE OF CURB, SHOULDER, OR PAVEMENT.

EXCEPT AS PROVIDED BELOW, WHERE TWO PEDESTRIAN PUSHBUTTONS ARE PROVIDED ON THE SAME CORNER OF A SIGNALIZED LOCATION, THE PUSHBUTTONS SHOULD BE SEPARATED BY A DISTANCE OF AT LEAST 10 FEET.

WHERE THERE ARE PHYSICAL CONSTRAINTS ON A PARTICULAR CORNER THAT MAKE IT IMPRACTICAL TO PROVIDE THE 10-FOOT SEPARATION BETWEEN THE TWO PEDESTRIAN PUSHBUTTONS, THE PUSHBUTTONS MAY BE PLACED CLOSER TOGETHER OR ON THE SAME POLE.


- IF TWO ACCESSIBLE PEDESTRIAN PUSHBUTTONS ARE PLACED LESS THAN 10 FEET APART OR ON THE SAME POLE, EACH ACCESSIBLE PEDESTRIAN PUSHBUTTON SHALL BE PROVIDED WITH THE FOLLOWING FEATURES:
- A. A PUSHBUTTON LOCATOR TONE,
- B. A TACTILE ARROW,
- C. A SPEECH WALK MESSAGE FOR THE WALKING PERSON (SYMBOLIZING WALK) INDICATION, AND

D. A SPEECH PUSHBUTTON INFORMATION MESSAGE

THE ACCESSIBLE PEDESTRIAN PUSHBUTTON SHALL BE LOCATED WITHIN 10" OF THE PEDESTRIAN ACCESS ROUTE. A MAXIMUM PUSHBUTTON EXTENSION ARM LENGTH OF 24" MAY BE USED TO ACHIEVE THIS WHERE REQUIRED.


ANY DEVIATIONS FROM THE ABOVE SHALL BE PRESENTED TO THE E.I.C. FOR REVIEW AND APPROVAL PRIOR TO INSTALLATION.

- 25. SEQUENCE OF EVENTS FOR SIGNAL CONSTRUCTION CONTRACTS (CONTRACTOR SHALL CONTACT REGION
 - 8 SIGNALS UNIT AT 845-437-3320): A. THE EIC OR INSPECTOR SHALL BE COPIED ON ALL COMMUNICATION TO AND FROM THE SIGNAL CONTRACTOR.
- B. PRECONSTRUCTION/UTILITY MEETING: NOTIFY TRAFFIC & SAFETY AS TO THE TIME AND PLACE. IT SHOULD BE CONFIRMED THAT THE CONTRACTOR HAS THE LATEST SET OF PLANS. THE EIC/INSPECTOR SHOULD DIRECT THE CONTRACTOR TO FORWARD POLE/MAST ARM SHOP DRAWINGS/CALCULATIONS TO THE TRAFFIC & SAFETY OFFICE FOR REVIEW. THIS IS TIME SENSITIVE SINCE THE MANUFACTURER MAY NEED TO REDESIGN THE
- C. REQUEST FOR POWER: REQUEST A SUBMITTAL THROUGH THE POWER REQUEST COORDINATOR THREE MONTHS BEFORE THE START OF ANY TRAFFIC SIGNAL RELATED WORK.
- D. FIRST DAY OF CONSTRUCTION: THE EIC/INSPECTOR SHALL NOTIFY THE REGIONAL TRAFFIC SIGNAL ENGINEER AND ALL SIGNAL CREW SUPERVISORS WITH THE CONTRACTOR'S EMERGENCY CONTACT INFORMATION. AN EMAIL REQUEST FOR A CABINET SHOULD BE MADE BY THE EIC/INSPECTOR TO THE REGIONAL TRAFFIC SIGNAL ENGINEER WHICH INCLUDES THE PIN#, D#, SIGNAL#, LOCATION, NUMBER OF CABINETS/DISCONNECTS NEEDED. AND IF THE CABINET IS NEEDED EARLY FOR PAINTING.
- E. SIGNAL POLE STAKE OUT: THE STAKE OUT OF THE POLE LOCATIONS SHALL BE APPROVED BY THE TRAFFIC SIGNAL UNIT BEFORE THE FOUNDATIONS ARE INSTALLED. THIS IS TO IDENTIFY ANY POSSIBLE UTILITY CLEARANCE PROBLEMS BEFORE THE POLE LOCATION IS FINALIZED. ADDITIONAL CLEARANCE CHECKS MAY BE REQUIRED BEFORE POLES/SPAN WIRES/MAST ARMS ARE INSTALLED. THE SIGNAL UTILITY COORDINATOR WILL SCHEDULE ADDITIONAL CHECKS WITH THE CONTRACTOR WHILE ON SITE.
- F. CABINET RELEASE: WIRING SHEETS WILL BE E-MAILED TO EIC/INSPECTOR AT THE TIME OF CABINET RELEASE.. THE CABINET WILL NOT BE RELEASED UNTIL ALL UTILITY CONFLICTS HAVE A RESOLUTION IN PLACE.
- G. SIGNALS UNDER CONSTRUCTION: THE CONTRACTOR IS EXPECTED TO MAINTAIN AND OPERATE TRAFFIC SIGNALS WHILE UNDER CONSTRUCTION. THE CONTRACTOR IS RESPONSIBLE FOR MAKING TIMING ADJUSTMENTS AND SHIFTING HEADS DURING CONSTRUCTION TO ACCOUNT FOR UNFINISHED DETECTION. LANE CLOSURES, AND OTHER ACTIVITIES THAT AFFECT THE OPERATION OF THE SIGNAL. TEMPORARY TURN ONS ARE ONLY ALLOWED WHEN IT IS NECESSARY TO REMOVE THE EXISTING SIGNAL TO FINISH CONSTRUCTION OF THE NEW SIGNAL. THE NEW SIGNAL CAN BE TURNED ON IF THERE ARE STOP BARS, IT PASSES THE GROUND TEST, ALL LEDS ARE WORKING, AND THE HEADS ALIGN IN THE LANES. NYDSOT WILL PROVIDE THE FINAL TIMING PLAN BEFORE A TEMPORARY TURN ON.
- H. TURN-ON: THE EIC/INSPECTOR SHOULD NOTIFY THE REGIONAL TRAFFIC SIGNAL ENGINEER WHEN THE SIGNAL IS READY FOR INSPECTION. A PRE INSPECTION WILL BE DONE TO VERIFY THAT ALL WORK IS COMPLETE, WITHIN 2 WEEKS FROM THE REQUEST, A FULL TURN ON DATE WILL BE SCHEDULED.
- I. THE CONTRACTOR SHALL INSTALL PORTABLE VARIABLE MESSAGE SIGNS (PVMS) ON ALL INTERSECTION APPROACHES FOR A MINIMUM OF ONE-WEEK PRIOR TO THE SCHEDULED TURN ON DATE, PVMS SHALL BE PAID FOR UNDER ITEM 619,110511 - PVMS STANDARD SIZE - FULL MATRIX (LED) NO OPTIONAL EQUIPMENT SPECIFIED, NO CELLULAR COMMUNICATIONS REQUIRED. CONTRACTOR SHALL CONTACT REGION 8 TRAFFIC SIGNALS UNIT TO CONFIRM PVMS MESSAGING PRIOR TO INSTALLATION.
- J. 10-DAY FUNCTIONAL TEST: A PUNCH LIST OF ANY ITEMS TO BE CORRECTED WILL BE GIVEN TO THE CONTRACTOR AT THE TURN ON. ONCE ALL OF THE ITEMS ARE COMPLETE THE 10-DAY FUNCTIONAL TEST WILL BEGIN. THE SIGNAL WILL BE ACCEPTED ONCE THE FUNCTIONAL TEST IS COMPLETE.

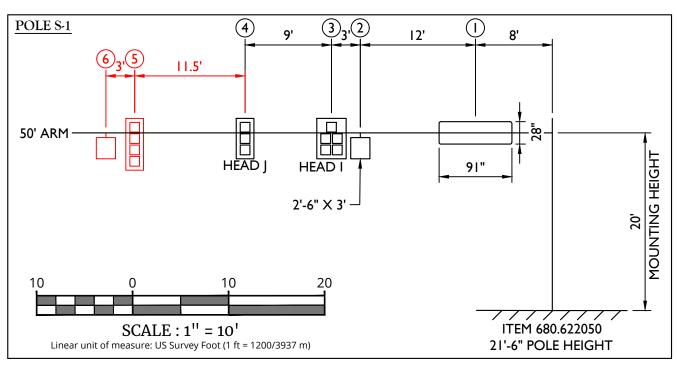


		MAST ARM LO			
LOAD NO.	TYPE	NO. OF 12" SIGNAL SECTIONS	DEAD LOAD (LB)	PROJECTED WIND AREA (SF)	PROJECTED ICE AREA (SF)
1	SIGN	-	43.50	18.0	18.0
2	SIGN	-	22.50	7.5	7.5
3	SIGNAL HEAD I	5	85.83	118.83	360.21
4	SIGNAL HEAD J	3	47.32	8.2	20.9
5	FUTURE SIGNAL HEAD	4	59.45	10.9	27.9
6	FUTURE SIGN	-	22.50	7.5	7.5
NOTES:					

- 1. WIND SPEEDS PER STANDARD SPECIFICATION SECTION 724-03.
- DEAD LOADS INCLUDE SIGNAL SECTIONS OF SIGN, BRACKETS AND HARDWARE, EXCLUSIVE OF MAST ARM AND UPRIGHT.

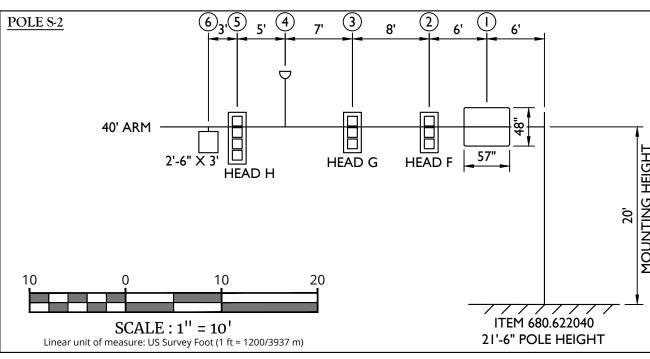


TYPE	NO. OF 12" SIGNAL SECTIONS	DEAD LOAD (LB)	PROJECTED WIND AREA (SF)	PROJECTED ICE AREA (SF)
SIGN	-	45.50	19.0	19.0
SIGNAL HEAD F	3	47.32	8.2	20.9
SIGNAL HEAD G	3	47.32	8.2	20.9
GRIDSMART CAMERA	-	10.00	1.5	1.5
SIGNAL HEAD H	4	59.45	10.9	27.9
SIGN	-	22.50	7.5	7.5
	SIGN SIGNAL HEAD F SIGNAL HEAD G GRIDSMART CAMERA SIGNAL HEAD H	TYPE NO. OF 12" SIGNAL SECTIONS SIGN - SIGNAL HEAD F 3 SIGNAL HEAD G 3 GRIDSMART CAMERA - SIGNAL HEAD H 4	TYPE SIGNAL SECTIONS DEAD LOAD (LB) SIGN - 45.50 SIGNAL HEAD F 3 47.32 SIGNAL HEAD G 3 47.32 GRIDSMART CAMERA - 10.00 SIGNAL HEAD H 4 59.45	POLE S-2 TYPE NO. OF 12" SIGNAL SECTIONS DEAD LOAD (LB) PROJECTED WIND AREA (SF) SIGN - 45.50 19.0 SIGNAL HEAD F 3 47.32 8.2 SIGNAL HEAD G 3 47.32 8.2 GRIDSMART CAMERA - 10.00 1.5 SIGNAL HEAD H 4 59.45 10.9

- 1. WIND SPEEDS PER STANDARD SPECIFICATION SECTION 724-03.
- 2. DEAD LOADS INCLUDE SIGNAL SECTIONS OF SIGN, BRACKETS AND HARDWARE, EXCLUSIVE OF MAST ARM AND UPRIGHT

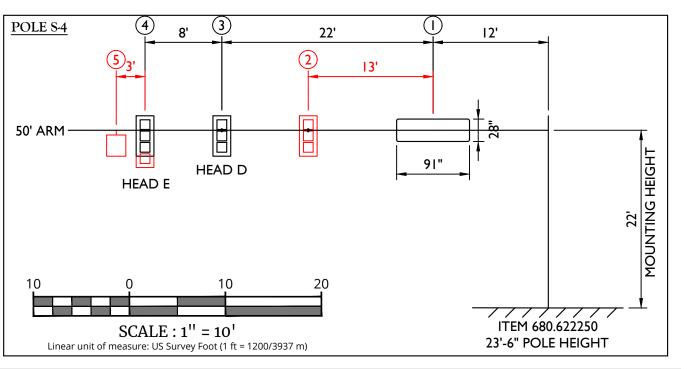

		MAST ARM L			
LOAD NO.	TYPE	NO. OF 12" SIGNAL SECTIONS	DEAD LOAD (LB)	PROJECTED WIND AREA (SF)	PROJECTED ICE AREA (SF)
1	SIGN	-	43.50	18.0	18.0
2	FUTURE SIGNAL HEAD	3	47.32	8.2	20.9
3	SIGNAL HEAD D	3	47.32	8.2	20.9
4	SIGNAL HEAD E	4	59.45	10.9	27.9
5	FUTURE SIGN	-	22.50	7.5	7.5

- WIND SPEEDS PER STANDARD SPECIFICATION SECTION 724-03.
- DEAD LOADS INCLUDE SIGNAL SECTIONS OF SIGN, BRACKETS AND HARDWARE,
- EXCLUSIVE OF MAST ARM AND UPRIGHT.
- 3. LOAD NO. 3, SIGNAL HEAD E SHALL BE A 3-SECTION HEAD WITH BACKPLATE AS INSTALLED UNDER THIS CONTRACT. HOWEVER LOADING DESIGN SHALL ACCOUNT FOR A FUTURE 4-SECTION HEAD WITH BACKPLATE AT THIS LOCATION.

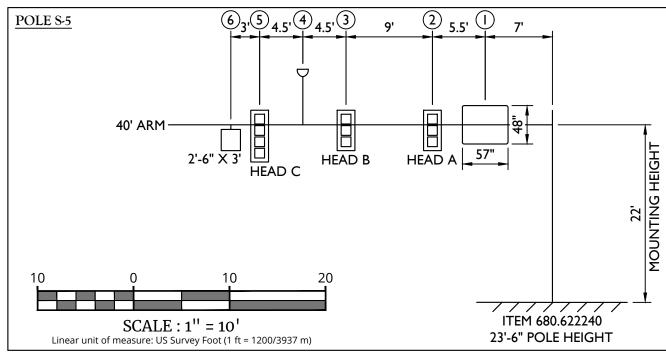

			RM LOAD TABLE POLE S-5		
LOAD NO.	TYPE	NO. OF 12" SIGNAL SECTIONS	DEAD LOAD (LB)	PROJECTED WIND AREA (SF)	PROJECTED ICE AREA (SF)
1	SIGN	-	45.50	19.0	19.0
2	SIGNAL HEAD A	3	47.32	8.2	20.9
3	SIGNAL HEAD B	3	47.32	8.2	20.9
4	GRIDSMART CAMERA	-	10.00	1.5	1.5
5	SIGNAL HEAD C	4	59.45	10.9	27.9
6	SIGN	-	22.50	7.5	7.5

- 1. WIND SPEEDS PER STANDARD SPECIFICATION SECTION 724-03. 2. DEAD LOADS INCLUDE SIGNAL SECTIONS OF SIGN, BRACKETS AND
- HARDWARE, EXCLUSIVE OF MAST ARM AND UPRIGHT.

NOTE SCALE REDUCTION

ALL INDICATED SCALES ARE REDUCED TO HALF SIZE. ORIGINAL DRAWING SIZE: 22"X34"

(SIGNAL NO. W-213)

UNAUTHORIZED ALTERATION OR ADDITION TO A SURVEY OR ENGINEERING MAP BEARING A LICENSED LAND SURVEYOR OR PROFESSIONAL ENGINEER IS A VIOLATION OF SECTION 7209, SUB-DIVISION 2, OF THE NEW YORK STATE EDUCATION LAW. ONLY MAPS WITH THE LAND SURVEYOR OR PROFESSIONAL ENGINEER'S SEAL ARE GENUINE TRUE AND CORRECT COPIES OF THE LAND SURVEYOR OR PROFESSIONAL ENGINEER'S ORIGINAL WORK AND OPINION.



Engineering & Design

www.colliersengineering.com

pyright © 2024, Colliers Engineering & Design All Rights Reserved. This draw nd all the information contained herein is authorized for use only by the party vhom the services were contracted or to whom it is certified. This drawing may e copied, reused, disclosed, distributed or relied upon for any other purp without the express written consent of Colliers Engineering & Design.

> PROTECT YOURSELF LL STATES REQUIRE NOTIFICATION (EXCAVATORS, DESIGNERS, OR ANY PERSO PREPARING TO DISTURB THE EARTH'S SURFACE ANYWHERE IN ANY STATE

FOR STATE SPECIFIC DIRECT PHONE NUMBERS VISIT: WWW.CALL811.COM



Philip John Greaty NEW YORK LICENSED PROFESSIONAL ENGINEER LICENSE NUMBER: 059858-1 COLLIERS ENGINEERING & DESIGN CT, P.C. N.Y. C.O.A #: 0017609

HIGHWAY IMPROVEMENT PLANS

UNDERHILL AVENUE **IMPROVEMENTS** (SEQR # 22-092)

NYS ROUTE 118 (S.H. 148) AT UNDERHILL AVENUE

TOWN OF YORKTOWN WESTCHESTER COUNTY **NEW YORK**

WESTCHESTER **Colliers**

400 Columbus Avenue, Suite 180E Valhalla, NY 10595 Phone: 914.347.7500 Engineering & Design ARCHITECTURE, LANDSCAPE ARCHITECT SURVEYING CT, P.C.

1/8/23 M.J.A. AS SHOWN RAWING NAME R-PL10-SGNL 20006297A

TRAFFIC SIGNAL PLAN NYS ROUTE 118 & UNDERHILL AVENUE

TSP-02

					TABLE OF SIGNAL I	POLES				
	L	OCATION		ELEV. OF		MOUNTING	ARM	FOOTING	FOUND	ATION
POLE NO.	CENTERLINE STATION	OFFSET	SIDE	FOOTING CAP	ITEM	HEIGHT	LENGTH	MOMENT (FT-KIP)	CODE	CY
S-1	124+20.98	35.79	LT	468.2' ±	680.622050	20'	50'	80	K5	1.9
S-2	125+12.37	43.03	LT	468.0' ±	680.622040	20'	40'	60	K3	1.8
S-3	125+24.90	40.88	LT	-	680.99040010	EXIST.	-	EXIST.	EXIST.	EXIST.
S-4	125+81.92	47.08	RT	465.0' ±	680.622250	22'	50'	80	K5	1.9
S-5	124+99.08	49.58	RT	464.0' ±	680.622240	22'	40'	60	K3	1.8
S-6	124+86.84	41.89	RT	-	680.99040010	EXIST.	-	EXIST.	EXIST.	EXIST.
P-1	124+23.92	40.74	LT	-	680.82250608	EXIST.	-	EXIST.	EXIST.	EXIST.
P-2	124+26.47	36.17	LT	468.3' ±	680.6808	8'	-	-	J1	1.1
P-3	124+30.77	46.24	LT	468.5' ±	680.6808	8'	-	-	J1	1.1
P-4	124+57.48	32.42	LT	-	680.82250608	EXIST.	-	-	EXIST.	EXIST.
P-5	124+86.54	68.57	LT	468.4' ±	680.6808	8'	-	-	J1	1.1
P-6	125+30.31	32.46	LT	466.9' ±	680.6808	8'	-	-	J1	1.1
P-7	125+70.39	35.05	RT	464.0' ±	680.6808	8'	-	-	J1	1.1
P-8	125+66.20	46.82	RT	463.7' ±	680.6808	8'	-	-	J1	1.1
P-9	125+18.03	69.18	RT	463.5' ±	680.6808	8'	-	-	J1	1.1
P-10	124+68.54	27.81	RT	-	680.82250608	EXIST.	-	-	EXIST.	EXIST.
P-11	124+62.71	28.28	RT	466.8' ±	680.6808	8'	-	-	J1	1.1
		•				'			TOTAL (CY)	16.2

		TABLE OF INF	PUTS	
SDLC CHANNEL	FUNCTION	DETECTION ZONE NUMBER	SIZE	REMARKS
42	Ø2	42	6' X 40'	PRESENCE
43	Ø3	43	6' X 40'	PRESENCE
44	Ø4	44	6' X 40'	PRESENCE
46	Ø6	46	6' X 40'	PRESENCE
47	Ø7	47	6' X 40'	PRESENCE
48	Ø8	48	6' X 40'	PRESENCE
49	Ø6	49	6' X 6'	NB RIGHT COUNT
50	Ø6	50	6' X 6'	NB THROUGH COUNT
51	Ø6	51	6' X 6'	NB LEFT COUNT
52	Ø8	52	6' X 6'	EB RIGHT COUNT
53	Ø8	53	6' X 6'	EB THROUGH COUNT
54	Ø3	54	6' X 6'	EB LEFT COUNT
55	Ø2	55	6' X 6'	SB RIGHT COUNT
56	Ø2	56	6' X 6'	SB THROUGH COUNT
57	Ø2	57	6' X 6'	SB LEFT COUNT
58	Ø4	58	6' X 6'	WB RIGHT COUNT
59	Ø4	59	6' X 6'	WB THROUGH COUNT
60	Ø7	60	6' X 6'	WB LEFT COUNT

	ESTIMATE OF QUANTITIES		
ITEM NO.	DESCRIPTION	UNIT	QUANTITY
206.03	CONDUIT EXCAVATION AND BACKFILL INCLUDING SURFACE RESTORATION	LF	471
619.1612	MAINTAIN TRAFFIC SIGNAL EQUIPMENT (REQUIREMENT B)	INTM	6
625.01000108	SURVEY AND STAKEOUT (TRAFFIC SIGNALS)	EA	4
662.60000108	FURNISH ELECTRICAL SERVICE	DC	1
680.05010007	360 DIGITAL CAMERA VIDEO DETECTION SYSTEM	EA	1
680.05020007	360 DEGREE CAMERA ASSEMBLY	EA	1
680.5001	POLE EXCAVATION AND CONCRETE FOUNDATION	CY	16.2
680.510501	PULLBOX - RECTANGULAR, 26" X 18", REINFORCED CONCRETE	EA	7
680.520108	CONDUIT, METAL STEEL, ZINC COATED, 3"	LF	439
680.520110	CONDUIT, METAL STEEL, ZINC COATED, 4"	LF	32
680.622040	TRAFFIC SIGNAL POLE - MAST ARM, 20 FT. MOUNTING HEIGHT, 40 FT. ARM LENGTH	EA	1
680.622050	TRAFFIC SIGNAL POLE - MAST ARM, 20 FT. MOUNTING HEIGHT, 50 FT. ARM LENGTH	EA	1
680.622240	TRAFFIC SIGNAL POLE - MAST ARM, 22 FT. MOUNTING HEIGHT, 40 FT. ARM LENGTH	EA	1
680.622250	TRAFFIC SIGNAL POLE - MAST ARM, 22 FT. MOUNTING HEIGHT, 50 FT. ARM LENGTH	EA	1
680.6808	TRAFFIC SIGNAL POLE-BRACKET MOUNT 8 FEET MOUNTING HEIGHT	EA	8
680.700603	RISER ASSEMBLY, 1" DIAMETER	EA	1
680.730514	SIGNAL CABLE, 5 CONDUCTORS, 14 AWG	LF	2830
680.731014	SIGNAL CABLE, 10 CONDUCTORS, 14 AWG	LF	648
680.79000005	REMOVE TRAFFIC SIGNAL INSTALLATION	EA	1
680.80324515	INSTALL MICROCOMPUTER CABINET	EA	1
680.810101	TRAFFIC SIGNAL MODULE - 12 INCH, RED BALL, LED	EA	8
680.810102	TRAFFIC SIGNAL MODULE - 12 INCH, RED ARROW, LED	EA	2
680.810103	TRAFFIC SIGNAL MODULE - 12 INCH, YELLOW BALL, LED	EA	8
680.810104	TRAFFIC SIGNAL MODULE - 12 INCH, YELLOW ARROW, LED	EA	5
680.810105	TRAFFIC SIGNAL MODULE - 12 INCH, GREEN BALL, LED	EA	8
680.810106	TRAFFIC SIGNAL MODULE - 12 INCH, GREEN ARROW, LED	EA	3
680.810107	TRAFFIC SIGNAL SECTION - TYPE I, 12 INCH	EA	34
680.81230008	TRAFFIC SIGNAL BRACKET ASSEMBLY - 1 WAY, MAST ARM MOUNT (CABLETYPE)	EA	9
680.81240008	TRAFFIC SIGNAL BRACKET ASSEMBLY - 2 WAY, MAST ARM MOUNT (CABLETYPE)	EA	1
680.8151	ACCESSIBLE PEDESTRIAN SIGNAL (APS) WITHOUT POST	EA	8
680.813103	PEDESTRIAN SIGNAL SECTION - TYPE I, 12 INCH	EA	16
680.813105	PEDESTRIAN SIGNAL MODULE - 12 INCH BI-MODAL, HAND/MAN SYMBOLS LED	EA	8
680.8141	PEDESTRIAN SIGNAL BRACKET MOUNT ASSEMBLY	EA	8
680.815001	PEDESTRIAN SIGNAL MODULE - 12 INCH COUNTDOWN TIMER, LED	EA	8
680.8199	BACKPLATES FOR TRAFFIC SIGNAL HEADS	EA	10
680.8207	OVERHEAD SIGN ASSEMBLY, TYPE G	EA	7
680.8223	BREAKAWAY TRANSFORMER BASE	EA	8
680.82250608	REMOVE AND DISPOSE PEDESTRIAN POLE AND FOUNDATION	EA	3
680.82250801	REMOVE TRAFFIC SIGNAL PULLBOXES	EA	7
680.90920008	ELECTRIC METER SOCKET, 200 AMP, SINGLE PHASE, 240/120VOLT W/ BYPASS SWITCH FOR SIGNAL INSTALLATIONS	EA	1
680.94000008	TRAFFIC SIGNAL SERVICE ENTRANCE	EA	1
680.9499	INSTALL ELECTRICAL DISCONNECT/GENERATOR TRANSFER SWITCH	EA	1
680.950206	ELECTRICAL SERVICE CABLE 2 WIRE 6 GAUGE	LF	14
680.99040010	REMOVE TRAFFIC SIGNAL POLE	EA	2

			TABLE OF P	ULLBOXES		
		LOCATION			680.510501	680.82250801
PULLBOX NO.	CENTERLINE STATION	OFFSET	SIDE	ELEV. OF TOP	RECTANGULAR 26" X 18" RC	REMOVE TRAFFIC SIGNAL PULLBOXES
PB-1	124+26.10	47.15	LT	468.9' ±	1	0
PB-2	124+18.87	52.24	LT	-	0	1
PB-3	124+52.26	39.41	LT	-	0	1
PB-4	124+83.08	74.85	LT	469.0' ±	1	0
PB-5	125+11.61	37.68	LT	-	0	1
PB-6	125+16.94	44.40	LT	468.7' ±	1	0
PB-7	125+65.59	28.61	RT	-	0	1
PB-8	125+78.01	50.55	RT	465.0' ±	1	0
PB-9	125+51.46	47.66	RT	-	0	1
PB-10	125+23.44	69.14	RT	-	0	1
PB-11	125+21.24	81.03	RT	462.0' ±	1	0
PB-12	124+95.82	54.16	RT	463.0' ±	1	0
PB-13	124+80.66	29.56	RT	-	0	1
PB-14	124+61.03	38.77	RT	462.8' ±	1	0
		•		TOTAL	7	7

		C-28	IND	UCTION	LOOP	PB-	13		TO BE DONED		-		-		
		C-29		P-11		PB-	14		-		12		-		E OF NEW YORK
		C-30		PB-1		PB-	14		-		90		-		
			•			TOTAL	(FEET)		0		439		32		1 20
															Philip John Grealy NEW YORK LICENSED PROFESSIONAL ENGINEER LICENSE NUMBER: 059858-1 COLLIERS ENGINEERING & DESIGN CT, P.C.
															N.Y. C.O.A #: 0017609
															HIGHWAY IMPROVEMENT PLANS
					TAI	BLE OF OF	PERATION]							FOR
FACE	1	2	3	4	5	6	7	8	9	10	PED 1	PED 2	PED 3	PED 4	UNDERHILL AVENUE IMPROVEMENTS
	G	G	R	R	←R	R	R	<r−< del=""></r−<>	R	R	DW	DW ¹	DW	DW	(SEQR # 22-092)
	R	R -G>	R	R	←G	R	R	←R	R	R	DW	DW	DW	DW	
	R	R	R	R	<fy< del=""></fy<>	R	R	←R	G	G	DW ¹	DW	DW	DW	
	R	R	G	G	←R	R	R	<r−< del=""></r−<>	R	R	DW	DW	DW	DW ¹	NYS ROUTE 118 (S.H. 148) AT UNDERHILL AVENUE
	R	R	R	R	<r−< del=""></r−<>	R	R	< G−	R	R	DW	DW	DW	DW	TOWN OF YORKTOWN
	R	R	R	R	<r−< del=""></r−<>	G	G	< FY−	R	R	DW	DW	DW ¹	DW	WESTCHESTER COUNTY
	G	G	G	G	<r−< del=""></r−<>	R	R	<r< del=""></r<>	R	R	DW	DW ¹	DW	DW ¹	NEW YORK
	R	R — G >	R	R	<g−< del=""></g−<>	R	R	< G−	R	R	DW	DW	DW	DW	Colliers WESTCHESTER 400 Columbus Avenue, Suite 180E
	R	R -G>	R	R	< G−	G	G	<fy< del=""></fy<>	R	R	DW	DW	DW ¹	DW	Valhalla, NY 10595 Engineering Phone: 914.347.7500
	R	R	R	R	<fy< del=""></fy<>	R	R	<g< del=""></g<>	G	G	DW ¹	DW	DW	DW	COLLIERS ENGINEERING & DESIGN, ARCHITECTURE, LANDSCAPE ARCHITECTURE, SURVEYING CT, P.C.
	R	R	R	R	←FY	G	G	< ₽ /	G	G	DW ¹	DW	DW ¹	DW	SCALE: DATE: DRAWN BY: CHECKED BY:
ATION	FY	FY	FY	FY	DARK	FR	FR	DARK	FR	FR	DARK	DARK	DARK	DARK	AS SHOWN 1/8/23 M.J.A. R.G.D. PROJECT NUMBER: DRAWING NAME:

NOTES:

I. PEDESTRIAN SIGNAL TO BE DEMAND ACTUATED ONLY UPON ACTUATION OF A PEDESTRIAN PUSH BUTTON THE INDICATIONS SHALL DISPLAY A STEADY "MAN" FOLLOWED BY A FLASHING "HAND" AND COUNTDOWN TIMER AND THEN A STEADY "HAND".

		ESTIMATE	OF CONDUITS		
CONDUIT NO.	LOCATIO	NC	2" STEEL	680.520108	680.520110
CONDUIT NO.	FROM	ТО	Z" STEEL	3" STEEL	4" STEEL
C-1	P-2	PB-1	-	11	-
C-2	S-1	PB-1	-	-	13
C-3	PB-3	PB-2	EX. TO BE ABANDONED	-	-
C-4	INDUCTION LOOP	PB-2	EX. TO BE ABANDONED	-	-
C-5	P-3	PB-1	-	5	-
C-6	P-4	PB-3	EX. TO BE ABANDONED	-	-
C-7	PB-4	PB-1	-	65	-
C-8	P-5	PB-4	-	7	-
C-9	PB-6	PB-4	-	44	-
C-10	PB-3	PB-5	EX. TO BE ABANDONED	-	-
C-11	S-2	PB-6	-	-	9
C-12	PB-5	S-3	EX. TO BE ABANDONED	-	-
C-13	P-6	PB-6	-	20	-
C-14	INDUCTION LOOP	PB-5	EX. TO BE ABANDONED	-	-
C-15	INDUCTION LOOP	PB-7	EX. TO BE ABANDONED	-	-
C-16	P-7	PB-8	-	18	-
C-17	P-8	PB-8	-	13	
C-18	S-4	PB-8	-	-	5
C-19	PB-7	PB-9	EX. TO BE ABANDONED	-	-
C-20	PB-8	PB-11		64	-
C-21	PB-9	PB-10	EX. TO BE ABANDONED	-	-
C-22	P-9	PB-11	-	13	-
C-23	PB-10	PB-13	EX. TO BE ABANDONED	-	-
C-24	PB-11	PB-12		39	-
C-25	PB-12	S-5	-	-	5
C-26	PB-14	PB-12	-	38	
C-27	P-10	PB-13	EX. TO BE ABANDONED	-	-
C-28	INDUCTION LOOP	PB-13	EX. TO BE ABANDONED	-	-
C-29	P-11	PB-14	-	12	-
C-30	PB-1	PB-14	-	90	-
		TOTAL (FEET)	0	439	32

PHASE FACE	1	2	3	4	5 TAI	BLE OF OF	PERATION 7	8	9	10	PED 1	PED 2	PED 3	PED 4
ø2	G	G	R	R	<r< del="">−</r<>	R	R	<r−< del=""></r−<>	R	R	DW	DW ¹	DW	DW
ø3	R	R -G>	R	R	≺G	R	R	<r< del="">−</r<>	R	R	DW	DW	DW	DW
ø4	R	R	R	R	< FY-	R	R	←R	G	G	DW ¹	DW	DW	DW
ø6	R	R	G	G	≺R	R	R	<r< del="">−</r<>	R	R	DW	DW	DW	DW ¹
ø7	R	R	R	R	<r< del=""></r<>	R	R	≺G	R	R	DW	DW	DW	DW
ø8	R	R	R	R	<r< del=""></r<>	G	G	< FY-	R	R	DW	DW	DW ¹	DW
ø2+ø6	G	G	G	G	<r< del=""></r<>	R	R	<r< del=""></r<>	R	R	DW	DW ¹	DW	DW ¹
ø3+ø7	R	R -G>	R	R	<g< del=""></g<>	R	R	<g< del=""></g<>	R	R	DW	DW	DW	DW
ø3+ø8	R	R -G>	R	R	<g−< del=""></g−<>	G	G	<fy< del=""></fy<>	R	R	DW	DW	DW ¹	DW
ø4+ø7	R	R	R	R	< FY−	R	R	<g< del=""></g<>	G	G	DW ¹	DW	DW	DW
ø4+ø8	R	R	R	R	< F Y −	G	G	<fy< del=""></fy<>	G	G	DW ¹	DW	DW ¹	DW
FLASH OPERATION	FY	FY	FY	FY	DARK	FR	FR	DARK	FR	FR	DARK	DARK	DARK	DARK

Colliers

Colliers

Engineering & Design

www.colliersengineering.com

Copyright © 2024. Colliers Engineering & Design All Rights Reserved. This drawing and all the information contained herein is authorized for use only by the party for whom the services were contracted or to whom it is certified. This drawing may no be copied, reused, disclosed, distributed or relied upon for any other purpose without the express written consent of Colliers Engineering & Design.

FOR STATE SPECIFIC DIRECT PHONE NUMBERS VISIT: WWW.CALL811.COM

PROTECT YOURSELF
ALL STATES REQUIRE NOTIFICATION OF EXCAVATORS, DESIGNERS, OR ANY PERSON PREPARING TO DISTURB THE EARTH'S SURFACE ANYWHERE IN ANY STATE

AS SHOWN 1/8/23 M.J.A. PROJECT NUMBER: R-PL10-SGNL 20006297A

TRAFFIC SIGNAL PLAN NYS ROUTE 118 & UNDERHILL AVENUE (SIGNAL NO. W-213)

TSP-03

			TABLE OF P	EDESTRIAN II	NDICATIONS									
ITEM NUMBER	DESCRIPTION	UNIT	P-1	P-2	P-3	P-4	P-5	P-6	P-7	P-8	P-9	P-10	P-11	TOTAL
680.5001	POLE EXCAVATION AND CONCRETE FOUNDATION	CY	-	1.1	1.1	-	1.1	1.1	1.1	1.1	1.1	-	1.1	8.8
680.6808	TRAFFIC SIGNAL POLE-BRACKET MOUNT 8 FEET MOUNTING HEIGHT	EA	-	1	1	-	1	1	1	1	1	-	1	8
680.8151	ACCESSIBLE PEDESTRIAN SIGNAL (APS) WITHOUT POST	EA	-	1	1	-	1	1	1	1	1	-	1	8
680.813103	PEDESTRIAN SIGNAL SECTION - TYPE I, 12 INCH	EA	-	2	2	-	2	2	2	2	2	-	2	16
680.813105	PEDESTRIAN SIGNAL MODULE - 12 INCH BI-MODAL,HAND/MAN SYMBOLS LED	EA	-	1	1	-	1	1	1	1	1	-	1	8
680.8141	PEDESTRIAN SIGNAL BRACKET MOUNT ASSEMBLY	EA	-	1	1	-	1	1	1	1	1	-	1	8
680.815001	PEDESTRIAN SIGNAL MODULE - 12 INCH COUNTDOWN TIMER, LED	EA	-	1	1	-	1	1	1	1	1	-	1	8
680.8223	BREAKAWAY TRANSFORMER BASE	EA	-	1	1	-	1	1	1	1	1	-	1	8
680.82250608	REMOVE AND DISPOSE PEDESTRIAN POLE AND FOUNDATION	EA	1	-	-	1	-	-	-	-	-	1	-	3

NOTES.
NOTES: 1. ALL MOUNTING HARDWARE SHALL BE PROVIDED BY THE MANUFACTURER AND BE INCLUDED IN THE PRICE OF THE 360 DEGREE VIDEO DETECTION SYSTEM. 2. ALL EQUIPMENT SHALL MEET THE CONTRACT SPECIFICATION. STYLE OF CAMERA AND HARDWARE MAY VARY BY MANUFACTURER. BODY MOUNT BODY MOUNT BODY MOUNT 360 DEGREE CAMERA
EXISTING/PROPOSED— SPAN WIRE SIGNAL POLE POLE ASSEMBLY
BAND CLAMP KIT
1 VIDEO DETECTION CAMERA DETAIL MOUNTED ON A SPAN WIRE POLE NOT TO SCALE NYDT-SGNL-1000 08/1

	ESTIMA	TE OF CABLES				
	ROUTE		CABLE	# OF	680.730514	680.731014
FROM	THROUGH	ТО	DESCRIPTION	CABLES	5 C, 14 AWG	10 C, 14 AWC
CONTROLLER	S-5	SIGNAL HEAD A	14-05C-A-X/X	1	42	-
CONTROLLER	S-5	SIGNAL HEAD B	14-05C-B-X/X	1	54	-
CONTROLLER	S-5	SIGNAL HEAD C	14-10C-C-X/X	1	-	64
CONTROLLER	S-5, C-25, PB-12, C-24, PB-11, C-20, PB-8, C-18, S-4	SIGNAL HEAD D	14-05C-D-X/X	1	200	-
CONTROLLER	S-5, C-25, PB-12, C-24, PB-11, C-20, PB-8, C-18, S-4	SIGNAL HEAD E	14-05C-E-X/X	1	208	-
CONTROLLER	S-5, C-25, PB-12, C-26, PB-14, C-30, PB-1, C-7, PB-4, C-9, PB-6, C-11, S-2	SIGNAL HEAD F	14-05C-F-X/X	1	341	-
CONTROLLER	S-5, C-25, PB-12, C-26, PB-14, C-30, PB-1, C-7, PB-4, C-9, PB-6, C-11, S-2	SIGNAL HEAD G	14-05C-G-X/X	1	351	-
CONTROLLER	S-5, C-25, PB-12, C-26, PB-14, C-30, PB-1, C-7, PB-4, C-9, PB-6, C-11, S-2	SIGNAL HEAD H	14-10C-H-X/X	1	-	360
CONTROLLER	S-5, C-25, PB-12, C-26, PB-14, C-30, PB-1, C-2, S-1	SIGNAL HEAD I	14-10C-I-X/X	1	-	224
CONTROLLER	S-5, C-25, PB-12, C-26, PB-14, C-30, PB-1, C-2, S-1	SIGNAL HEAD J	14-05C-J-X/X	1	238	-
CONTROLLER	S-5, C-25, PB-12, C-26, PB-14, C-30, PB-1, C-1, P-2	PED P-2	14-05C	1	184	-
CONTROLLER	S-5, C-25, PB-12, C-26, PB-14, C-30, PB-1, C-5, P-3	PED P-3	14-05C	1	177	-
CONTROLLER	S-5, C-25, PB-12, C-26, PB-14, C-30, PB-1, C-7, PB-4, C-8, P-5	PED P-5	14-05C	1	253	-
CONTROLLER	S-5, C-25, PB-12, C-26, PB-14, C-30, PB-1, C-7, PB-4, C-9, PB-6, C-13, P-6	PED P-6	14-05C	1	324	-
CONTROLLER	S-5, C-25, PB-12, C-24, PB-11, C-20, PB-8, C-16, P-7	PED P-7	14-05C	1	158	-
CONTROLLER	S-5, C-25, PB-12, C-24, PB-11, C-20, PB-8, C-17, P-8	PED P-8	14-05C	1	152	-
CONTROLLER	S-5, C-25, PB-12, C-24, PB-11, C-22, P-9	PED P-9	14-05C	1	76	-
CONTROLLER	S-5, C-25, PB-12, C-26, PB-14, C-29, P-11	PED P-11	14-05C	1	72	-
	· ·		•	TOTAL	2830	648

		TABLE	OF SIG	NAL H	IEADS					
				Γ	MOD	ULES			SECTI	ON
HEAD	BRACKET	FACE	680.810101 RED BALL - 12 IN.	680.810102 RED ARROW - 12 IN.	680.810103 YELLOW BALL - 12 IN.	680.810104 YELLOW ARROW - 12 IN.	680.810105 GREEN BALL - 12 IN.	680.810106 GREEN ARROW - 12 IN.	680.810107 TRAFFIC SIGNAL SECTION, TYPE I - 12 IN.	680.8199 TRAFFIC SIGNAL BACKPLATE
Α	680.81230008	7	1	-	1	-	1	-	3	1
В	680.81230008	6	1	-	1	-	1	-	3	1
С	680.81230008	5	-	1	-	2	-	1	4	1
D	680.81230008	4	1	-	1	-	1	-	3	1
Е	680.81230008	3	1	-	1	-	1	-	3	1
F	680.81230008	10	1	-	1	-	1	1	3	1
G	680.81230008	9	1	-	1	-	1	1	3	1
Н	680.81230008	8	-	1	-	2	-	1	4	1
I	680.81240008	2	1	-	1	1	1	1	5	1
J	680.81230008	1	1	-	1	-	1	ı	3	1
	TOT	TAL (EACH)	8	2	8	5	8	3	34	10

Engineering & Design


www.colliersengineering.com

Copyright © 2024. Colliers Engineering & Design All Rights Reserved. This drawing and all the information contained herein is authorized for use only by the party for whom the services were contracted or to whom it is certified. This drawing may not be copied, reused, disclosed, distributed or relied upon for any other purpose without the express written consent of Colliers Engineering & Design.



FOR STATE SPECIFIC DIRECT PHONE NUMBERS
VISIT: WWW.CALL811.COM

_										
DESCRIPTION	REVISED PER NYSDOT COMMENTS RECEIVED 3/19/24	REVISED PER NYSDOT 4/25/24 COMMENTS.	REVISED PER NYSDOT 5/2/24 COMMENTS.	REVISED TRAFFIC SIGNAL PLAN SHEETS PER NYSDOT SIGNAL GROUP 5/23/24 EMAIL COMMENTS.	REVISED PER NYSDOT 7/1/24 COMMENTS.	REVISED PER NYSDOT 7/31/24 COMMENTS.	REVISED PER QA/QC REVIEW	REVISED PER NYSDOT 8/30/24 COMMENTS.	REVISED PER NYSDOT 9/20/24 COMMENTS. FINAL SET FOR PERMITTING.	
DRAWN BY	M.J.A.	J.F.M.	M.J.A.	M.J.A.	M.J.A.	M.J.A.	RGD	M.J.A.	M.J.A.	
DATE	4/3/24	4/26/24	5/14/24	5/24/24	7/1/24	8/7/24	8/15/24	9/12/24	9/23/24	
REV	-	2	3	4	5	9	7	8	6	

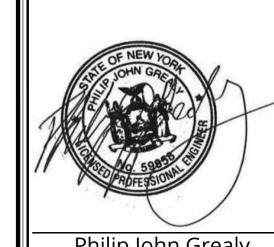

Philip John Grealy
NEW YORK LICENSED PROFESSIONAL ENGINEER
LICENSE NUMBER: 059858-1
COLLIERS ENGINEERING & DESIGN CT, P.C.
N.Y. C.O.A #: 0017609

HIGHWAY IMPROVEMENT PLANS

FOR

UNDERHILL AVENUE
IMPROVEMENTS
(SEQR # 22-092)

NYS ROUTE 118 (S.H. 148) AT UNDERHILL AVENUE

TOWN OF YORKTOWN
WESTCHESTER COUNTY
NEW YORK

Colliers

WESTCHESTER

400 Columbus Avenue,
Suite 180E
Valhalla, NY 10595

Valhalla, NY 10595

Engineering Phone: 914.347.7500

COLIERS ENGINEERING & DESIGN, ARCHITECTURE, LANDSCAPE ARCHITECTURE, SURVEYING CT, P.C.

 SCALE:
 DATE:
 DRAWN BY:
 CHECKED BY:

 AS SHOWN
 1/8/23
 M.J.A.
 R.G.D.

 PROJECT NUMBER:
 DRAWING NAME:

 20006297A
 R-PL10-SGNL

SHEET TITLE: TRAFFIC SIGNAL PLAN
NYS ROUTE 118 &
UNDERHILL AVENUE
(SIGNAL NO. W-213)

HEET NUMBER:

TSP-04

WORK ZONE TRAFFIC CONTROL NOTES:

- 1. SOME SIGNS/DRUMS TO REMAIN IN PLACE FOR THE DURATION OF THE PROJECT.
- 2. REMOVE OR COMPLETELY COVER SIGNS WHERE NOT APPLICABLE.
- 3. ADJUST SIGNS/DRUMS AS NECESSARY TO ADDRESS TRAFFIC LANES/CONDITIONS.
- 4. ROAD WORK CAN ONLY TAKE PLACE ON ONE SIDE OF THE ROADWAY AT A TIME & MPT CONTROL.
- 5. ALL LANES OF TRAFFIC SHALL BE OPEN TO TRAFFIC AT THE END OF EACH WORK DAY/SHIFT.
- SEE SHEET NO. GN-01 & GN-02 FOR CONSTRUCTION/DROP OFF NOTES.
- 7. ALL WORK TO BE COMPLETED IN ACCORDANCE WITH NYSDOT STANDARD SPECIFICATIONS SECTION 619 WORK ZONE TRAFFIC
- 8. CONTRACTOR SHALL REFER TO NYSDOT STANDARD SHEETS 619-010, 619-011, 619-407, 619-410 AND 619-421 FOR ADDITIONAL INFORMATION.
- 9. PEDESTRIAN ACCESS WHERE EXCAVATIONS OR OTHER WORK OCCUR ON OR NEAR SIDEWALKS OR OTHER PEDESTRIAN WAYS, THE CONTRACTOR SHALL PROVIDE A SAFE & ORDERLY PEDESTRIAN PASSAGE THAT COMPLIES WITH ADA STANDARDS AROUND OR THROUGH THE WORK AREA. THE PEDESTRIAN PASSAGE SHALL NOT SUBJECT PEDESTRIANS TO HAZARDS FROM TRAFFIC OR CONSTRUCTION OPERATIONS NOR CAUSE THE PEDESTRIANS TO WALK UPON UNSUITABLE OR HAZARDOUS SURFACES. CONSTRUCTION MATERIALS, VEHICLES, EQUIPMENT, DEBRIS, TEMPORARY SIGN SUPPORTS OR OTHER MATERIALS SHALL NOT BE PLACED OR STORED ON OPEN SIDEWALKS OR WALKWAYS UNLESS EXPRESSLY SHOWN IN THE CONTRACT DOCUMENTS OR APPROVED BY THE ENGINER. UPON COMPLETION OF THE WORK AT EACH LOCATION, THE CONTRACTOR SHALL REMOVE ALL REMAINING MATERIAL AND EQUIPMENT AND SHALL LEAVE THE AFFECTED AREAS(S) IN A NEAT CONDITION.
- 10. PER NYSDOT STANDARD SPECIFICATION SECTION 619-3.17 MAINTAIN OR MODIFY TRAFFIC SIGNAL EQUIPMENT TRAFFIC SIGNALS SHALL BE MAINTAINED IN PROPER OPERATION, INCLUDING THE MAINTENANCE OF ALL FEATURES OF THE TRAFFIC SIGNAL OPERATION IN EFFECT AND OPERATING AT THE TIME ANY WORK BEGINS ON THE CONTRACT. TRAFFIC ACTUATED PHASES SHALL REMAIN ACTUATED, AND SIGNALS OPERATING WITHIN SIGNAL SYSTEMS SHALL REMAIN COORDINATED WITH THE REMAINDER OF THE SYSTEM UNLESS OTHERWISE APPROVED BY THE ENGINEER. EXCEPT FOR EMERGENCIES, NO CHANGES IN THE SIGNAL OPERATION OR TIMING SHALL BE MADE WITHOUT PRIOR APPROVAL BY THE ENGINEER. IF EMERGENCY CONDITIONS DICTATE A CHANGE IN THE OPERATION, THE ENGINEER SHALL BE NOTIFIED BY THE START OF THE NEXT WORK DAY. UNLESS OTHERWISE APPROVED BY THE ENGINEER, AN ALTERED SIGNAL OPERATION MUST BE RETURNED TO THE ORIGINAL SIGNAL OPERATION WITHIN 24 HOURS

THE CONTRACTOR SHALL MAINTAIN IN OPERATION ALL EQUIPMENT INCLUDING SIGNAL HEADS, SUPPORTS, CABLE, WIRING, SPAN-WIRE-MOUNTED SIGNING, CONTROLLERS, MASTER CONTROLLERS, DETECTOR SYSTEMS, CONFLICT AND CURRENT MONITORS, RELAYS, SWITCH PACKS, AND ALL OTHER ACCESSORY AND NECESSARY EQUIPMENT. MAINTENANCE SHALL ALSO INCLUDE THE REPAIR AND REPLACEMENT OF EXISTING DETECTOR LOOPS, PAID FOR SEPARATELY.

THE CONTRACTOR SHALL HAVE CAPABLE TRAFFIC SIGNAL REPAIR PERSONNEL ON CALL 24 HOURS A DAY, SEVEN DAYS A WEEK, AND SHALL PROVIDE TO THE ENGINEER A SINGLE TELEPHONE NUMBER FOR CONTACTING THEM. IF FOR ANY REASON A SIGNAL IS NOT FUNCTIONING PROPERLY, THE CONTRACTOR SHALL COMMENCE WORK ON THE SIGNAL WITHIN TWO (2) HOURS OF NOTIFICATION. IF DIRECTED BY THE ENGINEER, THE CONTRACTOR SHALL NOTIFY THE APPROPRIATE POLICE AGENCY FOR TRAFFIC CONTROL OPERATIONS. IF THE POLICE AGENCY CANNOT OR WILL NOT PROVIDE TRAFFIC CONTROL, THE CONTRACTOR SHALL PROVIDE FLAGGERS AT LOCATIONS SPECIFIED BY THE ENGINEER WITHIN THE 2-HOUR TIME PERIOD. THE CONTRACTOR SHALL CONTINUE THE FLAGGER SERVICES UNTIL THE SIGNAL IS IN PROPER OPERATION. A FLAGGER WARNING (W20-7 OR W20-7a) SIGN SHALL BE USED ON ALL APPROACHES TO AN INTERSECTION CONTROLLED BY FLAGGERS.

11. CONTRACTOR SHALL CONTACT THE HUDSON VALLEY TRAFFIC MANAGEMENT CENTER AT 914-742-6057 PRIOR TO PLACING THE EXISTING TRAFFIC SIGNAL ON FLASHING OPERATION DURING ANY WORK ZONE TRAFFIC CONTROL SETUP.

LEGEND

DESCRIPTION


FLAGGER

BARRIER VEHICLE

CHANNELIZING DEVICES

CONSTRUCTION SIGNS

DIRECTION AND NUMBER OF TRAFFIC LANES

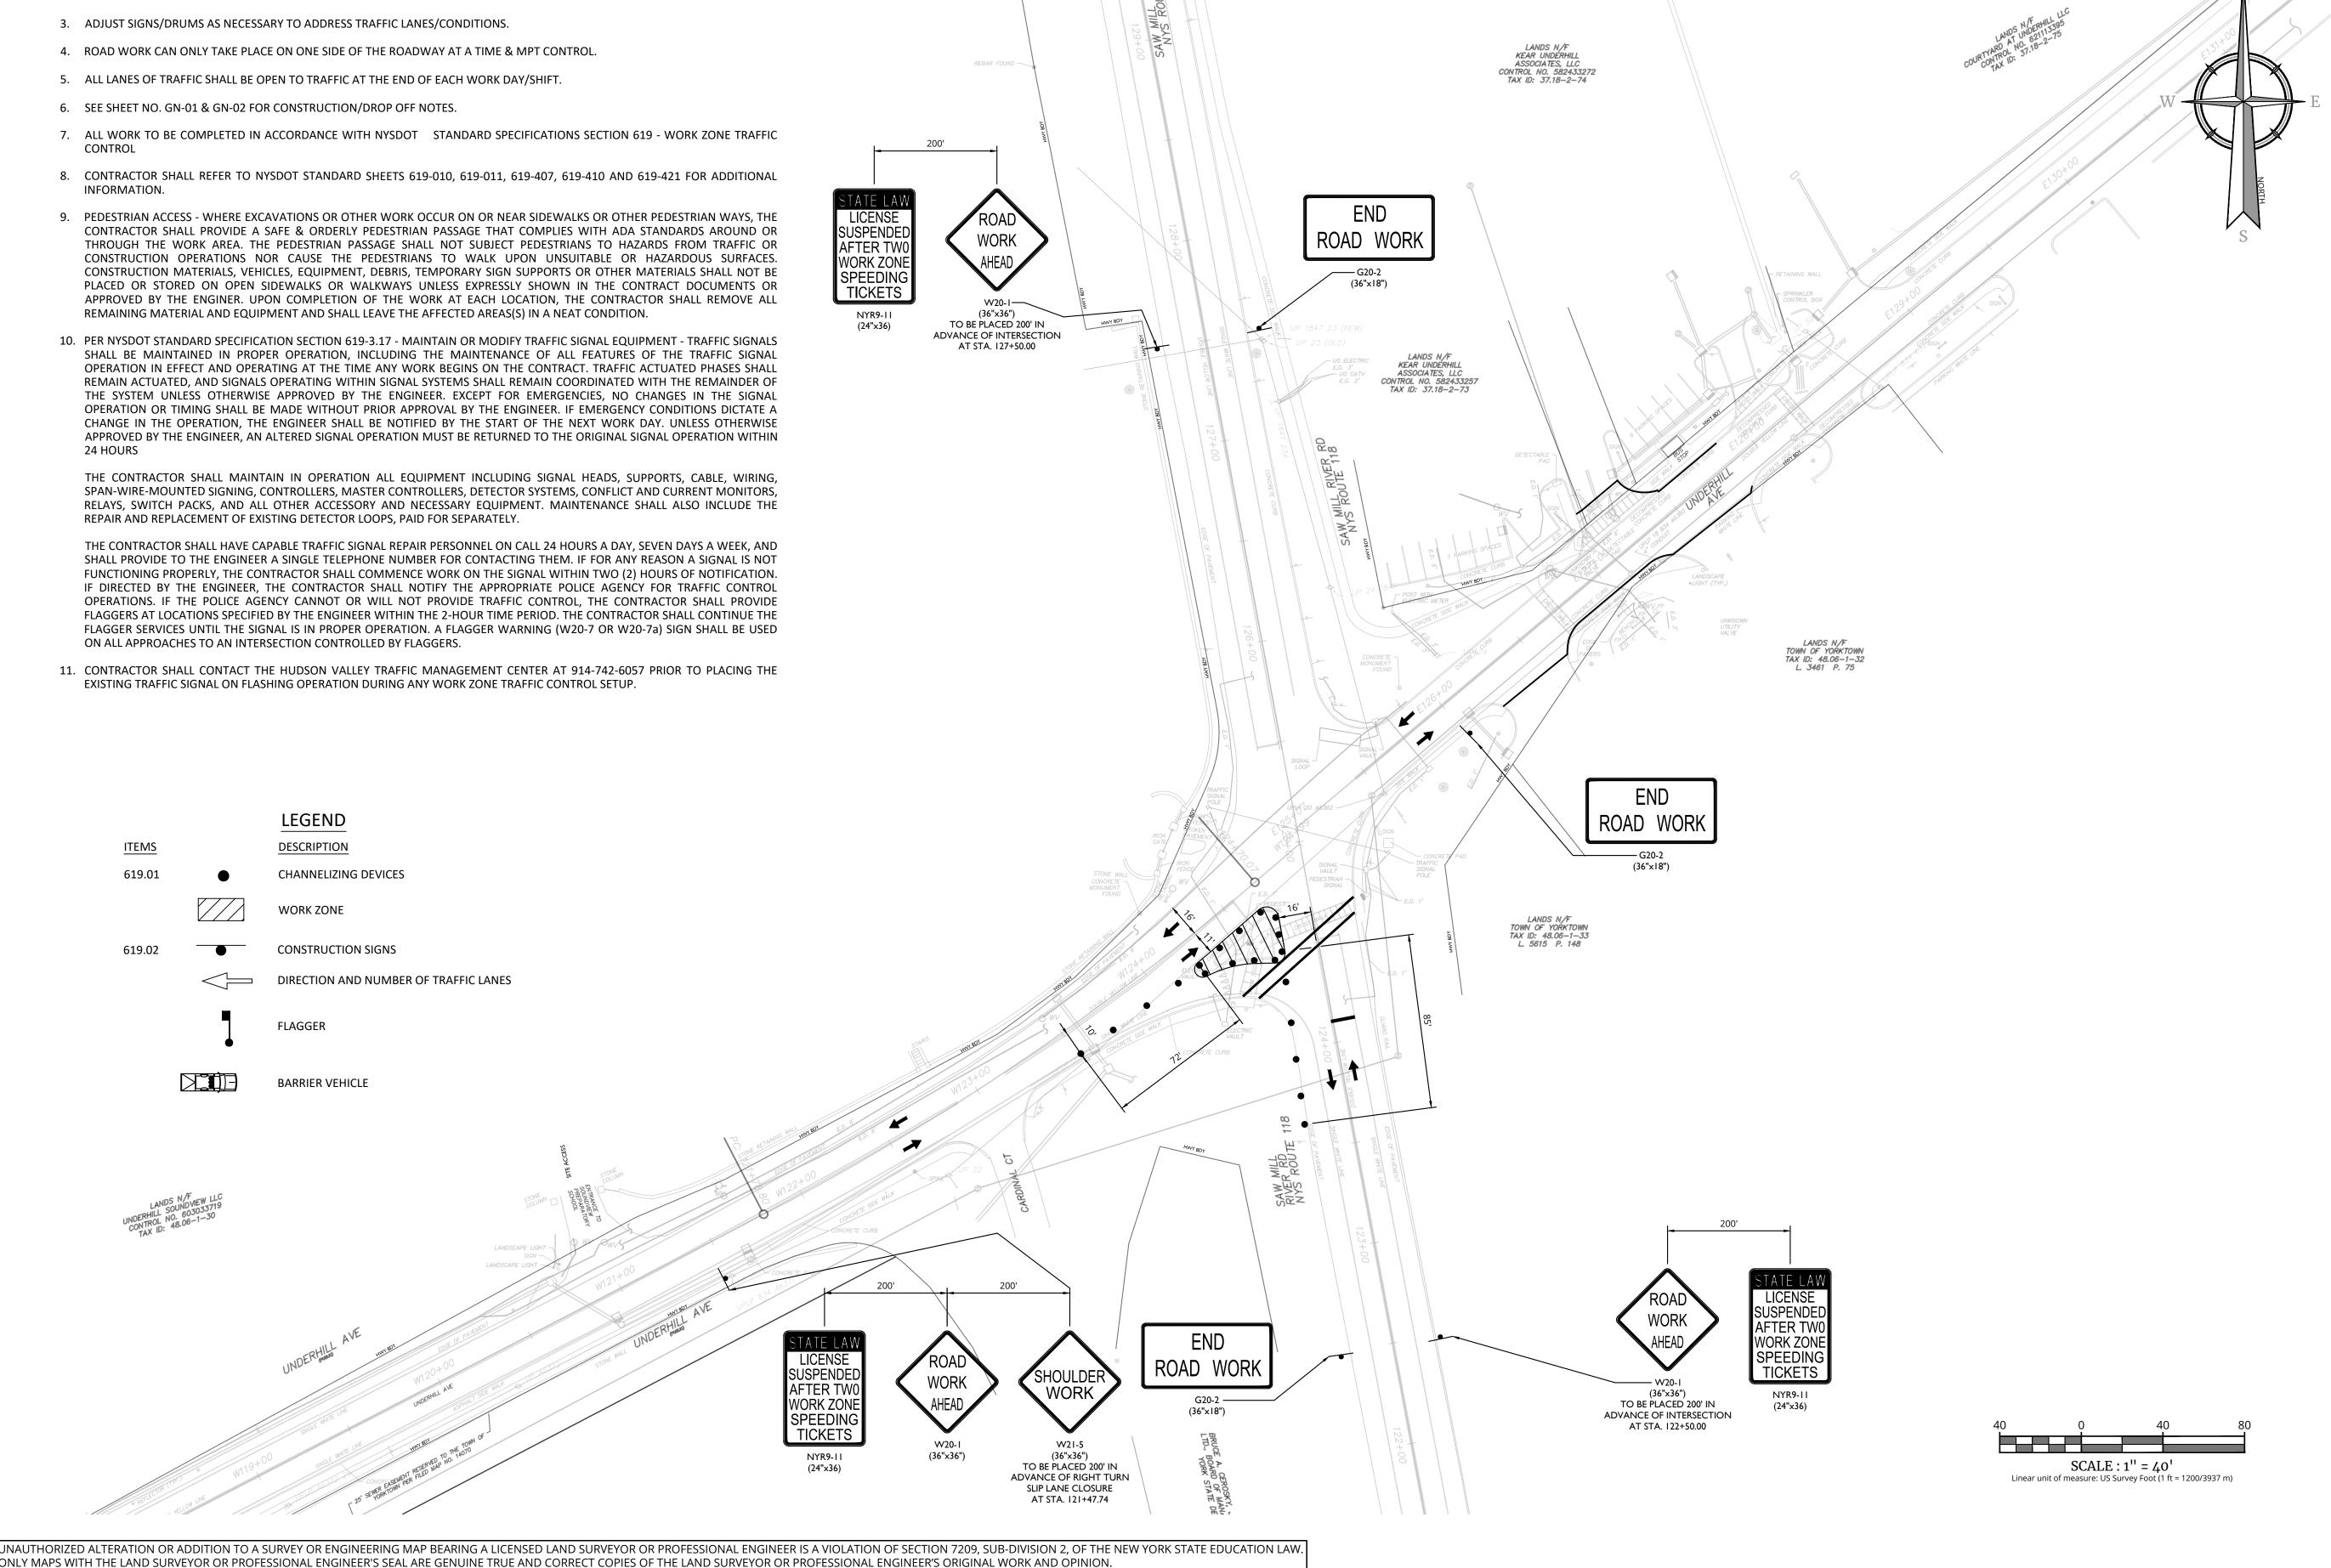

Colliers

Engineering & Design

www.colliersengineering.com


Copyright © 2024. Colliers Engineering & Design All Rights Reserved. This drawin ind all the information contained herein is authorized for use only by the party whom the services were contracted or to whom it is certified. This drawing may r e copied, reused, disclosed, distributed or relied upon for any other purpo without the express written consent of Colliers Engineering & Design



PROTECT YOURSELF LL STATES REQUIRE NOTIFICATION O EXCAVATORS, DESIGNERS, OR ANY PERSO PREPARING TO DISTURB THE EARTH'S SURFACE ANYWHERE IN ANY STATE

FOR STATE SPECIFIC DIRECT PHONE NUMBERS VISIT: WWW.CALL811.COM

REV	DATE	DRAWN BY	DRAWN BY DESCRIPTION
1	4/3/24	M.J.A.	REVISED PER NYSDOT COMMENTS RECEIVED 3/19/24
2	4/26/24	J.F.M.	REVISED PER NYSDOT 4/25/24 COMMENTS.
3	5/14/24	M.J.A.	REVISED PER NYSDOT 5/2/24 COMMENTS.
4	5/24/24	M.J.A.	REVISED TRAFFIC SIGNAL PLAN SHEETS PER NYSDOT SIGNAL GROUP 5/23/24 EMAIL COMMENTS.
5	7/1/24	M.J.A.	REVISED PER NYSDOT 7/1/24 COMMENTS.
9	8/7/24	M.J.A.	REVISED PER NYSDOT 7/31/24 COMMENTS.
7	8/15/24	RGD	revised per qa/qc review
8	9/12/24	M.J.A.	REVISED PER NYSDOT 8/30/24 COMMENTS.
6	9/23/24	M.J.A.	REVISED PER NYSDOT 9/20/24 COMMENTS. FINAL SET FOR PERMITTING.
·		•	

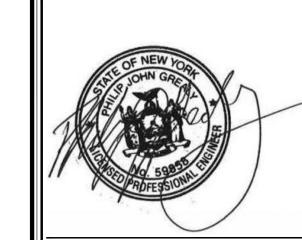

Philip John Grealy NEW YORK LICENSED PROFESSIONAL ENGINEER LICENSE NUMBER: 059858-1 COLLIERS ENGINEERING & DESIGN CT, P.C. N.Y. C.O.A #: 0017609

HIGHWAY IMPROVEMENT PLANS

FOR UNDERHILL AVENUE **IMPROVEMENTS**

(SEQR # 22-092)

NYS ROUTE 118 (S.H. 148) AT UNDERHILL AVENUE

TOWN OF YORKTOWN WESTCHESTER COUNTY **NEW YORK**

Colliers Engineering

AS SHOWN

400 Columbus Avenue, Suite 180E Valhalla, NY 10595 Phone: 914.347.7500


WESTCHESTER


& Design 1/8/23


R-PL11-WZTC 20006297A WZTC PHASE I PEDESTRIAN REFUGE


ISLAND REMOVAL


WZTC-01

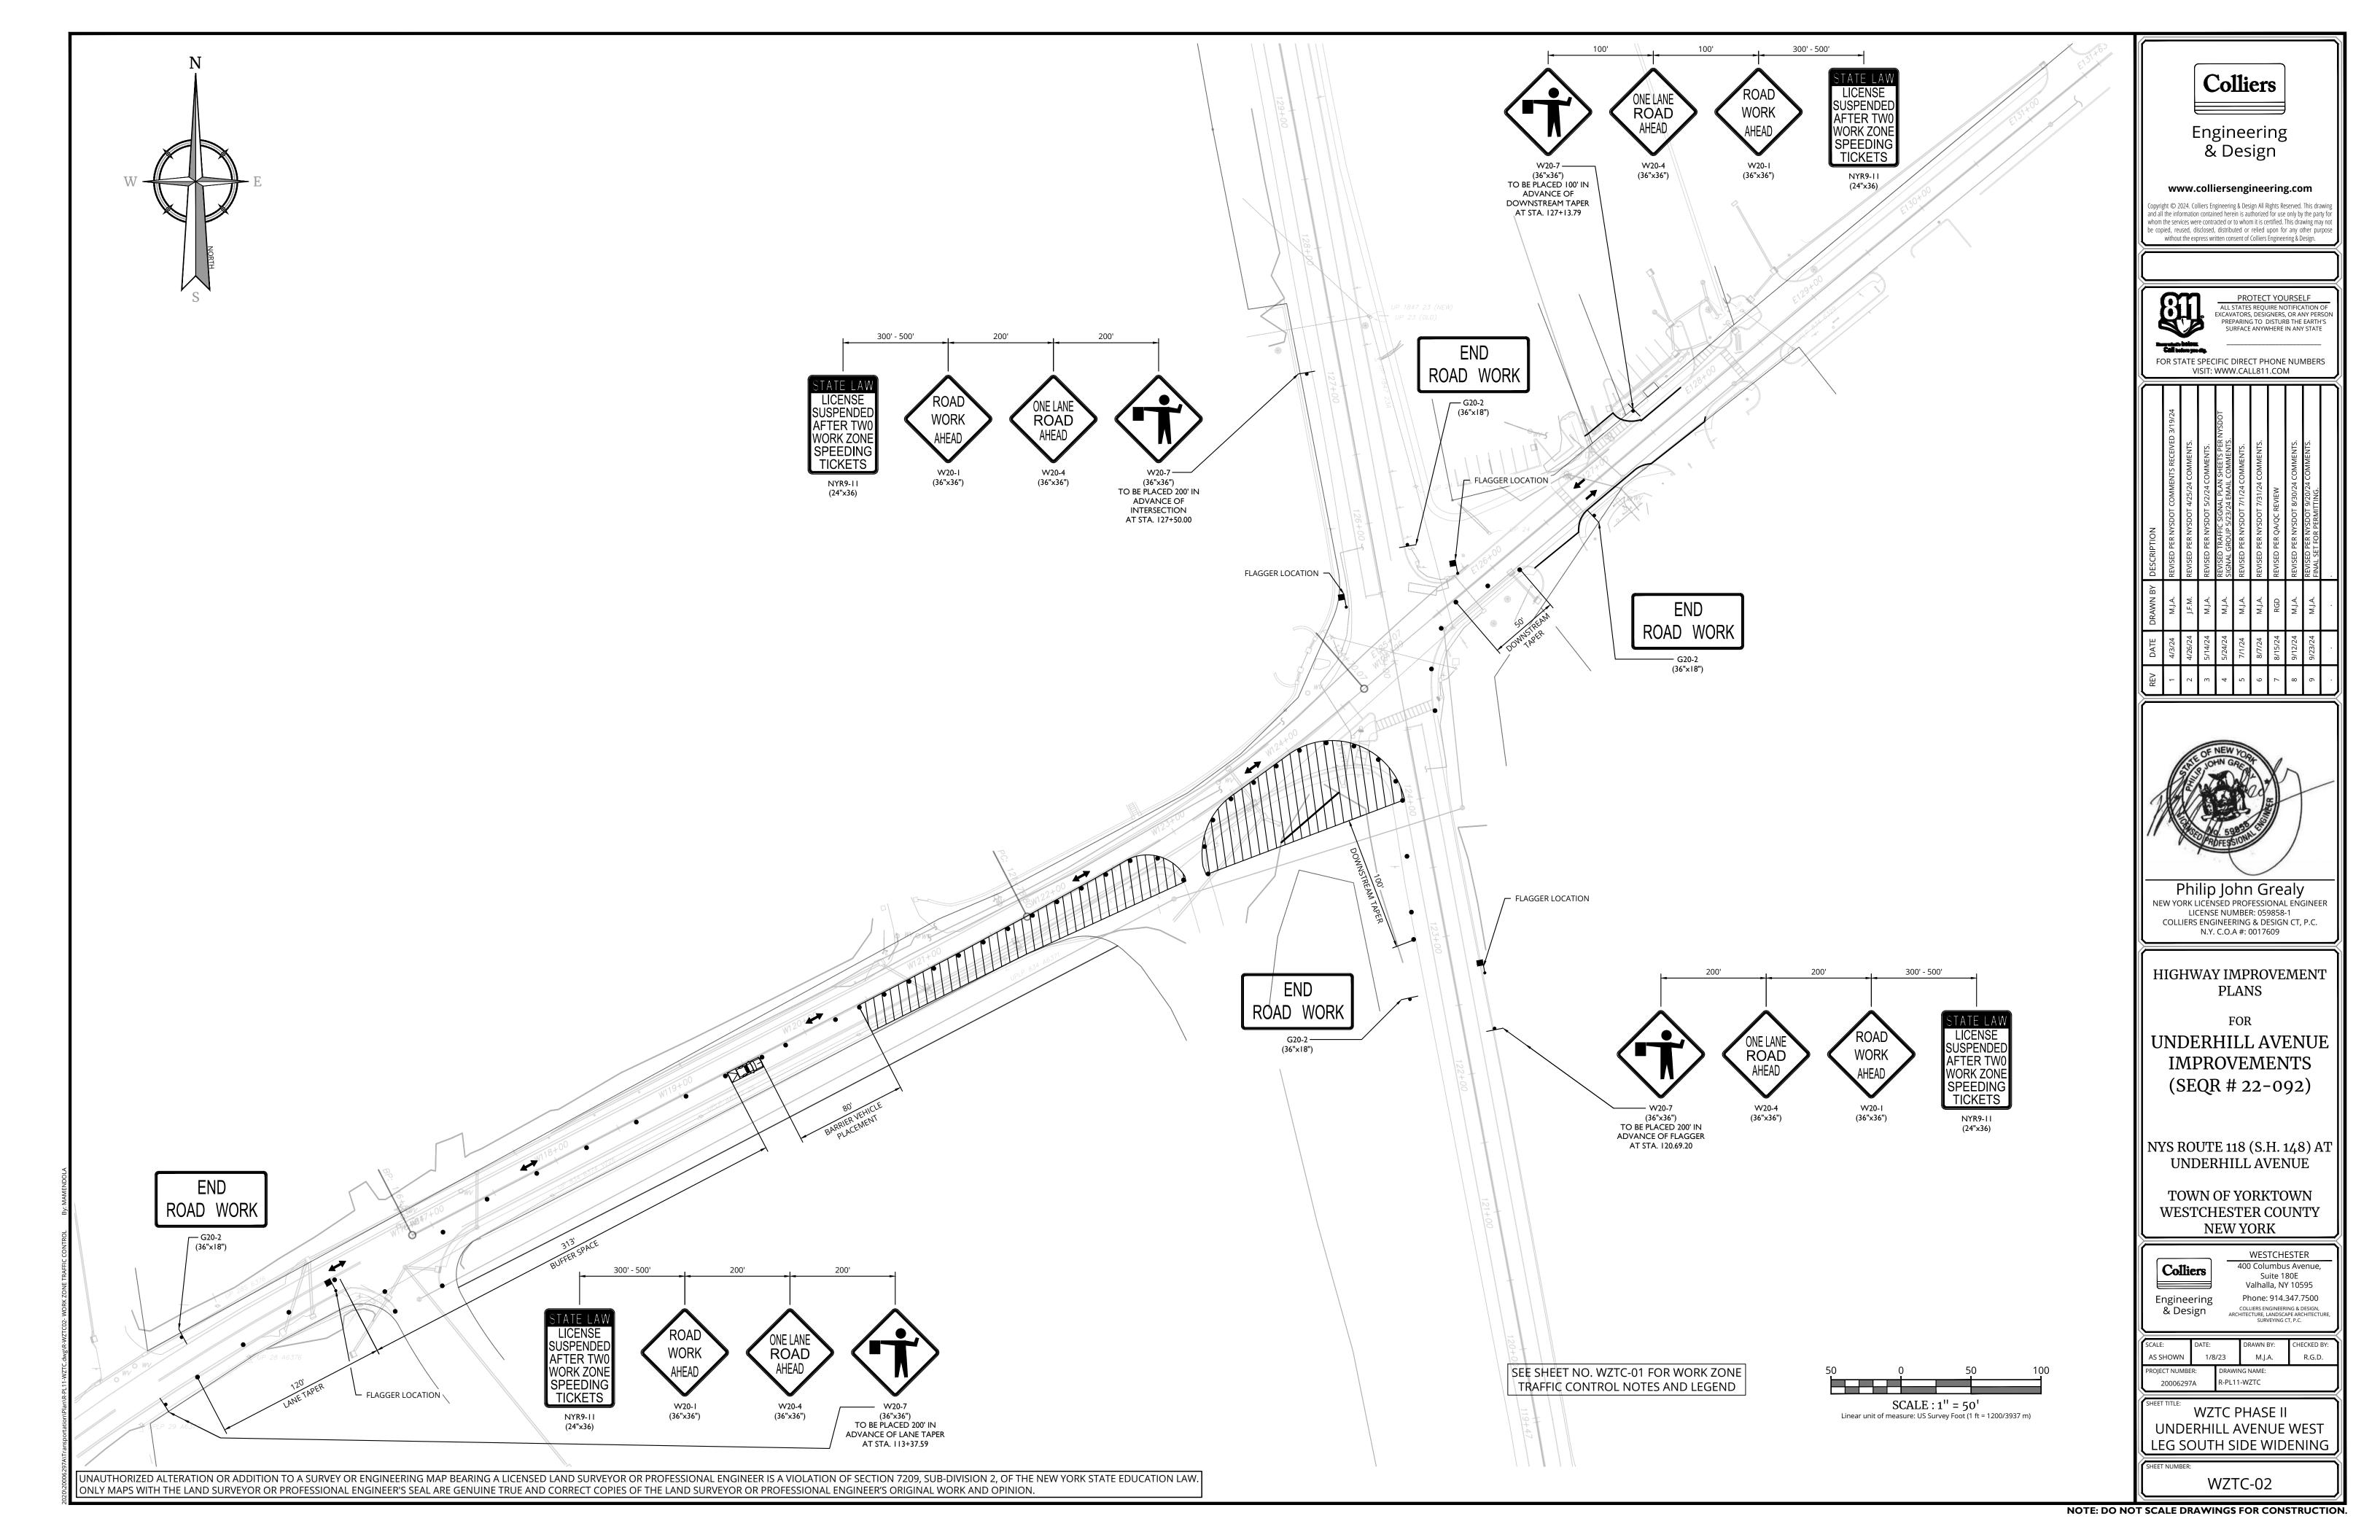

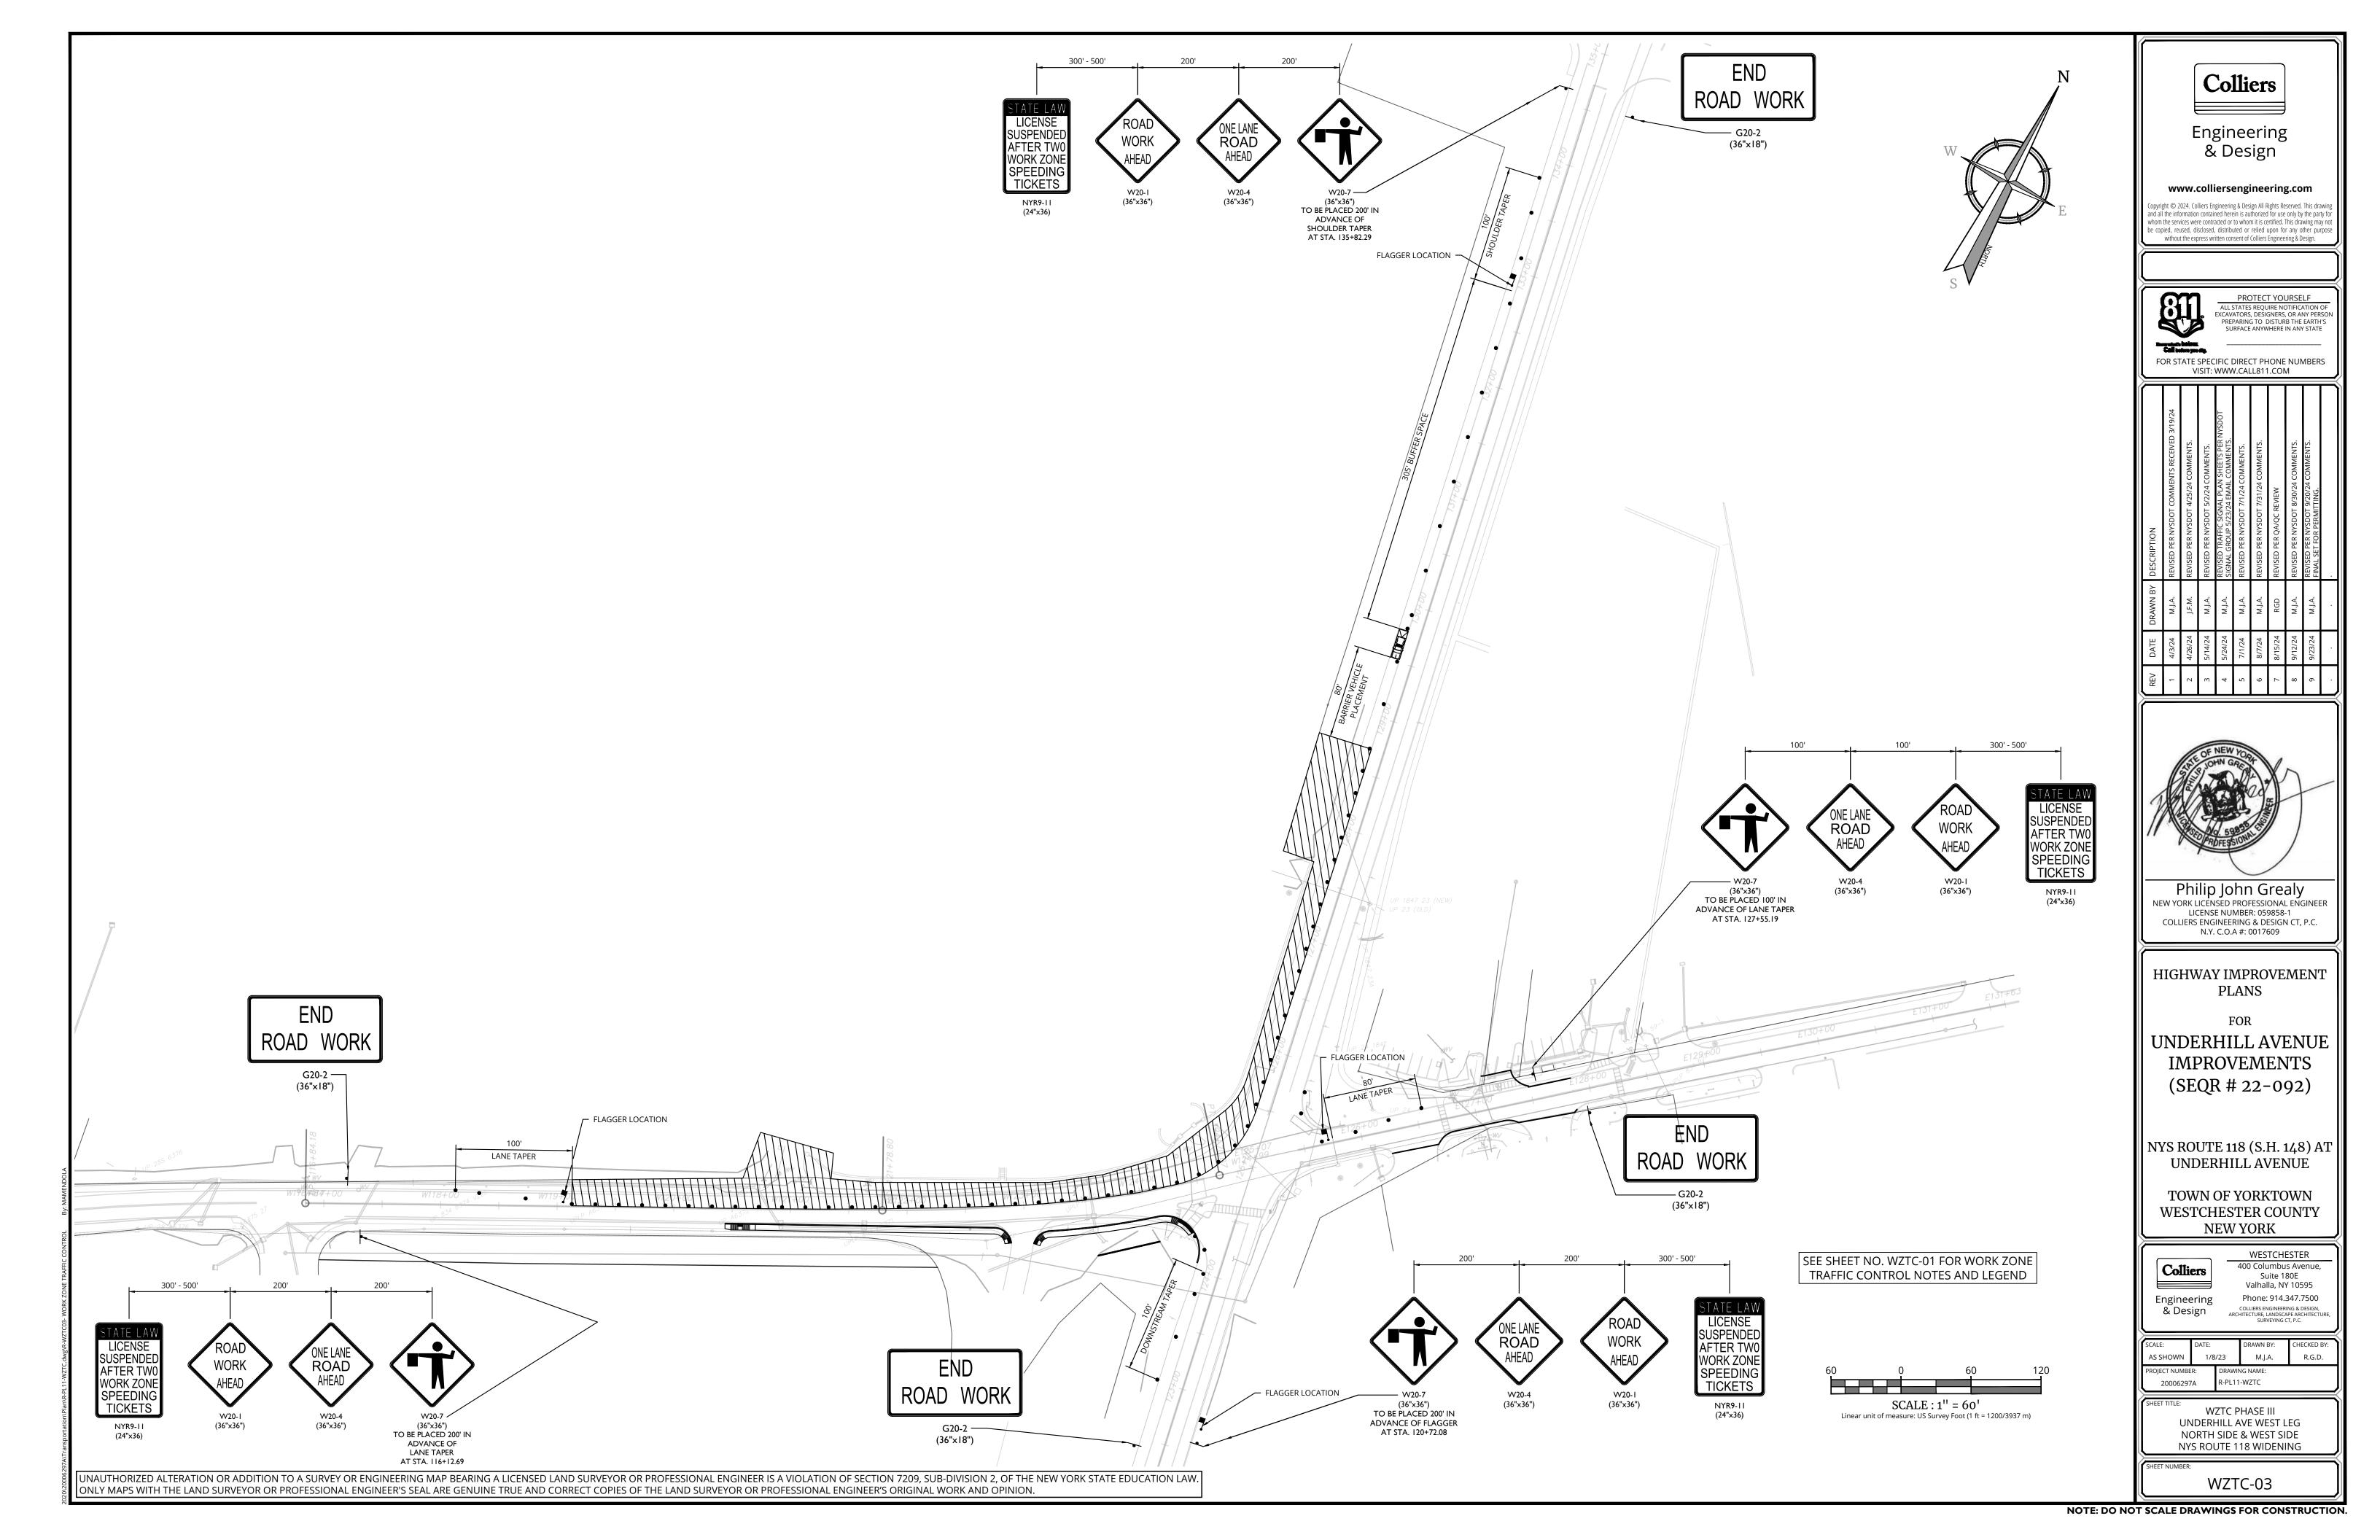

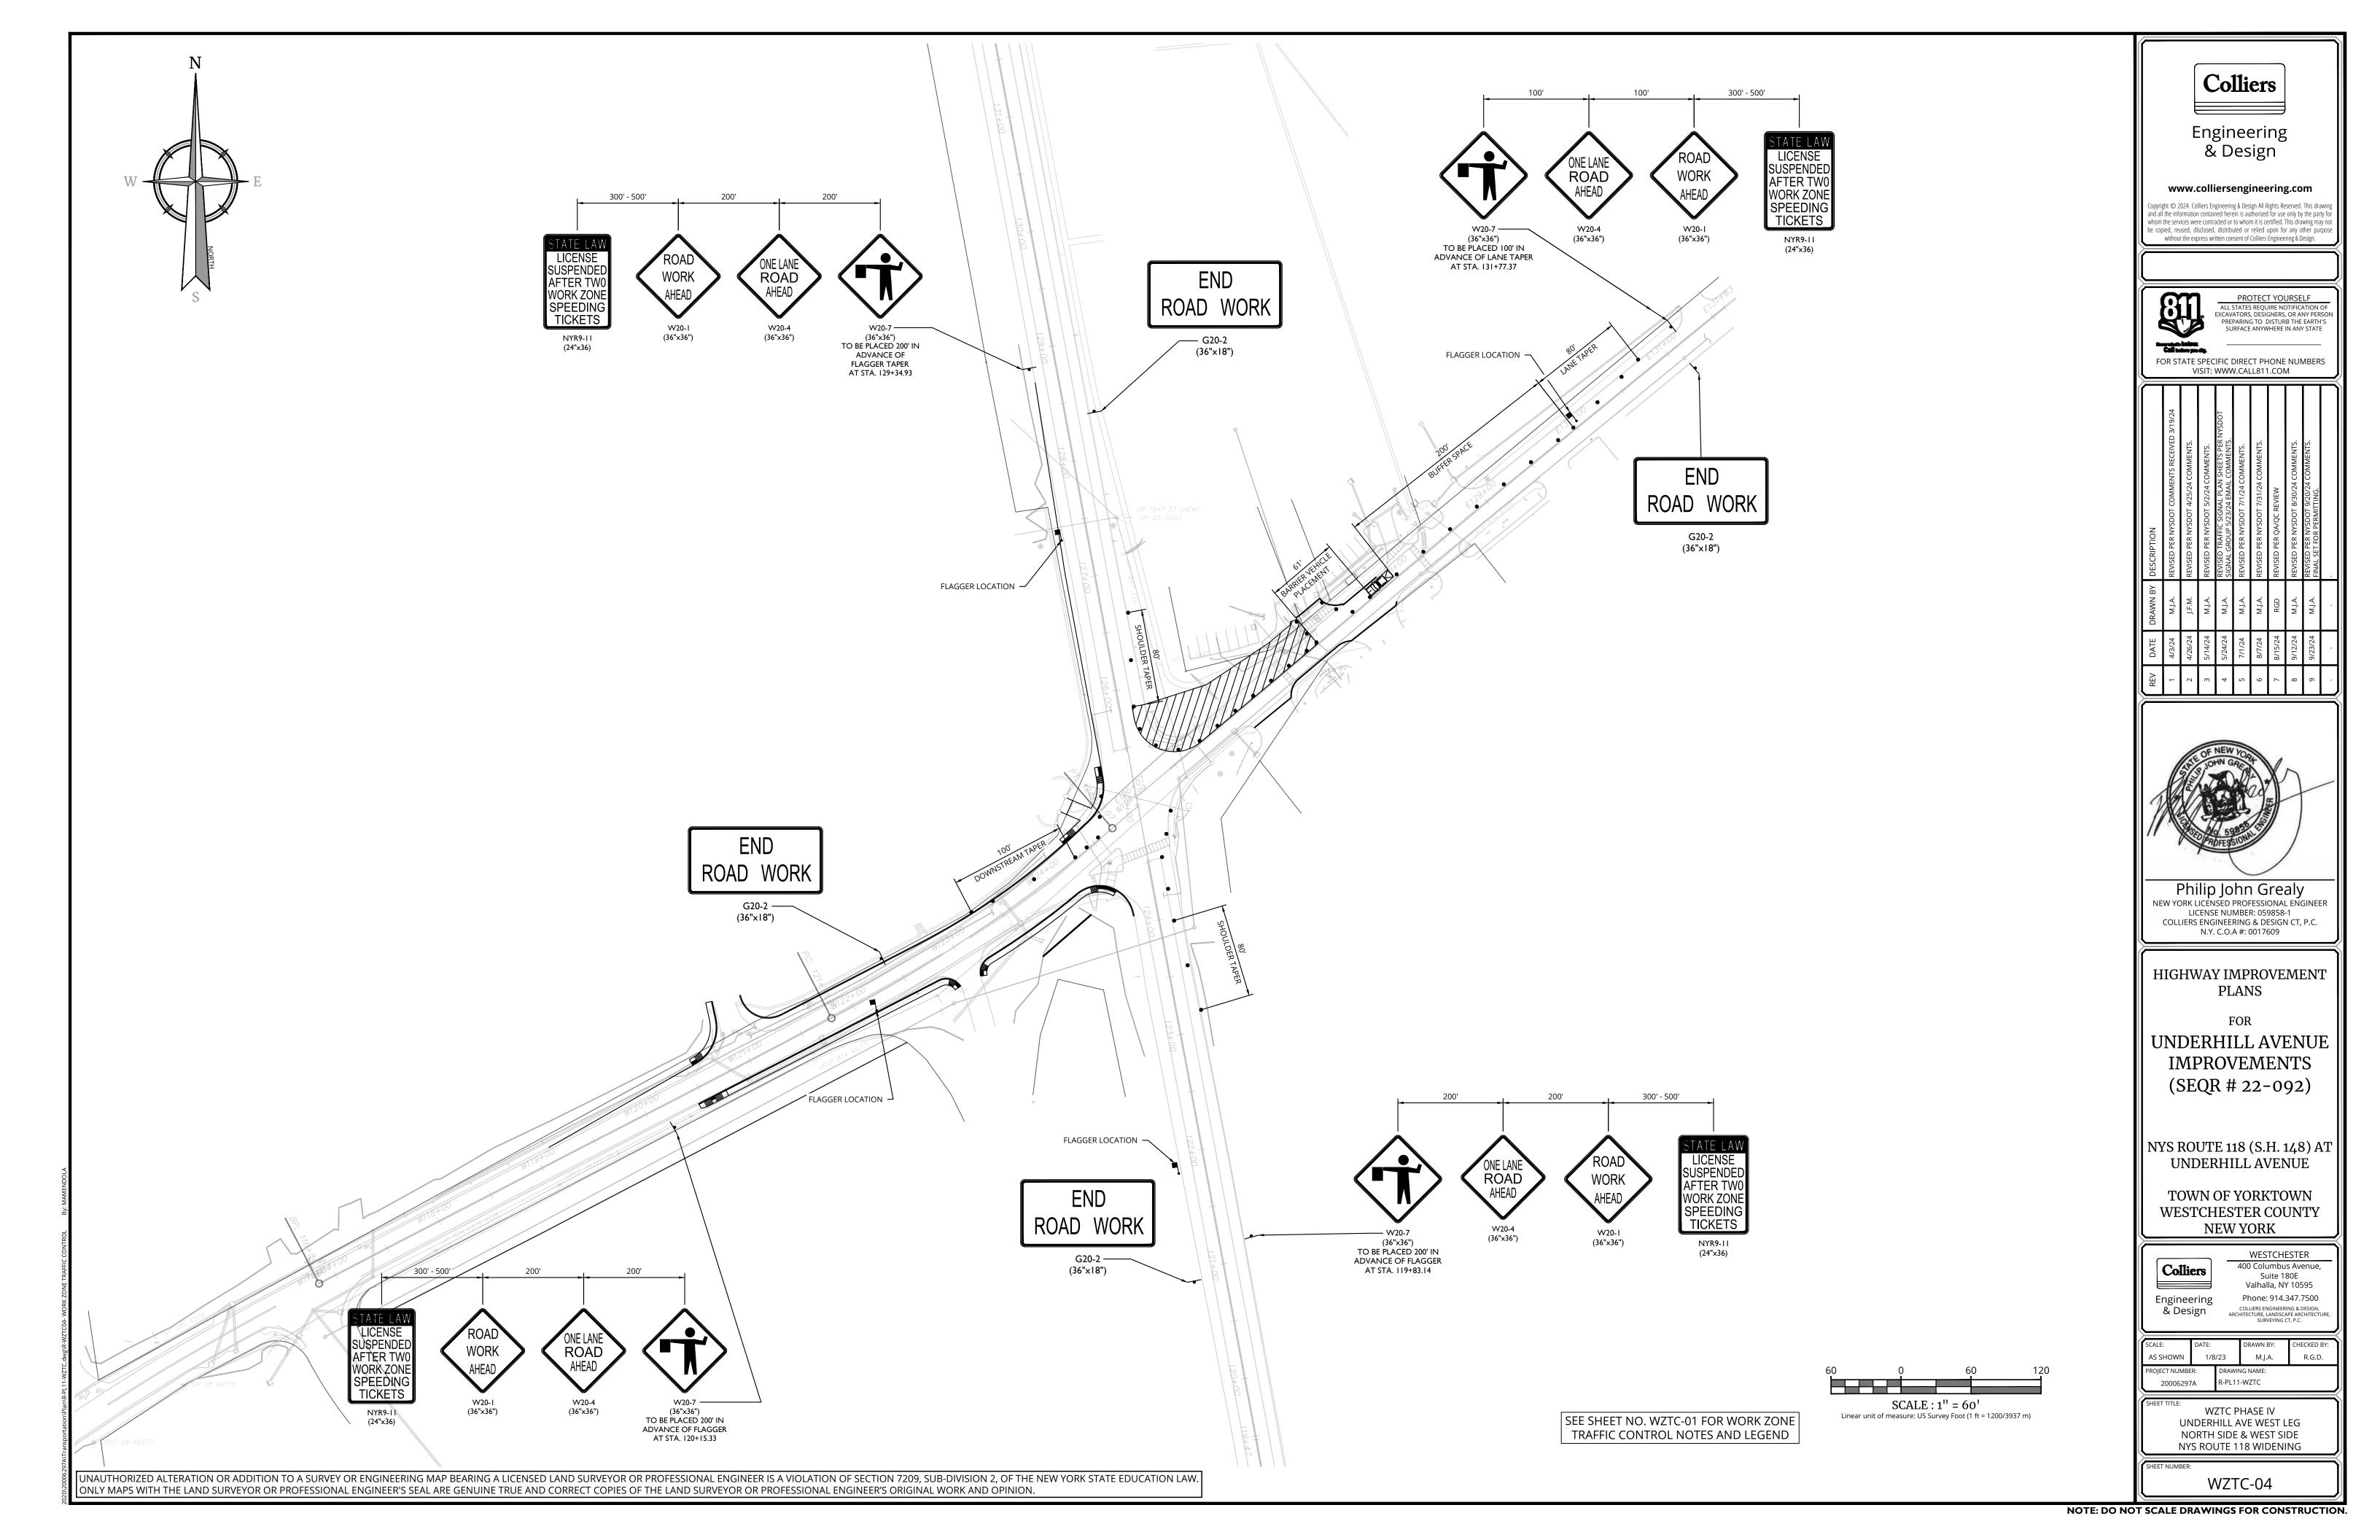

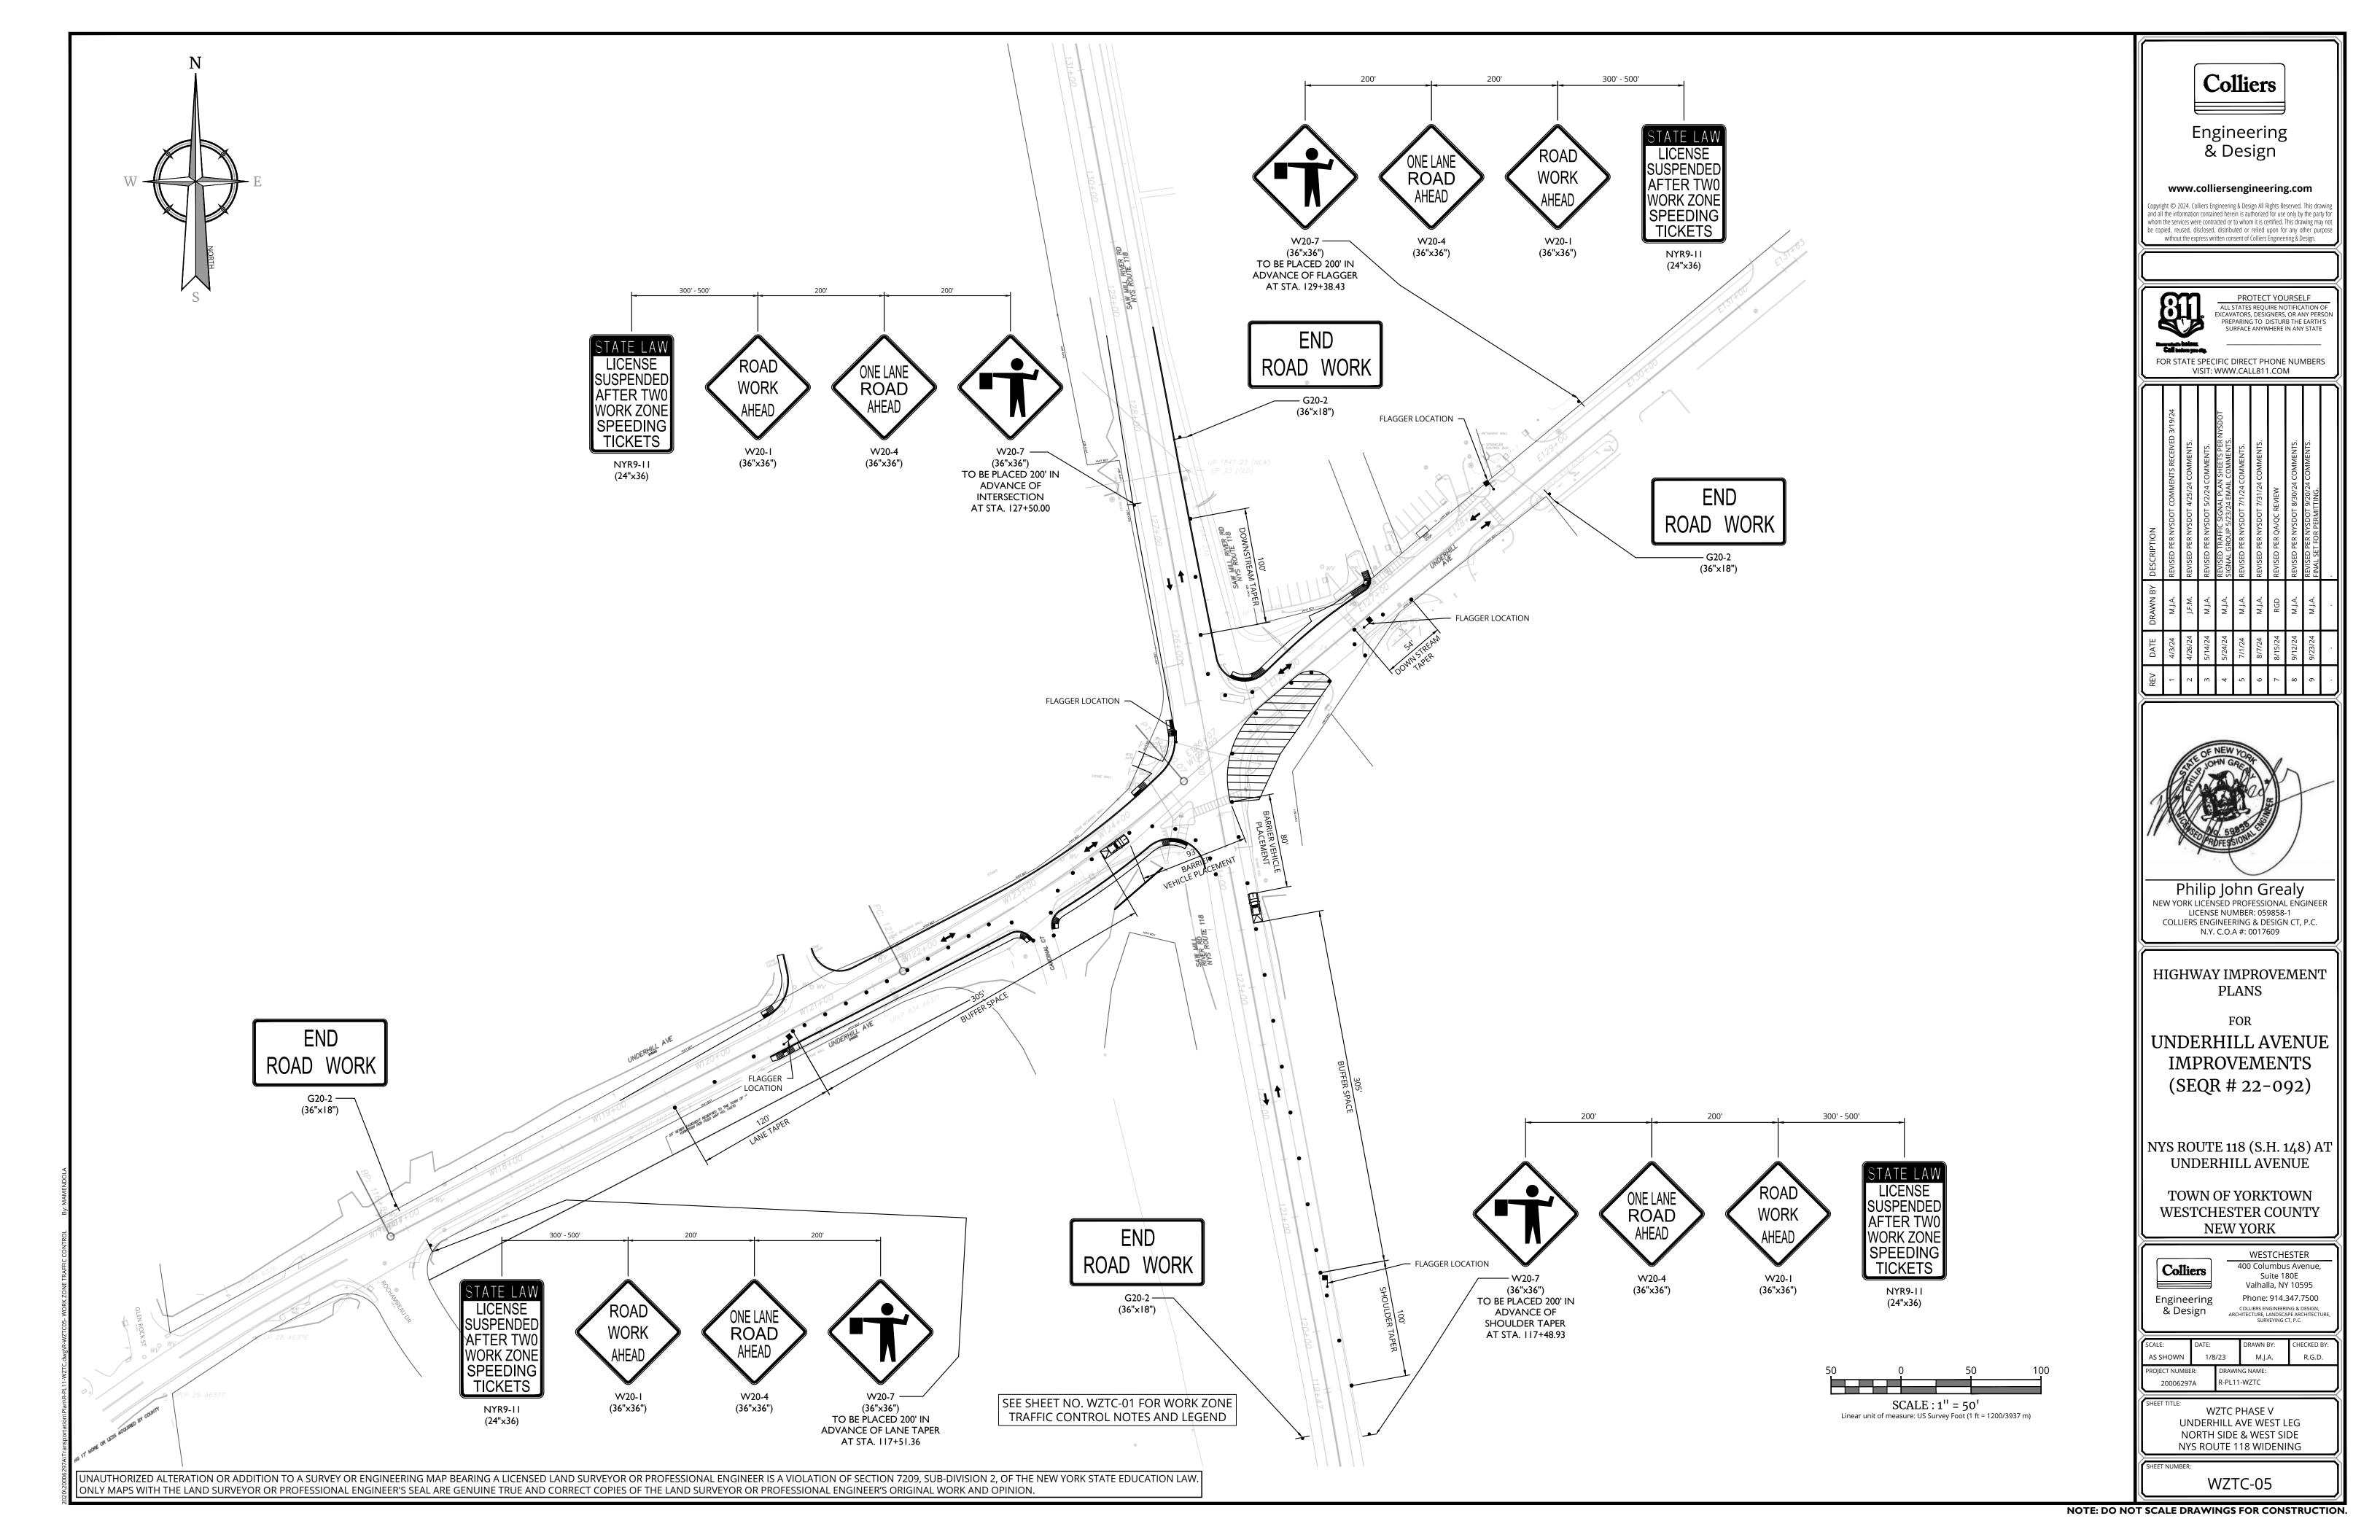

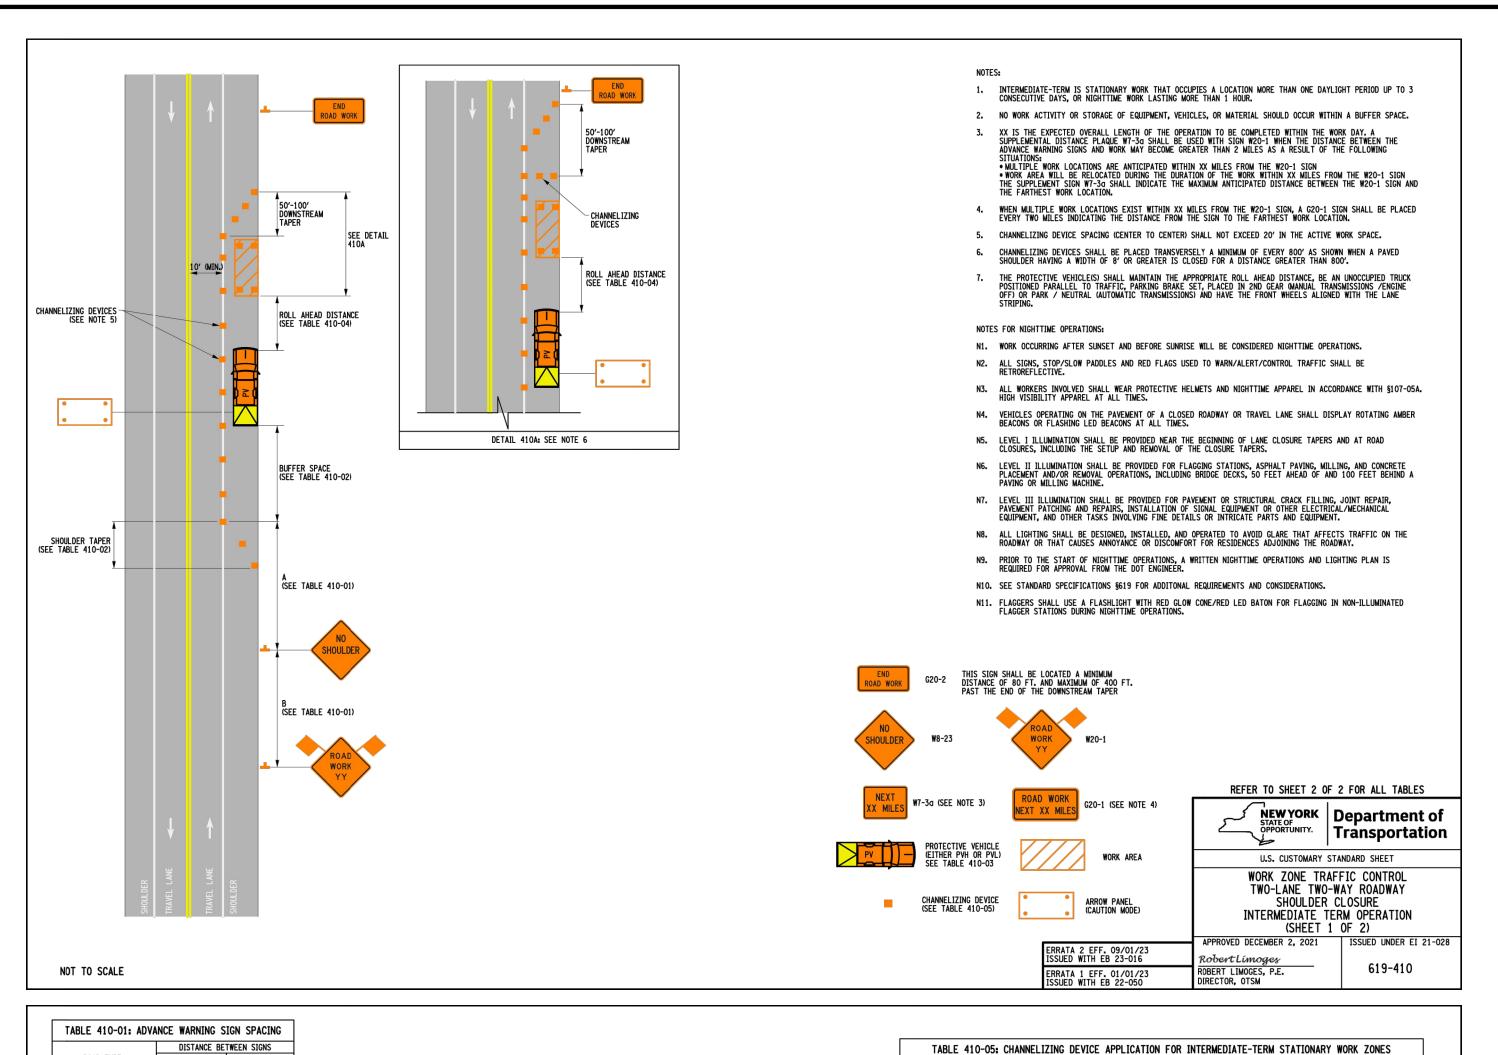

	DISTANC	E DEIMEEN 31	GNO											
ROAD TYPE	A (FT.) В	(FT.)											
URBAN (≤ 30 MPH+)	100		100											
URBAN (35-40 MPH			200											
URBAN (≥45 MPH+)			350											
RURAL	500		500											
PRECONSTRUCTION	POSTED SPEED LIMIT													
			TABLE	410-02: LONG	GITUDINAL B	UFFER	R SPACE AND	TAPE	R LENGT	THS				
PRECONSTRUCTION POSTED SPEED	LONGITUDINAL BUFFER SPACE		NGTH: (FT.)/ ¹ F CHANNELIZI	* OF SKIP LINES, NG DEVICES	/	SHOULDER TAPER LENGTH: (FT.J/ * OF SKIP LINES/ * OF CHANNELIZING DEVICES								
LIMIT (MPH)	DISTANCE (FT.)/ * OF SKIP LINES		OR LANE WIDT SHIFT OF TR	TH IN FT.	н)				FO	R SHOULDER WID	тн			
		10	11	12	≤ 4 1	FT.	5 - 7 FT.	8	FT.	9 FT.	10 FT	. 11 FT.	12 FT	
25	155/4	120/3/4	120/3/	4 120/3/	4 40/1	/2	40/1/2	40)/1/2	40/1/2	40/1/	2 40/1/2	40/1/2	
30	200/5	160/4/5	160/4/	′5 200/5/	6 40/1	/2	40/1/2	40	0/1/2	40/1/2	80/2/	3 80/2/3	80/2/3	
35	250/6	200/5/6	240/6/	7 240/6/	7 40/1	/2	40/1/2	80)/2/3	80/2/3	80/2/	3 80/2/3	80/2/	
40	305/8	280/7/8	320/8/	9 320/8/	9 40/1	/2	80/2/3	80)/2/3	80/2/3	120/3/	′4 120/3/4	120/3/	
45	360/9	440/11/12	520/13/	14 560/14/	15 80/2	2/3	80/2/3	12	0/3/4	120/3/4	120/3/	[′] 4 120/3/4	160/4/	
50	425/11	520/13/14	560/14/	15 600/15/	16 80/2	2/3	120/3/4	16	0/4/5	160/4/5	160/4/	^{'5} 160/4/5	160/4/	
55	495/13	560/14/15	600/15/	16 680/17/	18 80/2	2/3	120/3/4	16	0/4/5	160/4/5	160/4/	/5 200/5/6	200/5/	
TA	ABLE 410-03: PRO	TECTIVE VE	HICLE REQ				TABLE					R PROTECTIVE VE	HICLES	
CLOSURE TYPE	ROAD TYPE &	SPEED	≥ 45 MPH	NON-FREEWAY	≤ 30 MPH	1	ROLL AHEAD DISTANCE (FT.)/* OF SKIP LINES FOR VEHICLES							
CLUSURE TIPE	EXPOSURE COND (SEE NOTE		2 10 1111		2 00 1111		PRECONSTRUC POSTED SPEED		STATIONARY PROTECTIVE VEHICLES WEIGHING			PROTECTIVE VEHICLES WEIGHING		
	WORKERS ON FOO WORK VEHICLE E		PVH+TMIA	PVL+TMIA	SEE NOTE 2		(MPH) 45 - 59	5		160/4		22,000 LBS. OR GF	REATER GVW	
	TO TRAFFIC					1		,						
LANE CLOSURE OR ENCROACHMENT	-NO WORKERS ON -NO WORK VEHIC EXPOSED TO TRA -OTHER HAZARDS (IE EQUIPMENT,)	LE FFIC EXPOSED	PVH+TMIA	SEE NOTE 2	SEE NOTE 2		≤ 40			120/3		80/2		
_	WODKEDS ON EOG			CEE	CEE.	1								

WORKERS ON FOOT OR
WORK VEHICLE EXPOSED
TO TRAFFIC

PVH+TMIA

SEE
NOTE 2

NOTE 2

-NO WORKERS ON FOOT
-NO WORK VEHICLE
EXPOSED TO TRAFFIC
-OTHER HAZARDS EXPOSED
(IE EQUIPMENT, MATERIALS,
EXCAVATION)

SEE
SEE
NOTE 3
NOTE 2
NOTE 2

LEGEND
PVL - PROTECTIVE VEHICLE LIGHT (MINIMUM GROSS WEIGHT 9,500 LBS. OR GREATER) (SEE NOTE 5)
PVH - PROTECTIVE VEHICLE HEAVY (MINIMUM GROSS WEIGHT 22,000 LBS. OR GREATER)
TMIA - TRUCK/TRAILER MOUNTED IMPACT ATTENUATOR

2. EITHER A PROTECTIVE LIGHT (PVL) OR THE STANDARD BUFFER SPACE (SEE TABLE 011-03 SHALL BE PROVIDED.

. EITHER A PROTECTIVE LIGHT (PVL) OR THE STANDARD BUFFER SPACE (SEE TABLE 011-03 SHALL BE PROVIDED.

TRUCK/TRAILER MOUNTED IMPACT ATTENUATORS (TMIA) SHALL NOT BE MOUNTED/INSTALLED ON VEHICLES WITH A GROSS VEHICLE WEIGHT (GVW) LESS THAN WHAT IS MINIMALLY REQUIRED BY THE MANUFACTURER OF THE TMIA.

THE USE OF A PROTECTIVE VEHICLE LIGHT (PVL) AS A SHADOW VEHICLE IS LIMITED TO NON-FREEWAY ROADWAYS WHERE THE POSTED SPEED LIMITS IS \leq 40 MPH UNLESS OTHERWISE AUTHORIZED BY THE ENGINEER.

NOTES

1. THE EXPOSURE CONDITIONS ASSUME THERE IS NO POSITIVE PROTECTION PRESENT.

_		-					TON MONE THAN I HOUR		1		1	l		1			1 ' 1
		ER TAPER LEN					SHOULDER/MERGING/	20 FT. •	Х							Х	
	CHANI	NELIZING DEVIC	ES			_	SHIFTING TAPERS	40 FT.	Х							X	
		SHOULDER WID					MARKING FOR TRANSVERSE BUMPS ¹	N/A	x ²	x		x ²				x ²	
_)/1/2	9 FT. 40/1/2	10 FT. 40/1/2	11 FT. 40/1/2	12 FT. 40/1/2	_	TRANSVERSE DEVICE WITHIN	800 FT.	\ \ \			,			V	v	
_	0/1/2	40/1/2	80/2/3	80/2/3	80/2/3	\dashv	CLOSED TRAFFIC LANE AND/OR SHOULDER	800 F1.	X		X	X			X	Х	0
_	0/2/3	80/2/3	80/2/3	80/2/3	80/2/3	-	REMOVAL OF EXISTING	80 FT.	x		х	х	х		х	Х	0
8(0/2/3	80/2/3	120/3/4	120/3/4	120/3/4		GUIDE RAIL	40 FT.	^			_ ^	^		^	^	
12	0/3/4	120/3/4	120/3/4	120/3/4	160/4/5		NOTES: X= ALLOWED, BLANK = 1 A TYPE 1 OBJECT MARKE				INFI TZTNG	DEVICE		• SEE N	IOTE 5 ON	SHEET 1 OF	2.
16	0/4/5	160/4/5	160/4/5	160/4/5	160/4/5		2 CHANNELIZING DEVICES S						г.				
16	0/4/5	160/4/5	160/4/5	200/5/6	200/5/6												
-0)4: ROLL	AHFAD DISTA	ANCE FOR	PROTECTIVE VE	HICLES							TABL	E 410-06:	REQUIRE	D SIGN S	IZES*	
-				S FOR VEHICLES							SIGN		NON-FREE	WAY		FREEWAY	'
_	AILEAD DIS		TATIONARY O								G20-2		36×18	ı		48×24	
т	DDOTECTI	VE VEHICLES W		PROTECTIVE VEHICL	EC METCHING						W20-1		36x36			48×48	
		TO 21,999 LBS		22,000 LBS. OR G							W21-5		36x36			48×48	
		160/4		120/3							W7-3a	_	24×18			36×30	
		120/3		80/2						WAD	G20-1		36x18			48x24	
											RNING FLA FWAY SIZ		18x18 F USED ON		Y. IF SPAC	18x18 F CONSTRAIN	NTS DO NOT
												Γ		NEW	YORK FUNITY.	Depa	ertment (
														1		1	sportation
												⊢	:			STANDARD :	
														TWO-LA SH INTERME)	NE TWO OULDER DIATE SHEET	-WAY RO CLOSUR ERM OPI 2 OF 2)	DADWAY RE ERATION
														APRIL 8,	2022	ISSUE	D UNDER EI 22
								ERR	RATA 1 E	FF. 09/01/ I EB 23-01	/23 6	T R	R <i>obert Li</i> OBERT LIMO IRECTOR, O	OGES. P.E.		-	619-410

Colliers

Engineering & Design

www.colliersengineering.com


ind all the information contained herein is authorized for use only by the party be copied, reused, disclosed, distributed or relied upon for any other purp



ALL STATES REQUIRE NOTIFICATION OF EXCAVATORS, DESIGNERS, OR ANY PERSON PREPARING TO DISTURB THE EARTH'S SURFACE ANYWHERE IN ANY STATE

FOR STATE SPECIFIC DIRECT PHONE NUMBERS VISIT: WWW.CALL811.COM

N BY DESCRIPTION	REVISED PER NYSDOT COMMENTS RECEIVED 3/19/24	1. REVISED PER NYSDOT 4/25/24 COMMENTS.	REVISED PER NYSDOT 5/2/24 COMMENTS.	REVISED TRAFFIC SIGNAL PLAN SHEETS PER NYSDOT SIGNAL GROUP 5/23/24 EMAIL COMMENTS.	A. REVISED PER NYSDOT 7/1/24 COMMENTS.	A. REVISED PER NYSDOT 7/31/24 COMMENTS.	REVISED PER QA/QC REVIEW	REVISED PER NYSDOT 8/30/24 COMMENTS.	REVISED PER NYSDOT 9/20/24 COMMENTS. I FINAL SET FOR PERMITTING.	
DRAWN BY	M.J.A.	J.F.M.	M.J.A.	M.J.A.	M.J.A.	M.J.A.	RGD	.A.J.A.	M.J.A.	
DATE	4/3/24	4/26/24	5/14/24	5/24/24	7/1/24	8/7/24	8/15/24	9/12/24	9/23/24	
REV	1	2	3	4	5	9	7	8	6	

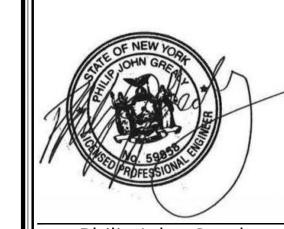

Philip John Grealy NEW YORK LICENSED PROFESSIONAL ENGINEER LICENSE NUMBER: 059858-1 COLLIERS ENGINEERING & DESIGN CT, P.C. N.Y. C.O.A #: 0017609

HIGHWAY IMPROVEMENT **PLANS**

FOR

UNDERHILL AVENUE **IMPROVEMENTS** (SEQR # 22-092)

NYS ROUTE 118 (S.H. 148) AT UNDERHILL AVENUE

TOWN OF YORKTOWN WESTCHESTER COUNTY NEW YORK

Colliers

WESTCHESTER 400 Columbus Avenue, Suite 180E Valhalla, NY 10595

Phone: 914.347.7500 Engineering COLLIERS ENGINEERING & DESIGN, ARCHITECTURE, LANDSCAPE ARCHITECTUR SURVEYING CT, P.C. & Design

1/8/23 M.J.A. AS SHOWN R-PL11-WZTC 20006297A

> TWO-LANE TWO-WAY ROADWAY SHOULDER CLOSURE

WZTC-06

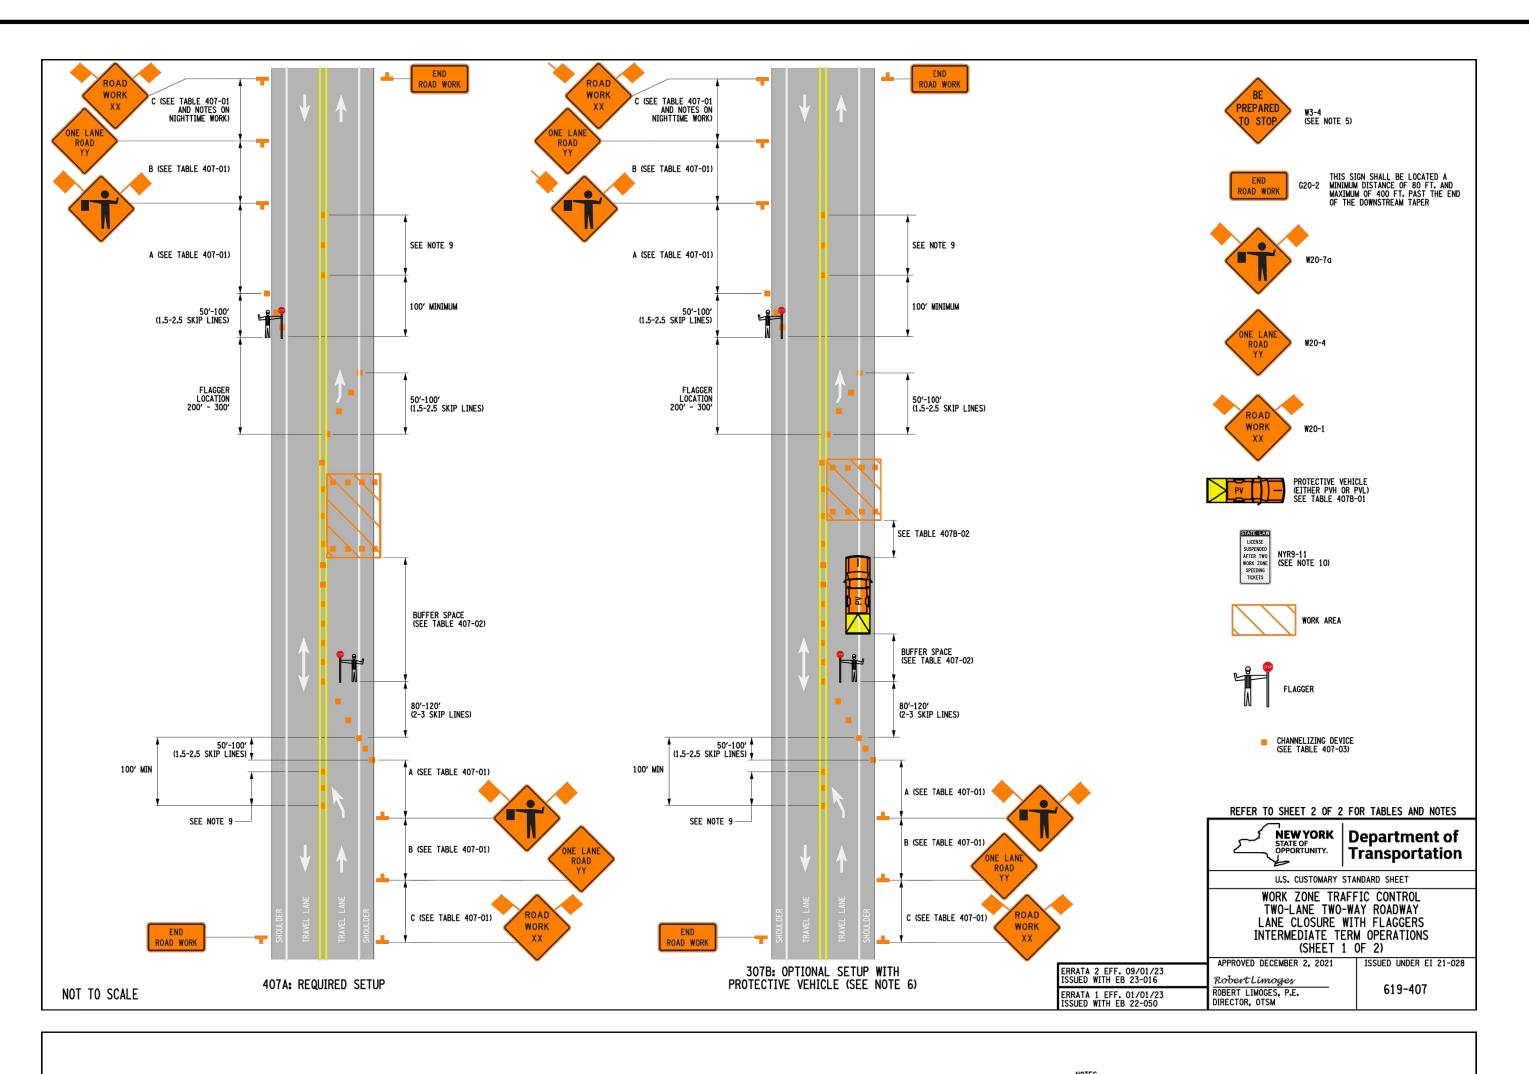


TABLE 407-01:	ADVANCE	WARNI	NG SIGN	SPACIN	IG
-	DISTANC	BETWEE	N SIGNS	SIGN	LEGEND
ROAD TYPE	A (FT.)	B (FT.)	C (FT.)	XX	YY
URBAN (≤ 30 MPH*)	100	100	100	AHEAD	AHEAD
URBAN (35-40 MPH+)	200	200	200	AHEAD	AHEAD
URBAN (≥45 MPH+)	350	350	350	1000 FT.	AHEAD
RURAL	500	500	500	1500 FT.	1000 FT
* PRECONSTRUCTION POSTED	SPEED L	IMIT			

TABLE 407-02: LONG	TUDINAL BUFFER SPACE
PRECONSTRUCTION POSTED SPEED LIMIT (MPH)	LONGITUDINAL BUFFER SPACE DISTANCE (FT.)/ * OF SKIP LINES
25	155/4
30	200/5
35	250/6
40	305/8
45	360/9
50	425/11
55	495/13

TABLE 407-03: CH/	MINICLIZING	DEATO	L AFFLICA	TION I	OK IN	CUMEDIATE	-ILINM 31	ATTONAN	I WORK Z	UNLS
WORK ZONE PROVISIONS	92				MUTCD C	OMPLIANT CH	ANNELIZING	DEVICE		
INTERMEDIATE-TERM STATIONARY WORK ZONES INVOLVE WORK THAT OCCUPIES A LOCATION FOR MORE THAN 1 DAYLIGHT FERIOD UP TO 3 CONSECUTIVE DAYS, OR NIGHTTIME WORK THAT OCCUPIES A LOCATION FOR MORE THAN 1 HOUR	MAXIMUM DEVICE SPACING (CENTER TO CENTER)	DRUMS	STANDARD CONES	TALL CONES	EXTRA TALL CONES	TEMPORARY TUBULAR MARKERS	INTERIM TUBULAR MARKERS	VERTICAL PANELS	OVERSIZED VERTICAL PANELS	TYPE III BARRICADES
SHOULDER/MERGING/	20 FT. *	Х							Х	
SHIFTING TAPERS	40 FT.	Х							Х	
MARKING FOR TRANSVERSE BUMPS ¹	N/A	x ²			x ²				x ²	
TRANSVERSE DEVICE WITHIN CLOSED TRAFFIC LANE AND/OR SHOULDER	800 FT.	х		х	х			х	х	0
REMOVAL OF EXISTING GUIDE RAIL	80 FT. 40 FT.	Х		х	х	Х		х	х	0

SIGN	NON-FREEWAY	FREEWAY
G20-2	36×18	48×24
W3-4	36x36	48×48
W20-1	36x36	48×48
W20-4	36x36	48×48
W20-7	36x36	48×48
WARNING FLAG	18x18	18×18

TA	BLE 407B-01: PROTECTIVE V	EHICLE REQ	UIREMENTS				
	ROAD TYPE & SPEED	NON-FREEWAY					
CLOSURE TYPE	RUAD TIPE & SPEED	≥ 45 MPH	35 - 40 MPH	≤ 30 MPH			
	EXPOSURE CONDITIONS (SEE NOTE 1)						
	WORKERS ON FOOT OR WORK VEHICLE EXPOSED TO TRAFFIC	PVH+TMIA	PVL+TMIA	SEE Note 2			
LANE CLOSURE OR ENCROACHMENT	-NO WORKERS ON FOOT -NO WORK VEHICLE EXPOSED TO TRAFFIC -OTHER HAZARDS EXPOSED (IE EQUIPMENT, MATERIALS)	PVH+TMIA	SEE NOTE 2	SEE NOTE 2			
SHOULDER CLOSURE	WORKERS ON FOOT OR WORK VEHICLE EXPOSED TO TRAFFIC	PVH+TMIA	SEE NOTE 2	SEE NOTE 2			
OR ENCROACHMENT	-NO WORKERS ON FOOT -NO WORK VEHICLE EXPOSED TO TRAFFIC -OTHER HAZARDS EXPOSED (IE EQUIPMENT, MATERIALS, EXCAVATION)	SEE NOTE 3	SEE NOTE 2	SEE NOTE 2			

- PVL PROTECTIVE VEHICLE LIGHT (MINIMUM GROSS WEIGHT 9,500 LBS. OR GREATER) (SEE NOTE 4)
 PVH PROTECTIVE VEHICLE HEAVY (MINIMUM GROSS WEIGHT 22,000 LBS. OR GREATER)
 TMIA TRUCK/TRAILER MOUNTED IMPACT ATTENUATOR
- NOTES
 1. THE EXPOSURE CONDITIONS ASSUME THERE IS NO POSITIVE PROTECTION PRESENT. EITHER A PROTECTIVE LIGHT (PVL) OR THE STANDARD BUFFER SPACE (SEE TABLE 011-03 SHALL BE PROVIDED.
- TRUCK/TRAILER MOUNTED IMPACT ATTENUATORS (TMIA) SHALL NOT BE MOUNTED/INSTALLED ON VEHICLES WITH A GROSS VEHICLE WEIGHT (GVW) LESS THAN WHAT IS MINIMALLY REQUIRED BY THE MANUFACTURER OF THE TMIA. THE USE OF A PROTECTIVE VEHICLE LIGHT (PVL) AS A SHADOW VEHICLE IS LIMITED TO NON-FREEWAY ROADWAYS WHERE THE POSTED SPEED LIMITS IS ≤ 40 MPH UNLESS OTHERWISE AUTHORIZED BY THE ENGINEER.

TABLE 407B-	02: ROLL AHEAD DISTANCE FO	OR PROTECTIVE VEHICLES		
ROLL	AHEAD DISTANCE (FT.)/* OF SKIP L	INES FOR VEHICLES		
PRECONSTRUCTION	STATIONARY	OPERATION		
POSTED SPEED LIMIT (MPH)	PROTECTIVE VEHICLES WEIGHING 9,500 TO 21,999 LBS. GVW	PROTECTIVE VEHICLES WEIGHING 22,000 LBS. OR GREATER GVW		
45 - 55	160/4	120/3		
≤ 40	120/3	80/2		

- 2. WHEN A SIDE ROAD OR DRIVEWAY INTERSECTS THE ROADWAY WITHIN A WORK ZONE TRAFFIC CONTROL AREA, ADDITIONAL TEMPORARY TRAFFIC CONTROL DEVICES AND/OR FLAGGERS SHALL BE PLACED AS NEEDED. ADDITIONAL FLAGGERS SHALL BE LOCATED AT ALL INTERSECTIONS AND COMMERCIAL DRIVEWAYS LOCATED WITHIN OR NEAR THE ACTIVE WORK SPACE. NO WORK ACTIVITY, EQUIPMENT, OR STORAGE OF VEHICLES, OR MATERIAL SHALL OCCUR WITHIN THE BUFFER SPACE AT ANY TIME.
- 3. CHANNELIZING DEVICE SPACING (CENTER TO CENTER) SHALL NOT EXCEED 20' IN THE ACTIVE WORK SPACE.
- CHANNELIZING DEVICES SHALL BE PLACED TRANSVERSELY A MINIMUM OF EVERY 800' AS SHOWN WHEN A PAVED SHOULDER HAVING A WIDTH OF 8' OR GREATER IS CLOSED FOR A DISTANCE GREATER THAN 800'.
- IF THE TRAFFIC IS EXPECTED TO QUEUE PAST THE W20-4 SIGN, A W3-4 SIGN SHOULD BE ADDED HALFWAY BETWEEN THE W20-4 AND W20-1 SIGNS.
- 6. IF CONDITION WARRANTS, PROTECTIVE VEHICLE WITH APPROPRIATE ROLL AHEAD DISTANCE MAY BE USED IN ADVANCE OF THE WORK AREA. TO USE PROTECTIVE VEHICLE, BUFFER SPACE SHALL BE PROVIDED ACCORDINGLY, AND THE WHEELS SHALL BE ALIGNED WITH THE LANE STRIPING.
- 7. FLAGGER SIGN (W20-7a) AND ONE LANE ROAD AHEAD SIGN (W20-4) SHALL BE REMOVED, COVERED OR TURNED AWAY FROM ROAD USERS WHEN FLAGGING OPERATIONS ARE NOT OCCURRING.
- 8. ALL FLAGGERS SHALL USE 24" (MIN.) OCTAGON SHAPED STOP/SLOW PADDLES HAVING 6' STAFF. THE PADDLE IS THE PREFERRED DEVICE, BUT THE FLAG MAY BE USED AT INTERSECTIONS WHERE THE STOP/SLOW PADDLE WOULD OFFER CONTRADICTING INFORMATION TO DRIVERS TRAVELING IN OPPOSITE DIRECTIONS/LEGS OF THE INTERSECTION OR DURING INCIDENT MANAGEMENT SITUATIONS.
- CENTERLINE CONES MAY BE ADDED TO ENHANCE THE VISIBILITY OF THE FLAGGER STATION. IF CONES ARE USED, PLACE THEM 100 FT. (MINIMUM) FROM FLAGGER.
- 10. THE NY9-11 SIGN IS RECOMMENDED. WHEN USED, IT SHALL BE PLACED IN ADVANCE OF THE FIRST ADVANCE WARNING SIGN. THE PLACEMENT DISTANCE SHALL BE 1000' FOR POSTED SPEED LIMITS OF 45 MPH OR HIGHER, AND 300' 500' FOR POSTED SPEED LIMITS OF LESS THAN 45 MPH.

NOTES FOR NIGHTTIME OPERATIONS:

- N1. WORK OCCURRING AFTER SUNSET AND BEFORE SUNRISE WILL BE CONSIDERED NIGHTTIME OPERATIONS.
- N2. ALL SIGNS, STOP / SLOW PADDLES AND RED FLAGS USED TO WARN / ALERT / CONTROL TRAFFIC SHALL BE RETROREFLECTIVE.
- N3. ALL WORKERS INVOLVED SHALL WEAR PROTECTIVE HELMET AND NIGHTTIME APPAREL IN ACCORDANCE WITH y107-05A. HIGH VISIBILITY APPAREL AT ALL TIMES.
- N4. VEHICLES OPERATING ON THE PAVEMENT OF A CLOSED ROADWAY OR TRAVEL LANE SHALL DISPLAY ROTATING AMBER BEACONS AT ALL TIMES.
- NS. LEVEL I ILLUMINATION SHALL BE PROVIDED NEAR THE BEGINNING OF LANE CLOSURE TAPERS AND AT ROAD CLOSURES, INCLUDING THE SETUP AND REMOVAL OF THE CLOSURE TAPERS.
- NG. LEVEL II ILLUMINATION SHALL BE PROVIDED FOR FLAGGING STATIONS, ASPHALT PAVING, MILLING, AND CONCRETE PLACEMENT AND/OR REMOVAL OPERATIONS, INCLUDING BRIDGE DECKS, 50 FEET AHEAD OF AND 100 FEET BEHIND A PAVING OR MILLING MACHINE.
- N7. LEVEL III ILLUMINATION SHALL BE PROVIDED FOR PAVEMENT OR STRUCTURAL CRACK FILLING,
 JOINT REPAIR, PAVEMENT PATCHING AND REPAIRS, INSTALLATION OF SIGNAL EQUIPMENT OR OTHER
 ELECTRICAL/MECHANICAL, AND OTHER TASKS INVOLVING FINE DETAILS OR INTRICATE PARTS AND
 EQUIPMENT.
- N8. ALL LIGHTING SHALL BE DESIGNED, INSTALLED, AND OPERATED TO AVOID GLARE THAT AFFECTS TRAFFIC ON THE ROADWAY OR THAT CAUSES ANNOYANCE OR DISCOMFORT FOR RESIDENCES ADJOINING THE ROADWAY.
- N9. PRIOR TO THE START OF NIGHTTIME OPERATIONS, A WRITTEN NIGHTTIME OPERATIONS AND LIGHTING PLAN IS REQUIRED FOR APPROVAL FROM THE DOT ENGINEER.
- N10. SEE STANDARD SPECIFICATIONS y619 FOR ADDITIONAL REQUIREMENTS AND CONSIDERATIONS. N11. FLAGGERS SHALL USE A FLASHLIGHT WITH A RED GLOW CONE/RED LED BATON FOR FLAGGING IN NON-ILLUMINATED FLAGGER STATIONS DURING NIGHTTIME OPERATIONS.

	NEW YORK STATE OF OPPORTUNITY.	Department of Transportation
	U.S. CUSTOMARY STA	ANDARD SHEET
	WORK ZONE TRAF TWO-LANE TWO-W LANE CLOSURE WI INTERMEDIATE TEF (SHEET 2	AY ROADWAY TH FLAGGERS RM OPERATION OF 2)
	APPROVED APRIL 8, 2022	ISSUED UNDER EI 22-008
ERRATA 1 EFF. 09/01/23 ISSUED WITH EB 23-016	Robert Limoges ROBERT LIMOGES, P.E. DIRECTOR, OTSM	619-407

UNAUTHORIZED ALTERATION OR ADDITION TO A SURVEY OR ENGINEERING MAP BEARING A LICENSED LAND SURVEYOR OR PROFESSIONAL ENGINEER IS A VIOLATION OF SECTION 7209, SUB-DIVISION 2, OF THE NEW YORK STATE EDUCATION LAW. ONLY MAPS WITH THE LAND SURVEYOR OR PROFESSIONAL ENGINEER'S SEAL ARE GENUINE TRUE AND CORRECT COPIES OF THE LAND SURVEYOR OR PROFESSIONAL ENGINEER'S ORIGINAL WORK AND OPINION

Colliers

Engineering & Design

www.colliersengineering.com

Copyright © 2024. Colliers Engineering & Design All Rights Reserved. This drawin and all the information contained herein is authorized for use only by the party whom the services were contracted or to whom it is certified. This drawing may r be copied, reused, disclosed, distributed or relied upon for any other purpo without the express written consent of Colliers Engineering & Design




PROTECT YOURSELF ALL STATES REQUIRE NOTIFICATION OF EXCAVATORS, DESIGNERS, OR ANY PERSON PREPARING TO DISTURB THE EARTH'S

FOR STATE SPECIFIC DIRECT PHONE NUMBERS

VISIT: WWW.CALL811.COM

REV	DATE	DRAWN BY	DESCRIPTION
1	4/3/24	M.J.A.	REVISED PER NYSDOT COMMENTS RECEIVED 3/19/24
2	4/26/24	J.F.M.	REVISED PER NYSDOT 4/25/24 COMMENTS.
3	5/14/24	M.J.A.	REVISED PER NYSDOT 5/2/24 COMMENTS.
4	5/24/24	M.J.A.	REVISED TRAFFIC SIGNAL PLAN SHEETS PER NYSDOT SIGNAL GROUP 5/23/24 EMAIL COMMENTS.
5	7/1/24	M.J.A.	REVISED PER NYSDOT 7/1/24 COMMENTS.
9	8/7/24	M.J.A.	REVISED PER NYSDOT 7/31/24 COMMENTS.
7	8/15/24	RGD	REVISED PER QA/QC REVIEW
8	9/12/24	M.J.A.	REVISED PER NYSDOT 8/30/24 COMMENTS.
6	9/23/24	M.J.A.	REVISED PER NYSDOT 9/20/24 COMMENTS. FINAL SET FOR PERMITTING.
٠			

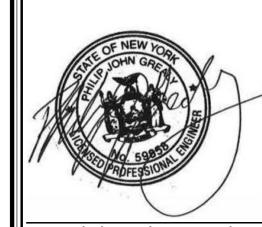

Philip John Grealy NEW YORK LICENSED PROFESSIONAL ENGINEER LICENSE NUMBER: 059858-1 COLLIERS ENGINEERING & DESIGN CT, P.C. N.Y. C.O.A #: 0017609

HIGHWAY IMPROVEMENT PLANS

FOR

UNDERHILL AVENUE **IMPROVEMENTS** (SEQR # 22-092)

NYS ROUTE 118 (S.H. 148) AT UNDERHILL AVENUE

TOWN OF YORKTOWN WESTCHESTER COUNTY **NEW YORK**

Colliers

WESTCHESTER 400 Columbus Avenue, Suite 180E Valhalla, NY 10595


Phone: 914.347.7500 Engineering COLLIERS ENGINEERING & DESIGN, ARCHITECTURE, LANDSCAPE ARCHITECTU SURVEYING CT, P.C. & Design


1/8/23 M.J.A. AS SHOWN R-PL11-WZTC 20006297A

TWO-LANE TWO-WAY ROADWAY LANE CLOSURE

WITH FLAGGERS

WZTC-07

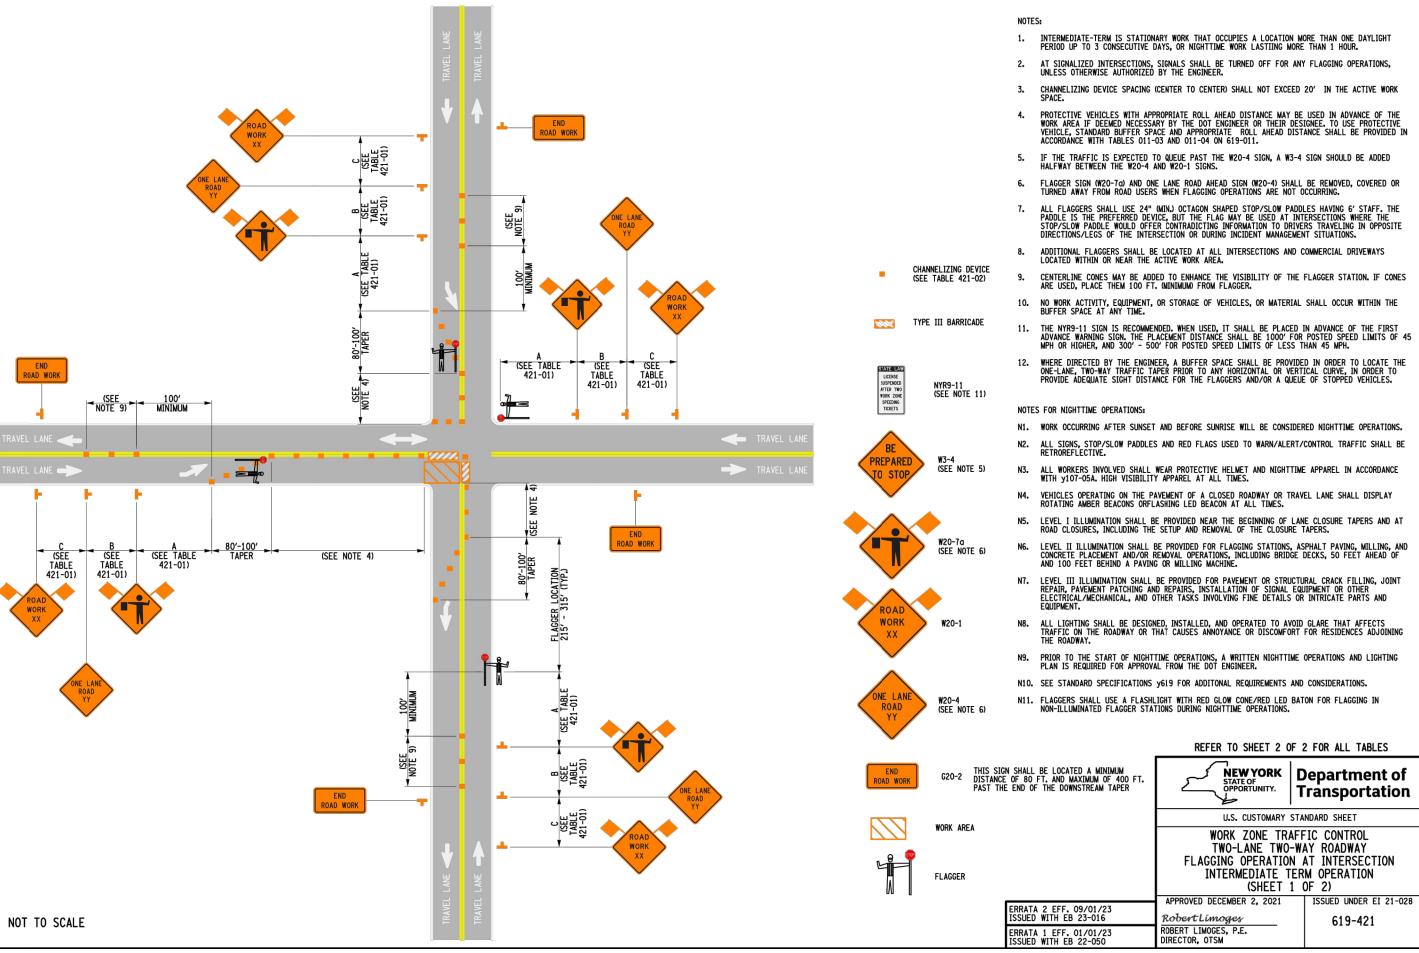

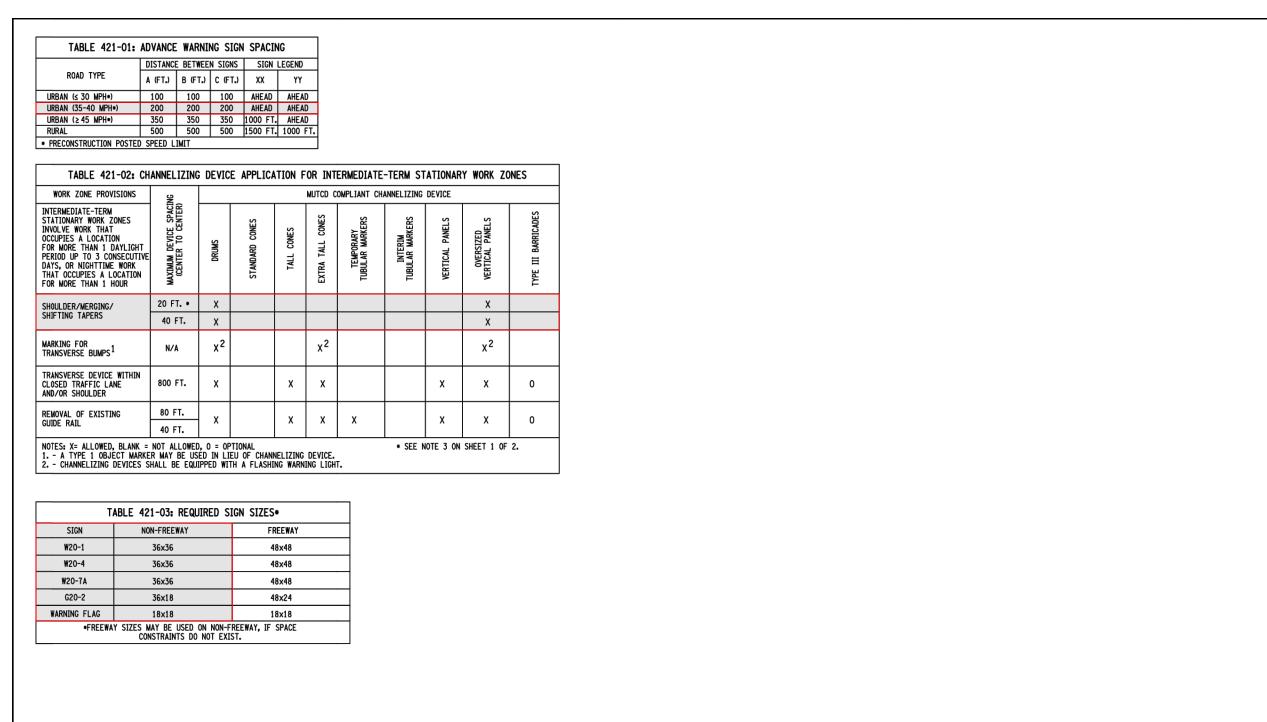

NEW YORK STATE OF OPPORTUNITY.	Department of Transportation
U.S. CUSTOMARY S	TANDARD SHEET
WORK ZONE TRA TWO-LANE TWO- FLAGGING OPERATION INTERMEDIATE TE (SHEET 2	WAY ROADWAY AT INTERSECTION ERM OPERATION
APPROVED APRIL 8, 2022 Robert Limoges ROBERT LIMOGES, P.E. DIRECTOR, OTSM	ISSUED UNDER EI 22-008 619-421

JNAUTHORIZED ALTERATION OR ADDITION TO A SURVEY OR ENGINEERING MAP BEARING A LICENSED LAND SURVEYOR OR PROFESSIONAL ENGINEER IS A VIOLATION OF SECTION 7209, SUB-DIVISION 2, OF THE NEW YORK STATE EDUCATION LAW. ONLY MAPS WITH THE LAND SURVEYOR OR PROFESSIONAL ENGINEER'S SEAL ARE GENUINE TRUE AND CORRECT COPIES OF THE LAND SURVEYOR OR PROFESSIONAL ENGINEER'S ORIGINAL WORK AND OPINION

STATE OF OPPORTUNITY. Transportation

Philip John Grealy NEW YORK LICENSED PROFESSIONAL ENGINEER LICENSE NUMBER: 059858-1 COLLIERS ENGINEERING & DESIGN CT, P.C. N.Y. C.O.A #: 0017609

Colliers

Engineering

& Design

www.colliersengineering.com

and all the information contained herein is authorized for use only by the party be copied, reused, disclosed, distributed or relied upon for any other purpo

without the express written consent of Colliers Engineering & Design

FOR STATE SPECIFIC DIRECT PHONE NUMBERS

VISIT: WWW.CALL811.COM

ALL STATES REQUIRE NOTIFICATION OF EXCAVATORS, DESIGNERS, OR ANY PERSON PREPARING TO DISTURB THE EARTH'S

SURFACE ANYWHERE IN ANY STATE

HIGHWAY IMPROVEMENT **PLANS**

FOR

UNDERHILL AVENUE **IMPROVEMENTS** (SEQR # 22-092)

NYS ROUTE 118 (S.H. 148) AT UNDERHILL AVENUE

TOWN OF YORKTOWN WESTCHESTER COUNTY NEW YORK

Colliers

400 Columbus Avenue, Suite 180E Engineering


Valhalla, NY 10595 Phone: 914.347.7500 COLLIERS ENGINEERING & DESIGN, ARCHITECTURE, LANDSCAPE ARCHITECTUR SURVEYING CT, P.C. & Design

WESTCHESTER

1/8/23 M.J.A. AS SHOWN R-PL11-WZTC 20006297A

TWO-LANE TWO-WAY ROADWAY FLAGGING OPERATION AT INTERSECTION

WZTC-08

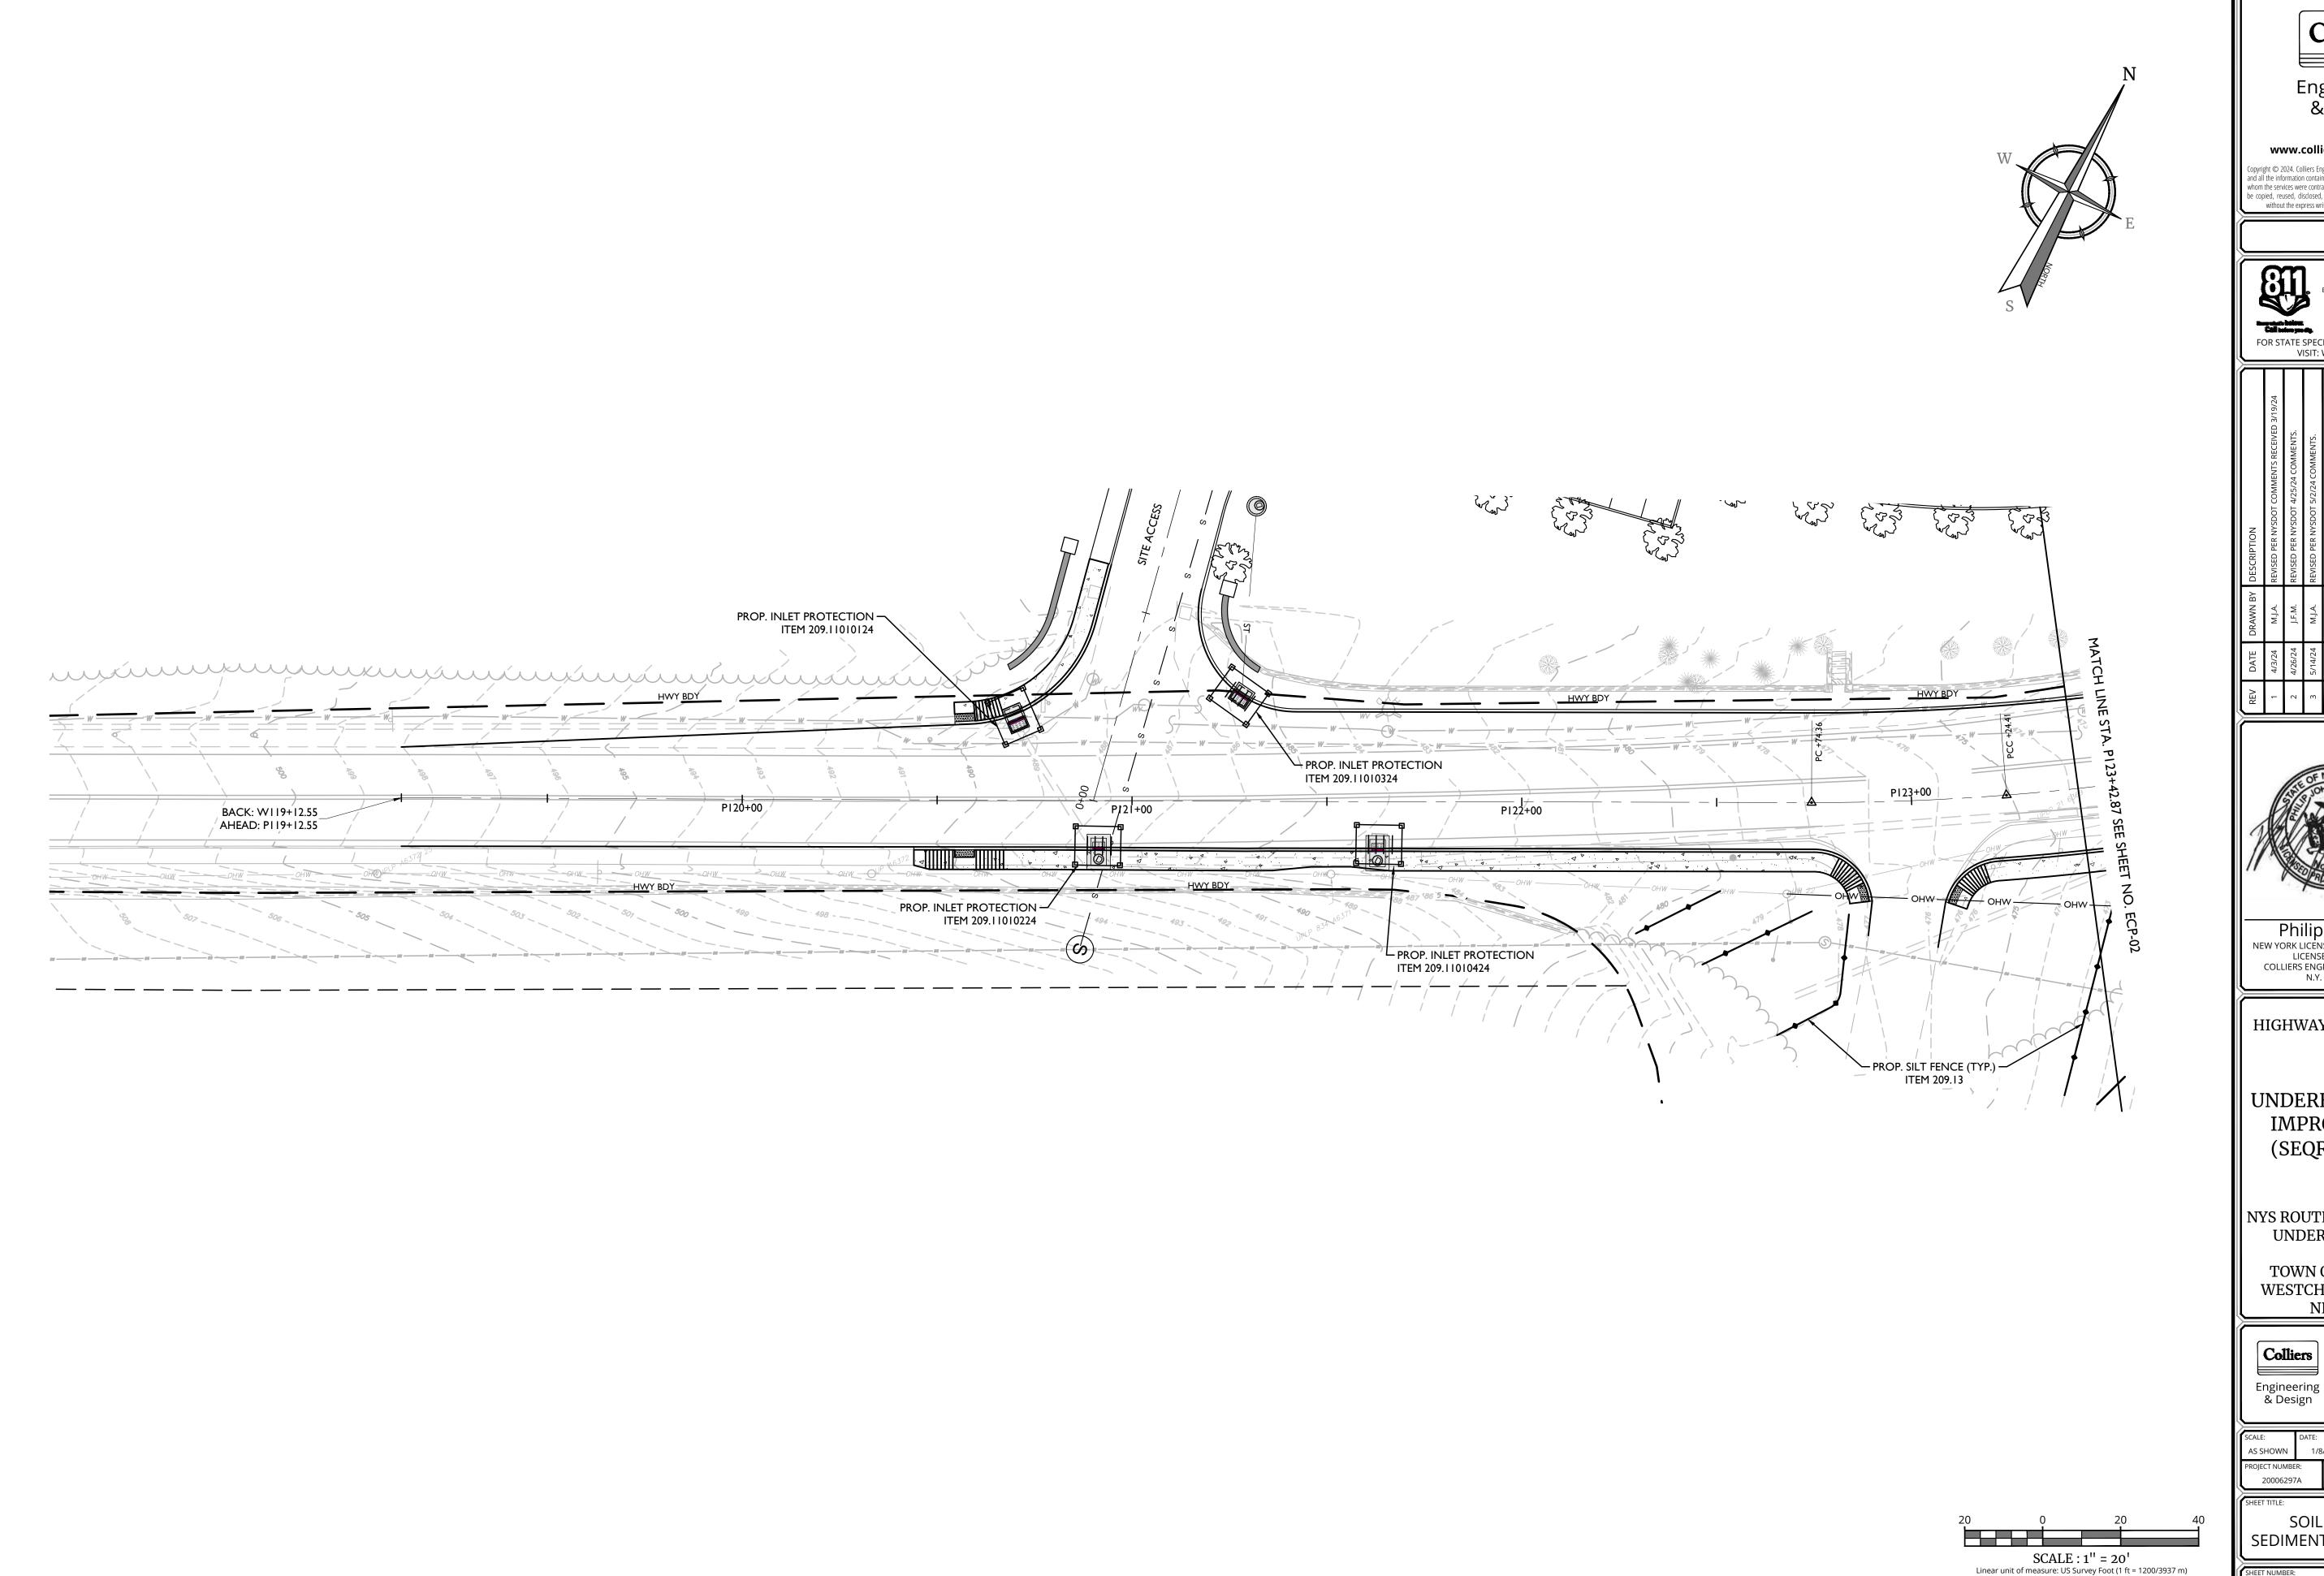

UNAUTHORIZED ALTERATION OR ADDITION TO A SURVEY OR ENGINEERING MAP BEARING A LICENSED LAND SURVEYOR OR PROFESSIONAL ENGINEER IS A VIOLATION OF SECTION 7209, SUB-DIVISION 2, OF THE NEW YORK STATE EDUCATION LAW.

ONLY MAPS WITH THE LAND SURVEYOR OR PROFESSIONAL ENGINEER'S SEAL ARE GENUINE TRUE AND CORRECT COPIES OF THE LAND SURVEYOR OR PROFESSIONAL ENGINEER'S ORIGINAL WORK AND OPINION.

Colliers

Engineering & Design

www.colliersengineering.com

be copied, reused, disclosed, distributed or relied upon for any other purp



PROTECT YOURSELF
ALL STATES REQUIRE NOTIFICATION OF EXCAVATORS, DESIGNERS, OR ANY PERSON PREPARING TO DISTURB THE EARTH'S SURFACE ANYWHERE IN ANY STATE

FOR STATE SPECIFIC DIRECT PHONE NUMBERS VISIT: WWW.CALL811.COM

۵	DATE	DRAWN BY	DRAWN BY DESCRIPTION
/4/	4/3/24	M.J.A.	REVISED PER NYSDOT COMMENTS RECEIVED 3/19/24
4/2	4/26/24	J.F.M.	REVISED PER NYSDOT 4/25/24 COMMENTS.
2/.	5/14/24	M.J.A.	REVISED PER NYSDOT 5/2/24 COMMENTS.
5/2	5/24/24	M.J.A.	REVISED TRAFFIC SIGNAL PLAN SHEETS PER NYSDOT SIGNAL GROUP 5/23/24 EMAIL COMMENTS.
//	7/1/24	M.J.A.	REVISED PER NYSDOT 7/1/24 COMMENTS.
××	8/7/24	M.J.A.	REVISED PER NYSDOT 7/31/24 COMMENTS.
/8	8/15/24	RGD	revised per QA/QC review
6	9/12/24	M.J.A.	REVISED PER NYSDOT 8/30/24 COMMENTS.
6	9/23/24	M.J.A.	REVISED PER NYSDOT 9/20/24 COMMENTS. FINAL SET FOR PERMITTING.



Philip John Grealy
NEW YORK LICENSED PROFESSIONAL ENGINEER
LICENSE NUMBER: 059858-1 COLLIERS ENGINEERING & DESIGN CT, P.C. N.Y. C.O.A #: 0017609

HIGHWAY IMPROVEMENT **PLANS**

FOR

UNDERHILL AVENUE **IMPROVEMENTS** (SEQR # 22-092)

NYS ROUTE 118 (S.H. 148) AT UNDERHILL AVENUE

TOWN OF YORKTOWN WESTCHESTER COUNTY **NEW YORK**


Colliers

WESTCHESTER 400 Columbus Avenue, Suite 180E Valhalla, NY 10595 Phone: 914.347.7500

AS SHOWN 1/8/23 R-PL12-EROS 20006297A

SOIL EROSION & SEDIMENT CONTROL PLAN

ECP-01

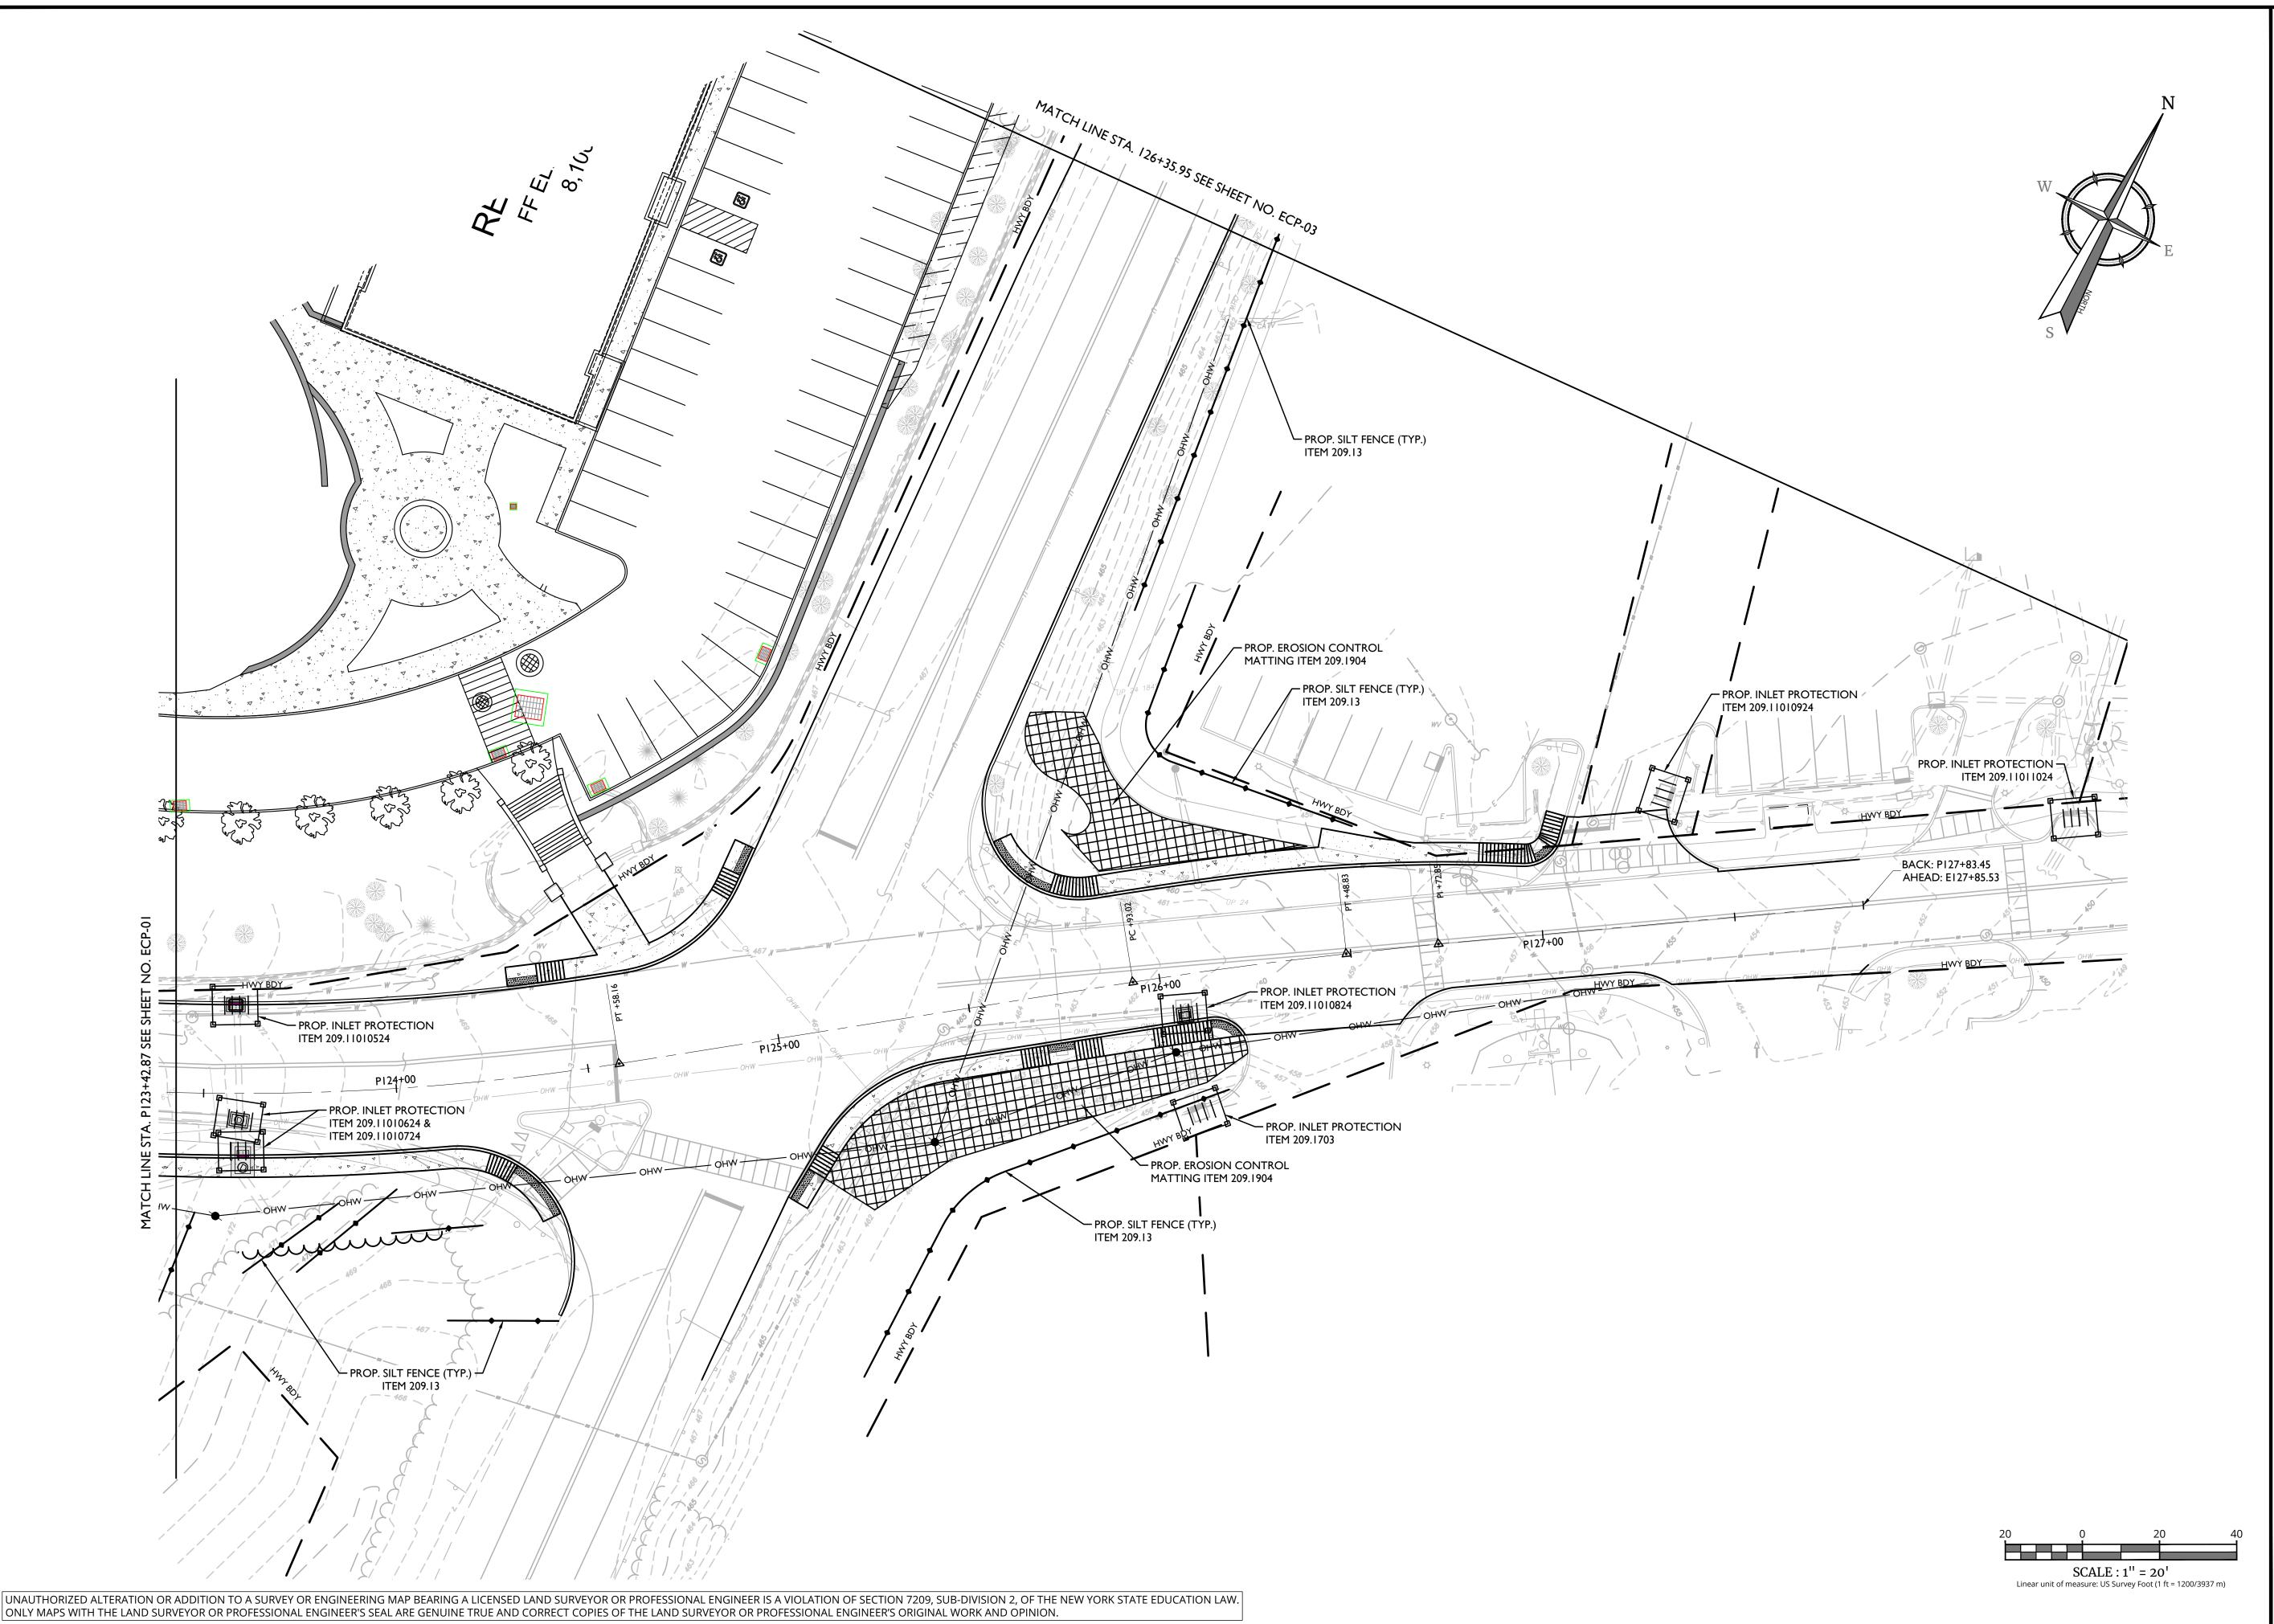

Engineering & Design

www.colliersengineering.com

Copyright © 2024. Colliers Engineering & Design All Rights Reserved. This drawi and all the information contained herein is authorized for use only by the party whom the services were contracted or to whom it is certified. This drawing may to be copied, reused, disclosed, distributed or relied upon for any other purpo without the express written consent of Colliers Engineering & Design.



PROTECT YOURSELF
ALL STATES REQUIRE NOTIFICATION OF
EXCAVATORS, DESIGNERS, OR ANY PERSON
PREPARING TO DISTURB THE EARTH'S
SURFACE ANYWHERE IN ANY STATE

longuadi.

FOR STATE SPECIFIC DIRECT PHONE NUMBERS VISIT: WWW.CALL811.COM

DRAWN BY DESCRIPTION	REVISED PER NYSDOT COMMENTS RECEIVED 3/19/24	REVISED PER NYSDOT 4/25/24 COMMENTS.	REVISED PER NYSDOT 5/2/24 COMMENTS.	REVISED TRAFFIC SIGNAL PLAN SHEETS PER NYSDOT SIGNAL GROUP 5/23/24 EMAIL COMMENTS.	REVISED PER NYSDOT 7/1/24 COMMENTS.	REVISED PER NYSDOT 7/31/24 COMMENTS.	REVISED PER QA/QC REVIEW	REVISED PER NYSDOT 8/30/24 COMMENTS.	REVISED PER NYSDOT 9/20/24 COMMENTS. FINAL SET FOR PERMITTING.	
DRAWN BY	M.J.A.	J.F.M.	M.J.A.	M.J.A.	M.J.A.	M.J.A.	RGD	M.J.A.	M.J.A.	
DATE	4/3/24	4/26/24	5/14/24	5/24/24	7/1/24	8/7/24	8/15/24	9/12/24	9/23/24	
REV	1	2	3	4	5	9	7	8	6	



Philip John Grealy
NEW YORK LICENSED PROFESSIONAL ENGINEER
LICENSE NUMBER: 059858-1
COLLIERS ENGINEERING & DESIGN CT, P.C.
N.Y. C.O.A #: 0017609

HIGHWAY IMPROVEMENT PLANS

FOR

UNDERHILL AVENUE IMPROVEMENTS (SEQR # 22-092)

NYS ROUTE 118 (S.H. 148) AT UNDERHILL AVENUE

TOWN OF YORKTOWN WESTCHESTER COUNTY NEW YORK

Colliers

WESTCHESTER

400 Columbus Avenue,
Suite 180E
Valhalla, NY 10595

Phone: 914 347 7500

Valhalla, NY 10595

Engineering & Phone: 914.347.7500


COLLIERS ENGINEERING & DESIGN, ARCHITECTURE, LANDSCAPE ARCHITECT SURVEYING CT, P.C.


SCALE: DATE: DRAWN BY: CHECKED BY
AS SHOWN 1/8/23 M.J.A. R.G.D.

PROJECT NUMBER: DRAWING NAME:
20006297A R-PL12-EROS

SOIL EROSION &
SEDIMENT CONTROL PLAN

ECP-02

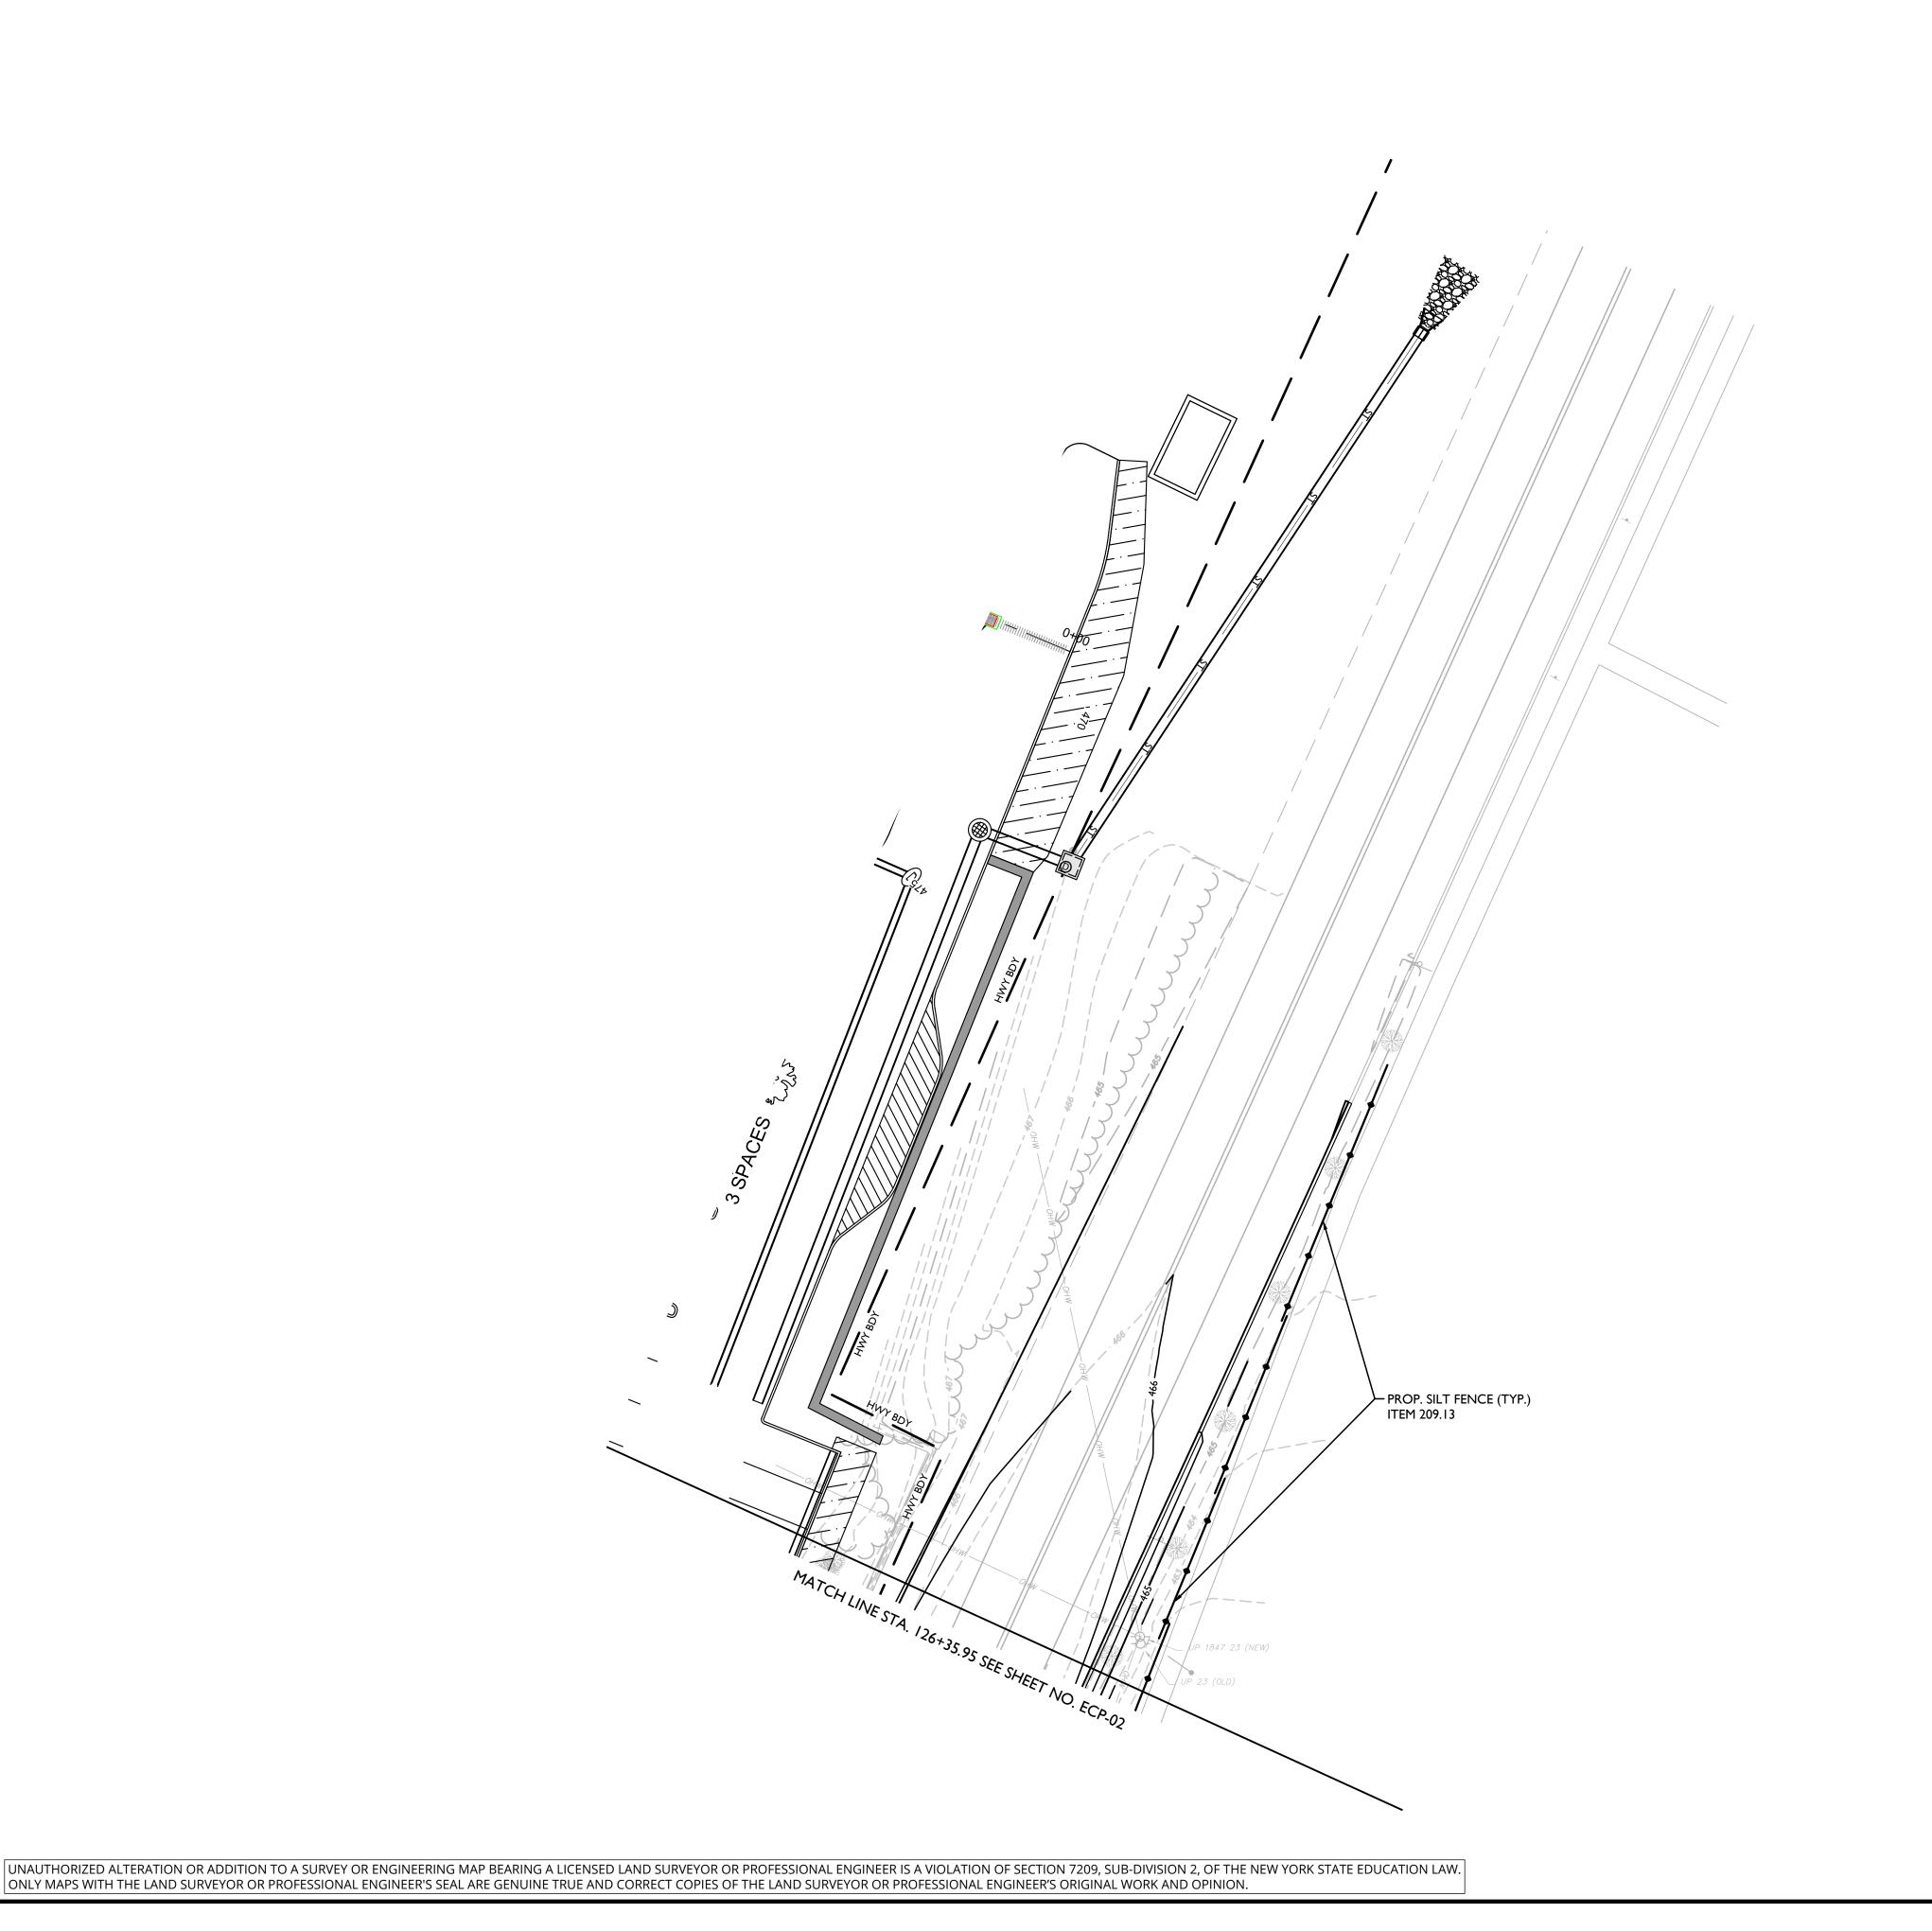

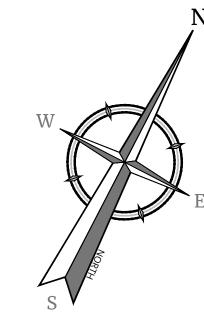

Engineering & Design

www.colliersengineering.com

e copied, reused, disclosed, distributed or relied upon for any other purp



PROTECT YOURSELF

ALL STATES REQUIRE NOTIFICATION OF EXCAVATORS, DESIGNERS, OR ANY PERSON PREPARING TO DISTURB THE EARTH'S SURFACE ANYWHERE IN ANY STATE

FOR STATE SPECIFIC DIRECT PHONE NUMBERS VISIT: WWW.CALL811.COM

REV	DATE	DRAWN BY	DRAWN BY DESCRIPTION
1	4/3/24	M.J.A.	REVISED PER NYSDOT COMMENTS RECEIVED 3/19/24
2	4/26/24	J.F.M.	REVISED PER NYSDOT 4/25/24 COMMENTS.
3	5/14/24	M.J.A.	REVISED PER NYSDOT 5/2/24 COMMENTS.
4	5/24/24	M.J.A.	REVISED TRAFFIC SIGNAL PLAN SHEETS PER NYSDOT SIGNAL GROUP 5/23/24 EMAIL COMMENTS.
2	7/1/24	M.J.A.	REVISED PER NYSDOT 7/1/24 COMMENTS.
9	8/7/24	M.J.A.	REVISED PER NYSDOT 7/31/24 COMMENTS.
7	8/15/24	RGD	revised per QA/QC review
8	9/12/24	M.J.A.	REVISED PER NYSDOT 8/30/24 COMMENTS.
6	9/23/24	M.J.A.	REVISED PER NYSDOT 9/20/24 COMMENTS. FINAL SET FOR PERMITTING.
		·	



Philip John Grealy
NEW YORK LICENSED PROFESSIONAL ENGINEER
LICENSE NUMBER: 059858-1
COLLIERS ENGINEERING & DESIGN CT, P.C.
N.Y. C.O.A #: 0017609

HIGHWAY IMPROVEMENT **PLANS**

FOR

UNDERHILL AVENUE **IMPROVEMENTS** (SEQR # 22-092)

NYS ROUTE 118 (S.H. 148) AT UNDERHILL AVENUE

TOWN OF YORKTOWN WESTCHESTER COUNTY **NEW YORK**

Colliers

WESTCHESTER 400 Columbus Avenue, Suite 180E Valhalla, NY 10595

Engineering & Design Phone: 914.347.7500

AS SHOWN 1/8/23 R-PL12-EROS 20006297A

SOIL EROSION & SEDIMENT CONTROL PLAN

SCALE: 1" = 20 Linear unit of measure: US Survey Foot (1 ft = 1200/3937 m)

ECP-03

EXPOSED SOIL CRITERIA (FOR TEMPORARILY EXPOSED SOIL AREAS)

<u>CRITERIA</u>	REQUIRED ACTION
PRIOR TO ANY ANTICIPATED PRECIPITATION OR AOBE	TEMPORARY MULCH (ITEM 209.100101)
NO WORK ON EXPOSED SOIL AREA(S) FOR 7 OR MORE CONSECUTIVE DAYS	ITEM 209.2103, SOIL STABILIZER, CLASS IV, TYPE C
NO WORK ON EXPOSED SOIL AREA(S) FOR 14 OR MORE CONSECUTIVE DAYS	ROUGHEN SURFACE (TRACK) OF BARE SOIL ON SLOPES 3:1 OR STEEPER PRIOR TO OTHER REQUIRED ACTIONS. TEMPORARY SEED & MULCH (ITEM 209.1003), AND SOIL STABILIZER, CLASS IV, TYPE C, ITEM 209.2103 (ITEM 209.2103 MAY BE USED IN LIEU OF MULCH UNDER ITEM 209.1003) OR PERMANENT STABILIZATION - PLACEMENT OF TOPSOIL (ITEM AS SHOWN ON THE PLANS), AND TURF ESTABLISHMENT (ITEM AS SHOWN ON THE PLANS), AND 209 ITEMS AS SHOWN ON THE TYPICAL SECTIONS.

. ALL AREAS SHALL BE BROUGHT TO FINAL GRADE AND TRIMMED AS SOON AS POSSIBLE. 2. MAINTENANCE OF MULCHED AREAS SHALL INCLUDE RE-MULCHING OF AREAS IN WHICH SOIL BECOMES EXPOSED TO VIEW. ANY AREAS

NO ADDITIONAL PAYMENT FOR MAINTENANCE OF EROSION CONTROL MEASURES.

THAT BECOME SETTLED OR GULLIED DURING MULCHING OPERATIONS SHALL BE RE-GRADED. 3. MAINTENANCE OF TEMPORARY SEEDED AREAS SHALL INCLUDE RE-SEEDING AS NEEDED TO ESTABLISH A SATISFACTORY STAND OF GRASS. THERE SHALL BE NO ADDITIONAL PAYMENT FOR RESEEDING.

4. THE USE OF TEMPORARY SEED, (ITEM 209.100102), OR TEMPORARY SEED & MULCH (ITEM 209.1003), AS AN EFFECTIVE EROSION CONTROL METHOD MUST BE APPLIED PRIOR TO OCTOBER 15 AND AFTER MARCH 31. 5. DEPENDING ON WEATHER CONDITIONS WATERING MAY BE NEEDED TO ESTABLISH TEMPORARY SEED. WATERING SHALL BE APPLIED

AS SPECIFIED IN THE SUB-SECTION 610-3.10 OF THE STANDARD SPECIFICATIONS. WATER SHALL BE PAID UNDER ITEM 610.19 6. ROUGHENING THE SURFACE OF BARE SOIL INVOLVES CREATING HORIZONTAL GROOVES (TRACKING) ACROSS A SLOPE PARALLEL TO 7. ALL TEMPORARY EROSION CONTROL MEASURES SHALL BE MAINTAINED THROUGHOUT THE LIFE OF THE CONTRACT. THERE SHALL BE

TABLE OF ADDITIONAL EROSION AND SEDIMENT CONTROL ITEMS

ON PLANS

<u>ITEM</u>	DESCRIPTION	QUANTITY
209.100102	SEED - TEMPORARY	700 SY
209.11000001	GEOTEXTILE SEDIMENT COLLECTION BAG	1
209.13	SILT FENCE - TEMPORARY	250 LF
209.11010024	TEMPORARY CATCH BASIN INSERTS FOR DRAINAGE STRUCTURES - TRASH, SEDIMENT AND DEBRIS REMOVAL	2
209.1904	ROLLED EROSION CONTROL PRODUCT, CLASS II TYPE D, INTERMEDIATE	700 SY

ADDITIONAL QUANTITIES OF EROSION AND SEDIMENT CONTROL ITEMS IN ADDITION TO THE ITEMS INCLUDED IN THE PLANS ARE PROVIDED FOR USE IN AREAS IN NEED OF EROSION CONTROL THAT WERE UNFORESEEN DURING THE DESIGN OF THE PLANS. LOCATIONS SHALL BE DETERMINED BY THE ENGINEER-IN-CHARGE.

GENERAL SOIL EROSION AND SEDIMENT CONTROL NOTES

- THE CONTRACTOR WILL BE REQUIRED TO PERFORM ALL CONSTRUCTION OPERATIONS IN A MANNER SO AS TO MINIMIZE SOIL EROSION AND ENSURE SEDIMENT CONTROL. EROSION CONTROL MEASURES ARE ITEMS WHICH MINIMIZE THE EROSION OF SOIL. SEDIMENT CONTROL MEASURES ARE ITEMS WHICH KEEP SEDIMENT FROM LEAVING THE PROJECT SITE. EFFECTIVE SOIL EROSION AND SEDIMENT CONTROL CAN BE ACCOMPLISHED BY LIMITING THE AREA OF UNPROTECTED SOIL. PROTECTED IS DEFINED AS HAVING TEMPORARY OR PERMANENT SOIL EROSION AND SEDIMENT CONTROL MEASURES IN PLACE. PERIMETER SEDIMENT CONTROL MEASURES ALONE ARE NOT CONSIDERED ADEQUATE PROTECTION.
- TEMPORARY SOIL EROSION AND SEDIMENT CONTROL MEASURES SHALL BE MAINTAINED AS PER DETAILS AND SPECIFICATIONS. THE COST OF MAINTAINING AND REMOVING TEMPORARY SOIL EROSION AND SEDIMENT CONTROL MEASURES SHALL BE INCLUDED IN THE BID PRICE OF THE ITEM USED. ALL TEMPORARY SOIL EROSION AND SEDIMENT CONTROL MEASURES SHALL BE INSPECTED BY THE CONTRACTOR AT A MINIMUM ONCE EVERY SEVEN (7) CALENDAR DAYS AND AFTER EACH RAINFALL OF ONE-HALF INCH OR MORE IN A 24 HOUR PERIOD.
- PERIMETER SEDIMENT CONTROL MEASURES AND VEGETATION PROTECTION FENCE SHALL BE PLACED PRIOR TO STARTING CLEARING AND GRUBBING OPERATIONS. THESE MEASURES SHALL REMAIN IN PLACE UNTIL ALL DISTURBED AREAS ARE PERMANENTLY PROTECTED WITH EROSION
- 4. TEMPORARY STOCKPILES OF SOIL SHALL BE PROTECTED AS PER THE SOIL EROSION AND SEDIMENT CONTROL PLAN AND DETAILS. AT A MINIMUM TEMPORARY STOCKPILES SHALL BE RINGED WITH SILT FENCE. STOCKPILES AND AREA OF STOCKPILES LEFT INACTIVE FOR LONGER THAN 14 DAYS SHALL HAVE TEMPORARY MULCH, OR TEMPORARY SEED AND MULCH APPLIED, OR BE COVERED IN A MANNER THAT WILL PREVENT EROSION. ANY MEASURES USED TO COVER STOCKPILES SHALL BE SECURED TO MAINTAIN THEIR EFFECTIVENESS.
- 5. ANY ADDITIONAL SOIL EROSION AND SEDIMENT CONTROL MEASURES USED TO SUPPLEMENT THE PLANS SHALL BE PREPARED IN ACCORDANCE WITH THE TECHNICAL REQUIREMENTS CONTAINED IN THE "NEW YORK GUIDELINES FOR URBAN EROSION AND SEDIMENT CONTROL", LATEST EDITION. ADDITIONAL SOIL EROSION AND SEDIMENT CONTROL MEASURES MAY BE REQUIRED AS PER SECTION 107-12 OF THE STANDARD SPECIFICATIONS.
- 6. LOCATIONS OF SILT FENCE AS SHOWN ON THE PLANS ARE GENERAL LOCATIONS. CONTRACTOR SHALL REFER TO NYSDOT STANDARD SHEET 209-01 FOR GUIDANCE OF PROPER SILT FENCE INSTALLATION. THE ENDS OF A ROW OF SILT FENCE OR SEDIMENT FILTER LOGS SHALL BE ANGLED UP SLOPE TO PREVENT CHANNELIZED FLOW FROM BEING CONVEYED PAST THE ENDS OF THE FENCE. A SECTION OF SILT FENCE OR SEDIMENT FILTER LOGS SHOULD NOT EXCEED 100 FT. IN
- 7. THE CONTRACTOR SHALL COMPLY WITH THE PROVISIONS OF ALL ENVIRONMENTAL PERMITS
- 8. ALL NECESSARY PRECAUTIONS SHALL BE TAKEN TO PREVENT DIRECT OR INDIRECT CONTAMINATION OF ALL WATER BODIES (INCLUDING WETLANDS) BY SILT, SEDIMENT, FUELS, SOLVENTS, LUBRICANTS, EPOXY COATINGS, CONCRETE LEACHATE, SLURRY OR ANY OTHER POLLUTANT ASSOCIATED WITH CONSTRUCTION AND CONSTRUCTION PROCEDURES. DURING CONSTRUCTION, NO WET OR FRESH CONCRETE OR LEACHATE OR SLURRY SHALL BE ALLOWED TO ESCAPE DIRECTLY OR INDIRECTLY INTO ANY WATER BODIES (INCLUDING WETLANDS), NOR SHALL WASHINGS FROM CONCRETE TRUCKS, MIXERS, OR OTHER DEVICES BE ALLOWED TO ESCAPE DIRECTLY OR INDIRECTLY INTO ANY WATER BODIES (INCLUDING WETLANDS).

PLAN
EXAMPLE LAYOUT OF SILT FENCE OR SEDIMENT FILTER LOG


SECTION A-A SILT FENCE - TEMPORARY

FILL GAPS BETWEEN LOG -AND SOIL SURFACE WITH ON-SITE MATERIAL COMPACTED TO A HEIGHT OF NO MORE THAN 1/3 THE LOG DIAMETER (TYP.)

SECTION A-A SEDIMENT FILTER LOG

VARIES (SEE NOTE 10)

(SEE NOTE 2)

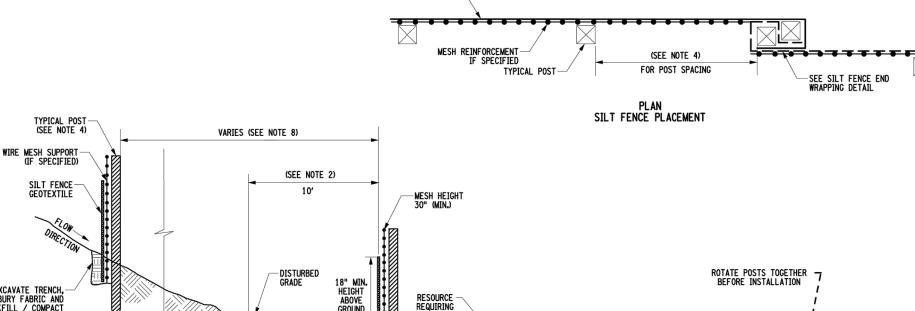

SILT FENCE END WRAPPING DETAIL

- B. IDENTIFY ONSITE AND OFFSITE RESOURCES THAT NEED TO BE PROTECTED USING THE SILT FENCE OR SEDIMENT FILTER LOG (E.G. WETLANDS, PONDS, WATERWAYS OR ENVIRONMENTALLY SENSITIVE AREAS). SILT FENCE OR SEDIMENT FILTER LOGS ARE TYPICALLY USED WITH EROSION OR SEDIMENT CONTROL MEASURES, SUCH AS MULCH AND/OR ROLLED EROSION CONTROL FABRIC.
- C. SILT FENCE OR SEDIMENT FILTER LOGS SHALL NOT BE USED IN OR ACROSS A FLOWING CHANNEL, OR AREAS OF CONCENTRATED FLOW. DO NOT USE SILT FENCE OR SEDIMENT FILTER LOGS AS A PERIMETER CONTROL, TO DEFINE PROPERTY LINES, OR TO DELINEATE A RESOURCE.
- SILT FENCE OR SEDIMENT FILTER LOGS SHALL BE INSTALLED ON A LINE OF EQUAL ELEVATION (CONTOUR). IT
 MAY BE INSTALLED AT INTERMEDIATE POINTS UP SLOPES AS WELL AS AT THE BOTTOM.
- FOR LOCATIONS THAT WARRANT PLACEMENT OF SILT FENCE OR SEDIMENT FILTER LOGS AT THE BASE OF SLOPES, SILT FENCE OR SEDIMENT FILTER LOGS SHALL BE PLACED A MINIMUM OF 10 FEET FROM THE TOE OF THE SLOPE, TO PROVIDE ADEQUATE AREA FOR SEDIMENT STORAGE AND FACILITATE MAINTENANCE OF THE SEDIMENT CONTAINMENT AREA.
- THE ENDS OF A ROW OF SILT FENCE OR SEDIMENT FILTER LOGS SHALL BE ANGLED UP SLOPE TO PREVENT CHANNELIZED FLOW FROM BEING CONVEYED PAST THE ENDS OF THE FENCE. A SECTION OF SILT FENCE OR SEDIMENT FILTER LOGS SHOULD NOT EXCEED 100 FEET IN LENGTH.
- THE BOTTOM EDGE OF SILT FENCE SHALL BE BURIED A MINIMUM OF 6" BELOW GROUND. THE FENCE SHALL BE INSTALLED WITH THE POSTS ON THE DOWNSLOPE SIDE OF THE FABRIC.

- SEDIMENT SHALL BE REMOVED WHEN ACCUMULATION REACHES ONE-HALF OF THE ABOVE GROUND HEIGHT OR WHEN BULGES DEVELOP IN THE FABRIC. SEDIMENT SHALL BE DISPOSED OF AS UNSUITABLE MATERIAL. 8. THE FOLLOWING ARE MAXIMUM SLOPE LENGTHS (DISTANCE BETWEEN ROWS) FOR SILT FENCE INSTALLATION:

SIL	T FENCE MAXIMUN	SLOPE LENGTH	(FEET)	- 500 CLODES LESS THAN EN STIT FENSE IS NOT
SLOPE	STEEPNESS	STANDARD**	REINFORCED***	• FOR SLOPES LESS THAN 5% SILT FENCE IS NOT REQUIRED UNLESS IN SENSITIVE AREAS OR HIGHLY
*5-10%	20:1 TO 10:1	125	250	ERODIBLE SOILS.
10-20%	10:1 TO 5:1	100	150	•• STANDARD SILT FENCE IS FABRIC ROLLS STAPLED TO WOODEN POSTS DRIVEN 18 INCHES INTO THE
20-33%	5:1 TO 3:1	60	80	GROUND.
33-50%	3:1 TO 2:1	40	70	*** REINFORCED SILT FENCE IS FABRIC PLACED AGAINST WELDED WIRE MESH WITH ANCHORED STEEL
> 50%	> 2:1	20	30	POSTS DRIVEN 18 INCHES INTO THE GROUND.

- INSTALLATION OF SILT FENCE OR SEDIMENT LOG, INCLUDING EXCAVATION, BACKFILL, AND COMPACTION OF SOIL SHALL BE INCLUDED IN THE UNIT PRICE BID FOR ITEM.
- 10. SEDIMENT FILTER LOG POSTS SHALL BE SPACED NO MORE THAN 10 FEET APART. ENDS OF LOGS SHALL BE OVERLAPPED BY 24 INCHES AND STAKED SIDE BY SIDE. THE MAXIMUM SLOPE LENGTH (DISTANCE BETWEEN ROWS) SHALL NOT EXCEED THE FOLLOWING LIMITS:

	,,,,,,,,,,,,,,,,,,,,,,,,,,,,,,,,,,,,,,,		022011	1110			
SEDIMENT	FILTE	R LOG	MAX S	LOPE I	ENGTH	(FEET)
DIA. (IN.)			S	LOPE	%		
DIA. (IN.)	2	5	10	20	25	33	50
12	250	225	125	65	50	40	25
18	275	250	150	70	55	45	30
24	350	275	200	130	100	60	35

Department of Transportation U.S. CUSTOMARY STANDARD SHEET LINEAR MEASURES

DEPUTY CHIEF ENGINEER (DESIGN)

/S/ RICHARD WILDER, P.E.

R-PL12-EROS 20006297A **SOIL EROSION & SEDIMENT**

ECP-03

UNAUTHORIZED ALTERATION OR ADDITION TO A SURVEY OR ENGINEERING MAP BEARING A LICENSED LAND SURVEYOR OR PROFESSIONAL ENGINEER IS A VIOLATION OF SECTION 7209, SUB-DIVISION 2, OF THE NEW YORK STATE EDUCATION LAW. ONLY MAPS WITH THE LAND SURVEYOR OR PROFESSIONAL ENGINEER'S SEAL ARE GENUINE TRUE AND CORRECT COPIES OF THE LAND SURVEYOR OR PROFESSIONAL ENGINEER'S ORIGINAL WORK AND OPINION

NOTE: DO NOT SCALE DRAWINGS FOR CONSTRUCTION.

Colliers

www.colliersengineering.com

Engineering

& Design


opyright © 2024. Colliers Engineering & Design All Rights Reserved. This draw and all the information contained herein is authorized for use only by the party whom the services were contracted or to whom it is certified. This drawing may r be copied, reused, disclosed, distributed or relied upon for any other purpo without the express written consent of Colliers Engineering & Design.



PROTECT YOURSELF ALL STATES REQUIRE NOTIFICATION O EXCAVATORS, DESIGNERS, OR ANY PERSO PREPARING TO DISTURB THE EARTH'S SURFACE ANYWHERE IN ANY STATE

FOR STATE SPECIFIC DIRECT PHONE NUMBERS

VISIT: WWW.CALL811.COM

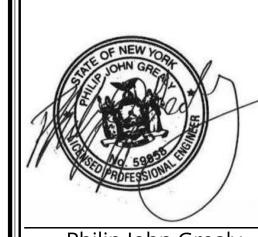

Philip John Grealy LICENSE NUMBER: 059858-1 COLLIERS ENGINEERING & DESIGN CT, P.C. N.Y. C.O.A #: 0017609

HIGHWAY IMPROVEMENT PLANS

UNDERHILL AVENUE **IMPROVEMENTS** (SEQR # 22-092)

NYS ROUTE 118 (S.H. 148) AT UNDERHILL AVENUE

TOWN OF YORKTOWN WESTCHESTER COUNTY **NEW YORK**

Colliers

400 Columbus Avenue, Suite 180E Valhalla, NY 10595

Phone: 914.347.7500 & Design ARCHITECTURE, LANDSCAPE ARCHITECTU SURVEYING CT, P.C.

1/8/23 **AS SHOWN**

CONTROL DETAILS